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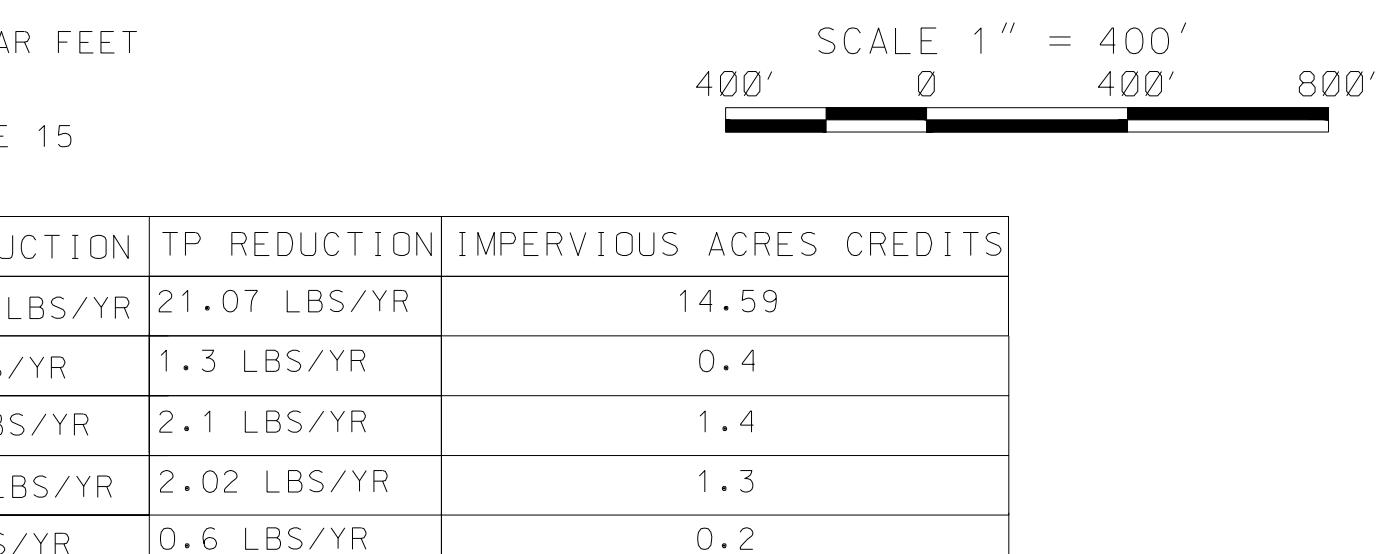
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EDGEWATER VILLAGE PARK STREAM RESTORATION

WATERSHED PROTECTION AND RESTORATION OFFICE
HARFORD COUNTY, MARYLAND
BID NO. : TBD



LOCATION MAP



TMDL NOTES:

- SEDIMENT AND NUTRIENT LOAD REDUCTIONS WERE DETERMINED IN ACCORDANCE WITH THE MDE APPROVED EXPERT PANEL DOCUMENT RECOMMENDATIONS OF THE EXPERT PANEL TO DEFINE REMOVAL RATES FOR INDIVIDUAL STREAM RESTORATION PROJECTS (BERG ET AL., 2014) AND SUPPORTING DOCUMENTS.
- SUPPORTED DOCUMENTS CONSULTED INCLUDE "CONSENSUS RECOMMENDATIONS FOR IMPROVING THE APPLICATION OF THE PREVENTED SEDIMENT PROTOCOL FOR STREAM RESTORATION PROJECTS BUILT FOR POLLUTANT REMOVAL CREDIT" DATED SEPTEMBER 2019, "CONSENSUS RECOMMENDATIONS TO IMPROVE PROTOCOLS 2 AND 3 FOR DEFINING STREAM RESTORATION POLLUTANT REMOVAL CREDITS" DATED OCTOBER 2020, AND "RECOMMENDATIONS FOR CREDITING OUTFALL AND GULLY STABILIZATION PROJECTS IN THE CHESAPEAKE BAY WATERSHED" DATED OCTOBER 2019.
- TMDL CALCULATIONS SHOWN ABOVE ARE PRELIMINARY AND INCLUDED FOR REFERENCE ONLY. FINAL LOAD REDUCTIONS WILL BE UPDATED AND RECALCULATED AS DESIGN PROGRESSES.

NOT FOR CONSTRUCTION: 100% DESIGN REVIEW

Client:	HARFORD COUNTY DEPARTMENT OF PUBLIC WORKS WATERSHED PROTECTION AND RESTORATION OFFICE 212 S. BOND STREET BEL AIR, MD 21014 410-638-3217
Prepared By :	AECOM 12420 MILESTONE CENTER DRIVE SUITE 150 GERMANTOWN, MARYLAND 20876 301-820-3000

TIER II IMPACTS
PROJECT FOOTPRINT: 2.73 ACRES
DISTURBED AREA: 2.73 ACRES
IMPACT TO 100 FOOT STREAM BUFFER: 2.47 ACRES
NET FOREST LOSS: TBD

PROFESSIONAL CERTIFICATION
I HEREBY CERTIFY THAT THESE DOCUMENTS WERE PREPARED OR APPROVED BY ME,
AND THAT I AM A DULY LICENSED PROFESSIONAL ENGINEER UNDER THE LAWS OF
THE STATE OF MARYLAND LICENSE NO. XXXXX, EXPIRATION DATE: XX/XX/XXXX.

S/C PLAN # 59914	Revisions	HARFORD COUNTY, MARYLAND	
GRA-004622-2025		EDGEWATER VILLAGE PARK STREAM RESTORATION TITLE SHEET	
SIGN AND SEAL		Drawn By : CA	AS SHOWN
		Designed By : CA	Date : SEPTEMBER 2025
		Reviewed By : BWA	
		Drawing No. GN-01 of GN-02	Sheet No. 01 of 65

GENERAL NOTES

- SPECIFICATIONS: ALL WORK IS TO BE PERFORMED IN ACCORDANCE WITH MARYLAND STATE HIGHWAY ADMINISTRATIONS STANDARD SPECIFICATIONS FOR CONSTRUCTION AND MATERIALS DATED JULY 2024 AND THE MOST RECENT REVISIONS THEREOF AND ADDITIONS THERETO.
- UTILITIES: UTILITY LOCATIONS SHOWN ON THE PLANS ARE BASED ON LIMITED INFORMATION AVAILABLE. HOWEVER, IT IS THE RESPONSIBILITY OF THE CONTRACTOR TO VERIFY THE ACCURACY OF THIS INFORMATION. THE COST OF REPAIR OR REPLACEMENT OF ANY SUCH FACILITIES DAMAGED BY THE CONTRACTOR'S OPERATIONS SHALL BE BORNE BY HIM. CONTACT "MISS UTILITY" PHONE 1-800-257-7777, 48 HOURS PRIOR TO THE START OF WORK. THERE SHOULD BE NO EXCAVATION UNTIL THE LOCATIONS OF UNDERGROUND UTILITIES HAVE BEEN DETERMINED.
- STANDARD DETAILS: REFERENCE MADE TO STANDARDS ARE TAKEN FROM THE HARFORD COUNTY "STANDARD SPECIFICATIONS AND DETAILS FOR WATER MAINS & SEWER MAINS" DATED 2014, FROM THE HARFORD COUNTY ROAD CODE "BOOK OF STANDARD DETAILS" AND FROM "THE MARYLAND STATE HIGHWAY ADMINISTRATION'S BOOK OF STANDARDS-HIGHWAY AND INCIDENTAL STRUCTURES". IT WILL BE THE CONTRACTOR'S RESPONSIBILITY THAT THE STANDARD DRAWINGS IN HIS POSSESSION ARE THE LATEST REVISED STANDARDS UP TO AND INCLUDING THE DATE OF THE ADVERTISEMENT OF THIS CONTRACT.
- RIGHT-OF-WAY LINES: RIGHT-OF-WAY LINES SHOWN ON THESE PLANS DO NOT INCLUDE EASEMENTS. THEY ARE FOR ASSISTANCE IN INTERPRETING THE PLANS ONLY. THESE LINES DO NOT REPRESENT THE OFFICIAL PROPERTY ACQUISITION LINES. FOR OFFICIAL FEE RIGHT-OF-WAY AND EASEMENT INFORMATION, SEE THE APPROPRIATE RIGHT-OF-WAY PLATS.

- SOIL CONSERVATION: THE CONTRACTOR SHALL NOT DISTURB THE EXISTING VEGETATION OUTSIDE THE LIMITS OF DISTURBANCE. IF NECESSARY, A TEMPORARY STOCKPILE SHALL BE PROVIDED WITHIN THE LIMITS OF DISTURBANCE, THE STOCKPILE SHALL BE LOCATED SUCH THAT ANY RUNOFF WILL DRAIN TO AN EXISTING SEDIMENT CONTROL DEVICE (I.E., SUPER SILT FENCE). THE STOCKPILE MAY NOT PROTRUDE UPON NOR ALTER DRAINAGE DIVIDES TO THE SEDIMENT CONTROL DEVICE AT ANY TIME. SOIL STABILIZATION WILL CONFORM TO 2011 MARYLAND STANDARDS AND SPECIFICATIONS FOR SOIL EROSION AND SEDIMENT CONTROL. THE CONTRACTOR WILL OBTAIN APPROVAL OF THE HARFORD COUNTY SOIL CONSERVATION DISTRICT FOR HIS PLANS IN CONTROLLING SEDIMENT EROSION FOR THE BORROW AREA AND DISPOSING OF ANY WASTE EXCAVATION.
- EXISTING MAILBOXES AND EXISTING SIGNS: ALL EXISTING MAILBOXES, SIGNS AND PAPER BOXES DISTURBED DURING CONSTRUCTION SHALL BE TEMPORARILY RESET IMMEDIATELY AND PERMANENTLY RESET AS DIRECTED BY THE ENGINEER. THIS WORK WILL BE INCIDENTAL TO ALL OTHER ITEMS IN THE CONTRACT.
- SURVEYS: HORIZONTAL CONTROL - COORDINATES SHOWN ON THE PLANS ARE BASED ON THE MARYLAND STATE PLANE COORDINATE SYSTEM (NAD83) IN U.S. SURVEY FEET. VERTICAL CONTROL - ELEVATIONS SHOWN ON THE PLANS ARE BASED ON NORTH AMERICAN VERTICAL DATUM OF 1988 (NAVD88) IN U.S. FEET. ONLY THOSE CONTROL POINTS SHOWN ON THESE PLANS ARE TO BE USED FOR THE CONSTRUCTION OF THIS PROJECT.

GENERAL CONSTRUCTION NOTES

PROJECT DESCRIPTION
THE HARFORD COUNTY DEPARTMENT OF PUBLIC WORKS, WATERSHED PROTECTION AND RESTORATION DIVISION OFFICE IS PURSUING THE EDGEWATER VILLAGE STREAM RESTORATION PROJECT. THE PROJECT INCLUDES 1,332 LINEAR FEET OF STREAM RESTORATION AND 245 LINEAR FEET OF SANITARY SEWER REPLACEMENT. THE GOAL OF THE PROJECT IS TO REPLACE AND STABILIZE THE EXISTING EXPOSED SANITARY SEWER LINE AND TO PROVIDE STREAM STABILIZATION AND CHANNEL RESTORATION DESIGNS THAT ARE LOW-MAINTENANCE AND COST-EFFECTIVE WHILE MINIMIZING ADVERSE ENVIRONMENTAL IMPACTS. ADDITIONALLY, THESE IMPROVEMENTS WILL SUPPORT THE COUNTY IN MEETING TOTAL MAXIMUM DAILY LOAD (TMDL) RESTORATION GOALS FOR THE CHESAPEAKE BAY WATERSHED.

EXISTING SITE CONDITIONS
THE SITE IS LOCATED IN A SUBURBAN AREA WITHIN THE UNINCORPORATED COMMUNITY OF EDGEWOOD, MARYLAND. THE AREA SURROUNDING THE PROJECT AREA INCLUDES RESIDENTIAL NEIGHBORHOODS, ATHLETIC FIELDS, OPEN SPACE, AND FORESTED BUFFERS. THE SITE IS LOCATED WITHIN THE LOWER WINTERS RUN (MDE 8 DIGIT WATERSHED NUMBER: 02130702) WATERSHED. AREAS LOCATED OUTSIDE THE LOD WILL NOT BE DISTURBED DURING CONSTRUCTION.

Critical Erosion Areas
EARLY ESTABLISHMENT AND PROPER MAINTENANCE OF PERIMETER CONTROLS WILL PROVIDE SEDIMENTATION CONTROL, STABILIZE AND MAINTAIN CUT AND FILL SLOPES THROUGHOUT PROJECT CONSTRUCTION TO CONTROL EROSION. AREAS THAT MAY HAVE HIGH EROSION POTENTIAL DURING CONSTRUCTION INCLUDE THE STREAMBANKS AND AREAS OF HIGHLY ERODIBLE SOIL. PORTIONS OF THE STREAMBANK WITH SLOPES EXCEEDING 5% LOCATED WITHIN AREAS OF HIGHLY ERODIBLE SOIL (K VALUE GREATER THAN 0.4) WILL BE CONSIDERED CRITICAL AREAS AND WILL BE TREATED WITH EROSION CONTROL MATTING TO ENSURE ADEQUATE STABILIZATION.

Adequate Channel Protection
WATERWAYS DOWNSTREAM OF THE PROJECT SITE WILL BE PROTECTED FROM SEDIMENT DEPOSITION AND INCREASES FROM VOLUME, VELOCITY AND PEAK-FLOW THROUGH USE OF SEDIMENT CONTROL MEASURES DURING CONSTRUCTION, INCLUDING SANDBAG DIKES, COFFERDAMS, PUMPS, AND FILTER BAGS.

Spatial Data
SOURCES FOR ELEVATION DATA INCLUDE THE FOLLOWING:

1) SURVEY PERFORMED BY AECOM IN MAY 2024.

2) GIS TOPOGRAPHY AVAILABLE FROM THE HARFORD COUNTY GIS DATA DOWNLOAD PORTAL.

Proposed Work

A. COMPLETE ALL PROPOSED WORK CAREFULLY TO MINIMIZE DISTURBANCE TO ADJACENT AREAS.

B. RESTORE ANY AREAS DISTURBED DURING CONSTRUCTION TO THEIR ORIGINAL OR PROPOSED CONDITION TO THE SATISFACTION OF THE OWNER AND THE ENGINEER.

C. IF WORK IS NOT AS ANTICIPATED OR INVOLVES DESIGN MODIFICATION CONSIDERATIONS, NOTIFY ENGINEER PRIOR TO PROCEEDING.

General Construction Notes:

A. THE ENGINEER USED NORMAL STANDARD OF CARE IN LOCATING, IDENTIFYING AND SURVEYING EXISTING UTILITIES. NO SPECIALIZED SUBSURFACE UTILITY ENGINEERING WAS CONDUCTED. ALL EXISTING UTILITIES FOUND DURING SURVEY ARE SHOWN ON THE PLANS. THE CONTRACTOR IS RESPONSIBLE FOR LOCATING ALL UTILITIES WITHIN THE CONSTRUCTION LIMITS AND VERIFYING THE LOCATION AND DEPTHS OF BURIED UTILITIES PRIOR TO CONSTRUCTION. IF A CONFLICT IS DISCOVERED BETWEEN THE PLANS AND THE EXISTING UTILITIES, THE CONTRACTOR IS TO NOTIFY THE ENGINEER TO ADDRESS THE CONFLICT PRIOR TO BEGINNING CONSTRUCTION.

B. CONTRACTOR SHALL PROVIDE TEMPORARY STABILIZATION OF ALL UTILITIES DURING CONSTRUCTION INCLUDING ABOVE GROUND UTILITIES SUCH AS POWER POLES.

C. VERIFY ALL FIELD CONDITIONS PRIOR TO CONSTRUCTION AND/OR DEMOLITION AND REPORT ANY DIFFERENCE IN SITE CONDITIONS FROM THE DRAWINGS TO THE ENGINEER IMMEDIATELY.

D. PROMPTLY INFORM THE ENGINEER OF ANY ERROR OR DISCREPANCY DISCOVERED IN THESE DRAWINGS OR SPECIFICATIONS OR CONFLICT BETWEEN THE DRAWINGS AND THE SPECIFICATIONS.

Demolition Notes:


A. CONTRACTOR SHALL BE RESPONSIBLE FOR CLEARING AND DEMOLITION OF ANY ELEMENTS WHICH ARE IN CONFLICT WITH PROPOSED NEW CONSTRUCTION. THIS INCLUDES BUT IS NOT LIMITED TO FENCES, TREES, DRAINAGE STRUCTURES, POLES, PAVEMENTS, VEGETATION, SIGNS AND OTHER MISCELLANEOUS SITE ELEMENTS.

B. ALL DEMOLITION DEBRIS SHALL BE DISPOSED OF OFF-SITE IN ACCORDANCE WITH ALL LOCAL, STATE, AND FEDERAL REGULATIONS AND SPECIFICATIONS, LATEST REVISION.


C. CONTRACTOR SHALL STRIP TOPSOIL AND STOCKPILE IT FOR LATER USE.

D. EXISTING UTILITIES SUCH AS WATER, SEWER, GAS, ELECTRICAL, FIBER, CABLE, ETC. MAY BE PRESENT IN THE AREA. THE EXACT LOCATION OF ALL UNDERGROUND UTILITIES SHOULD BE VERIFIED PRIOR TO CONSTRUCTION. ANY AND ALL DAMAGES RESULTING FROM THE FAILURE TO DO SO SHALL BE REPAIRED AT NO EXPENSE TO THE OWNER. CONTACT ANY APPLICABLE LOCAL AND REGIONAL UTILITIES COMPANIES AT LEAST 48 HOURS PRIOR TO COMMENCING CONSTRUCTION.

LEGEND

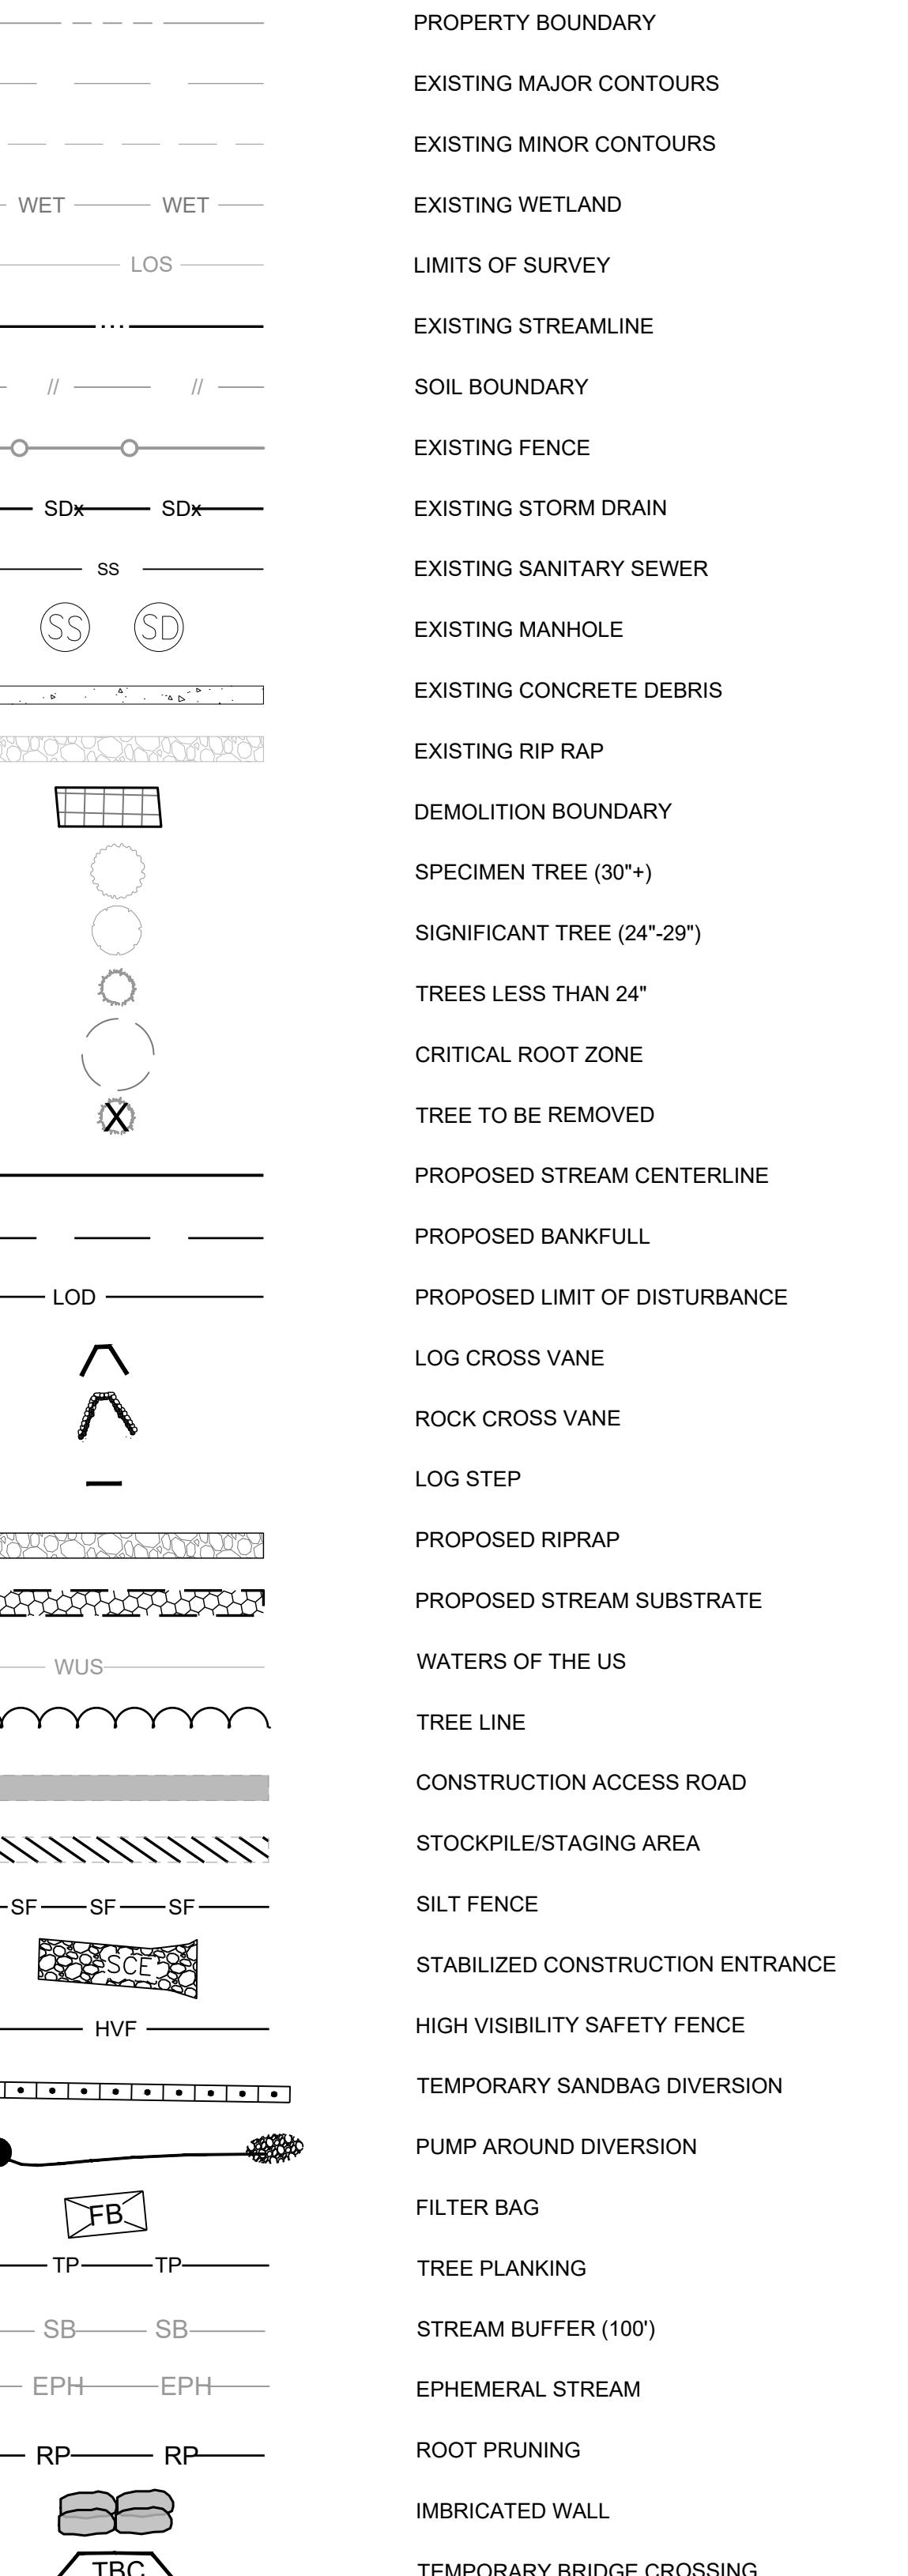

S/C PLAN # 59914	Revisions
GRA-004622-2025	SIGN AND SEAL
PROFESSIONAL CERTIFICATION	
I HEREBY CERTIFY THAT THESE DOCUMENTS WERE PREPARED OR APPROVED BY ME, AND THAT I AM A DULY LICENSED PROFESSIONAL ENGINEER UNDER THE LAWS OF THE STATE OF MARYLAND. LICENSE NO. XXXXX, EXPIRATION DATE: XX/XX/XXXX.	
Drawn By : _____ CA	Scale : _____ NTS
Designed By : _____ CA	Date : SEPTEMBER 2025
Reviewed By : _____ BWA	
Drawing No. GN-02 of GN-02	
Sheet No. 02 of 65	

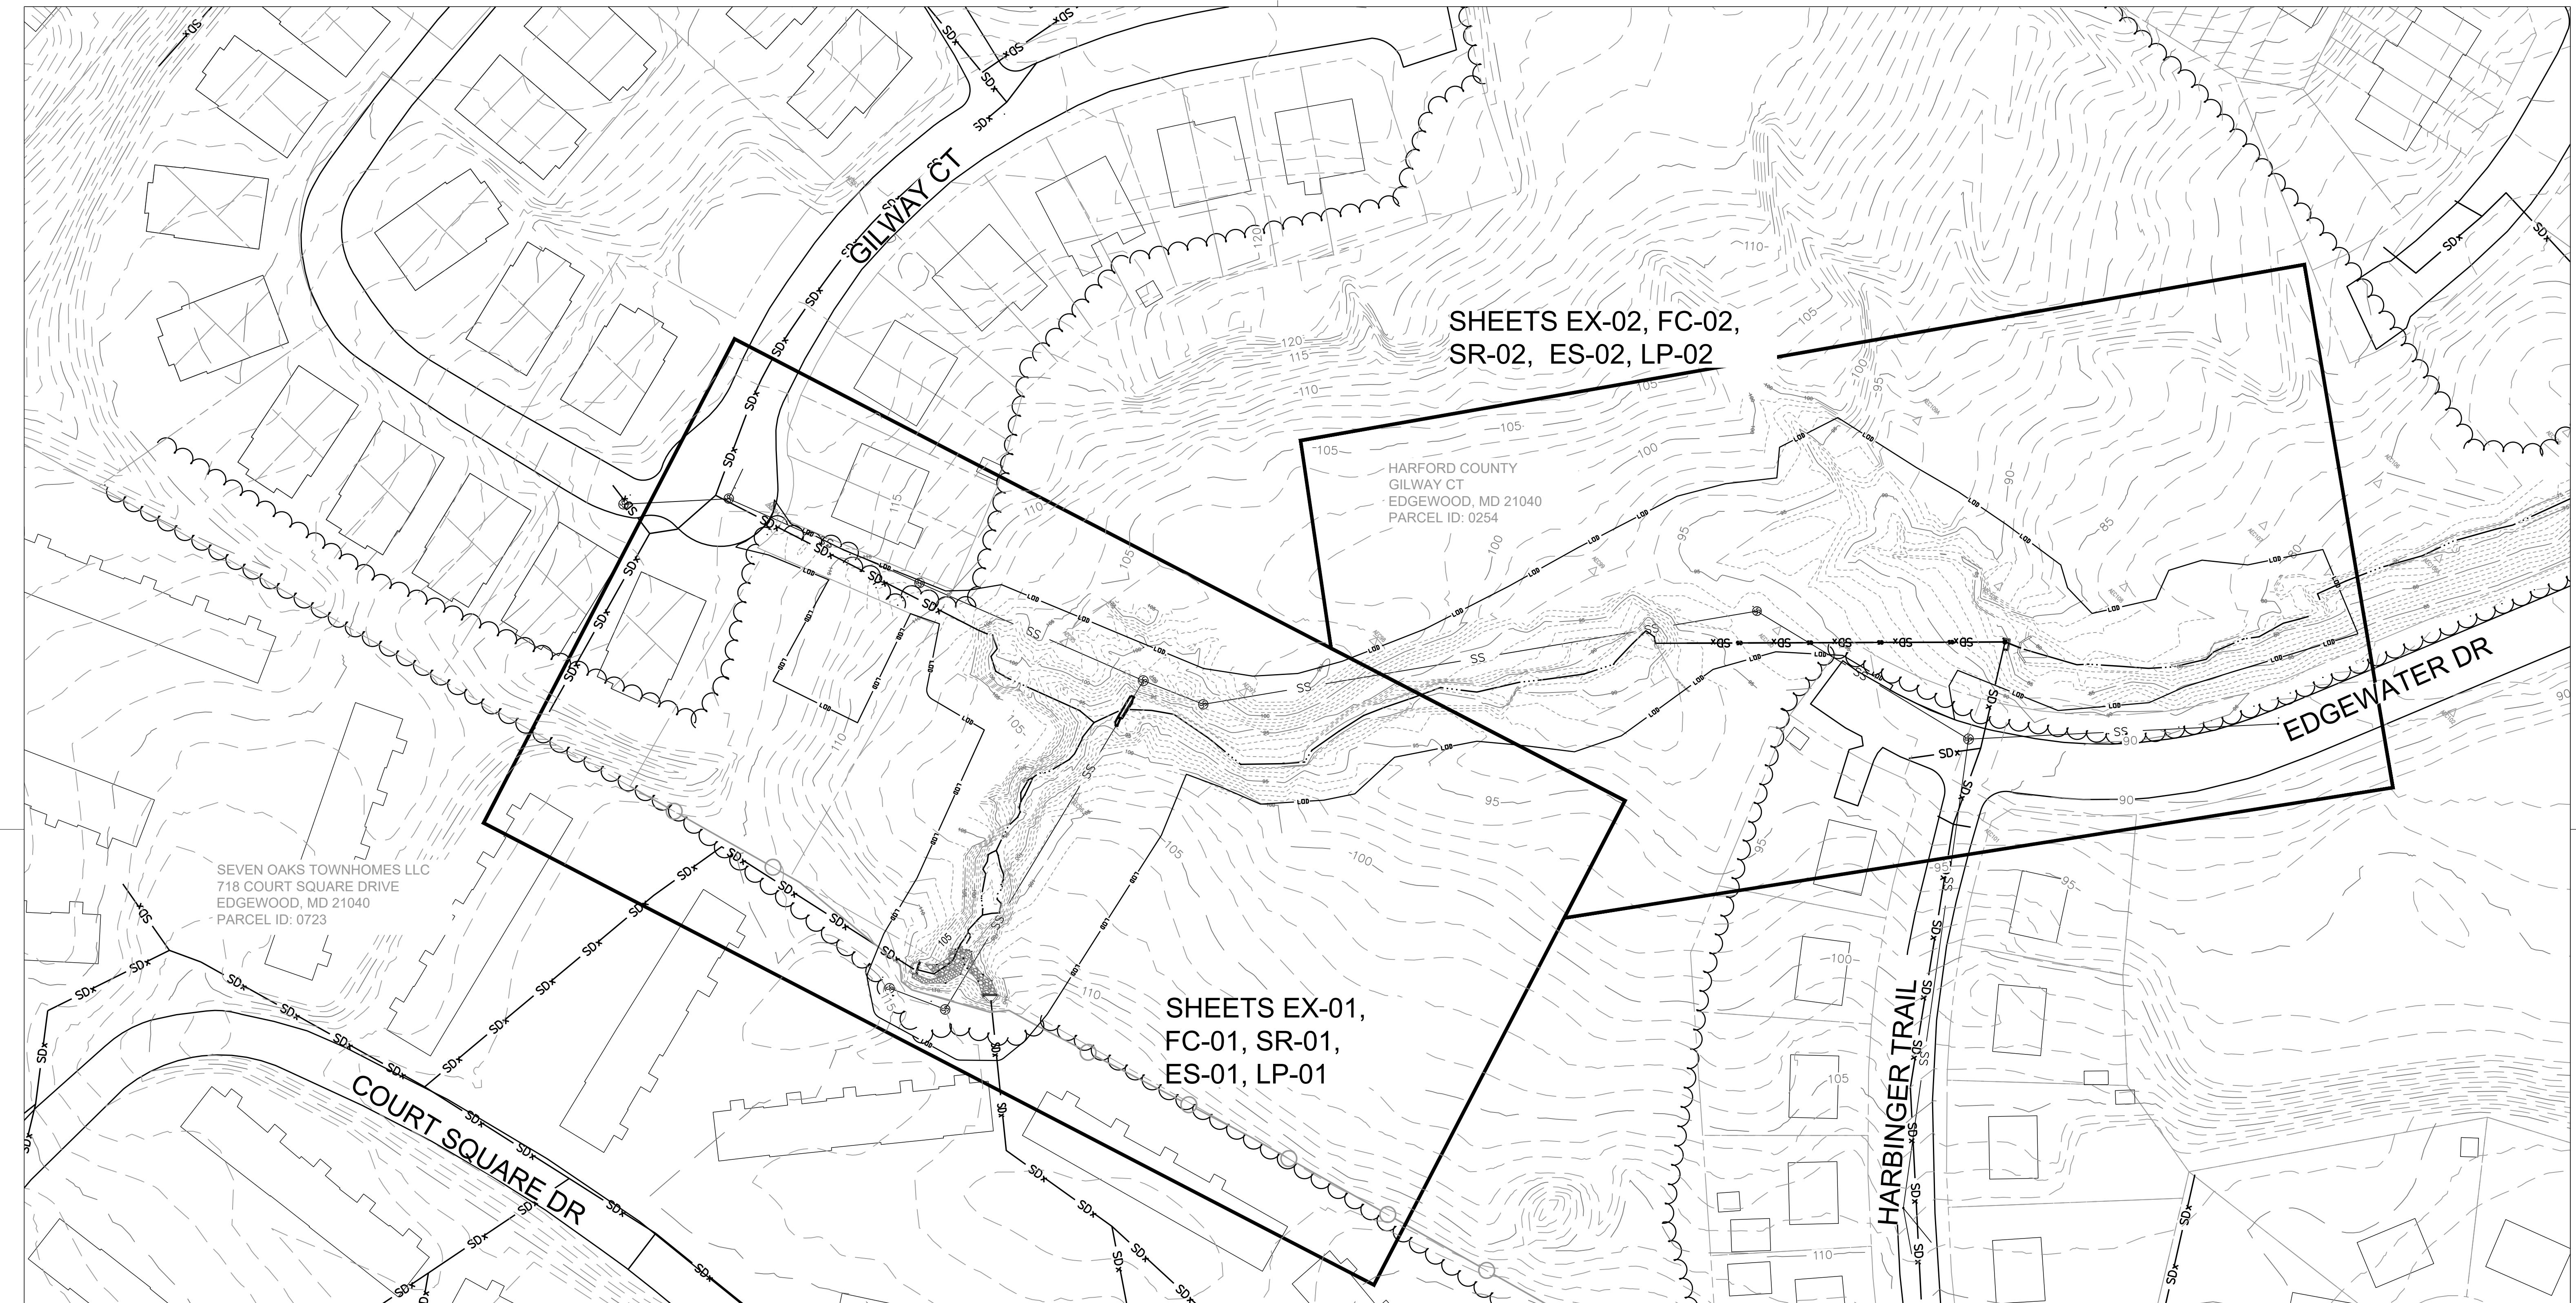

HARFORD COUNTY, MARYLAND	
EDGEWATER VILLAGE PARK	
STREAM RESTORATION	
SITE PLAN	
S/C PLAN # 59914	
GRA-004622-2025	
SIGN AND SEAL	
Drawn By : <u>CA</u>	Revisions
Designed By : <u>CA</u>	
Reviewed By : <u>BWA</u>	
Drawing No. SP-01 of SP-01	
Sheet No. 03 of 65	

PROFESSIONAL CERTIFICATION

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BID No.: _____

HCG DWG ID No.: _____

SCALE : 1 inch

MATCHLINE SEE
SHEET EX-02

GILWAY CT

BURRIS BERNADETTE
811 GILWAY COURT
EDGEWOOD, MD 21040
PARCEL ID: 0998

SSMH-07
TOP=115.03'
INV IN ELEV=101.28'
INV OUT ELEV=101.13'
N:641809.3026
E:1504701.1588


HARRIS TANIA
809 GILWAY COURT
EDGEWOOD, MD 21040
PARCEL ID: 0998

HARFORD COUNTY
DRAINAGE AND
UTILITY EASEMENT
PARCEL ID: 0998

DEMOLISH AND REMOVE EXPOSED SEWER ENCASEMENT
REFER TO EDGEWATER VILLAGE SEWER REPLACEMENT
PLANS FOR DETAILS

DEMOLISH AND REMOVE
CONCRETE DEBRIS

48" RCP INV
ELEV 101.36

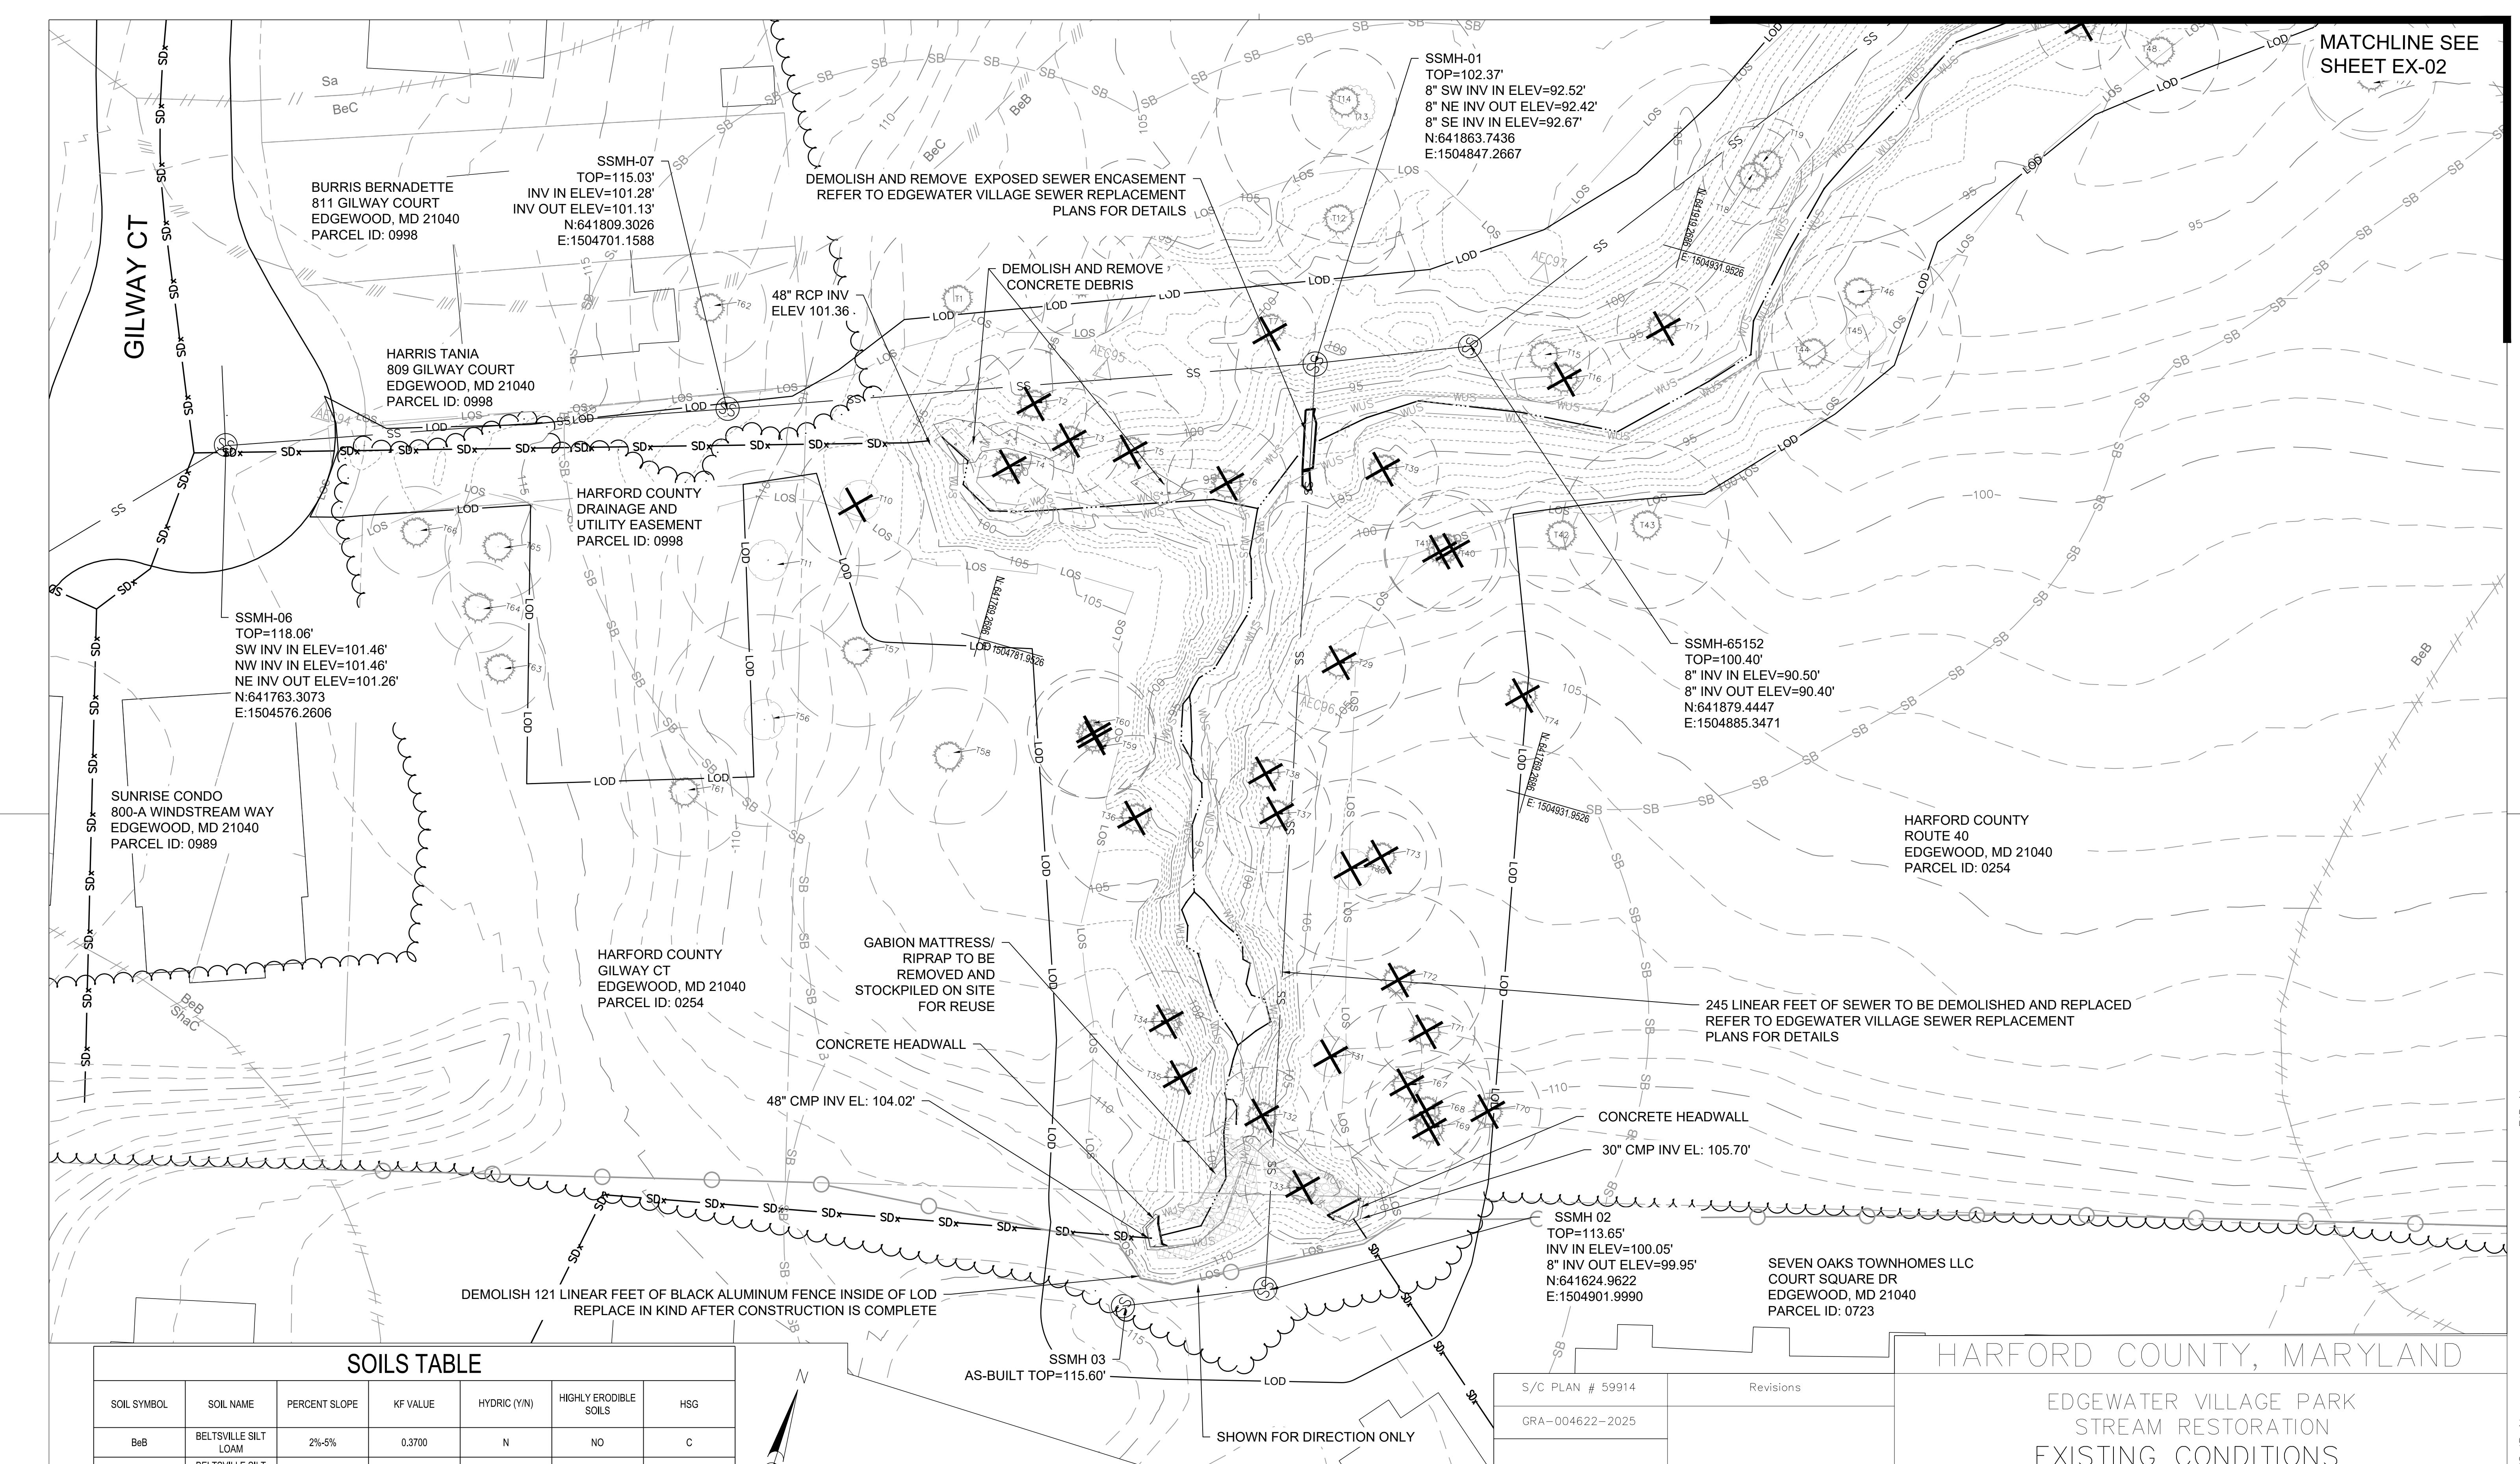

SOILS TABLE

SOIL SYMBOL	SOIL NAME	PERCENT SLOPE	KF VALUE	HYDRIC (Y/N)	HIGHLY ERODIBLE SOILS	HSG
BeB	BELTSVILLE SILT LOAM	2%-5%	0.3700	N	NO	C
BeC	BELTSVILLE SILT LOAM	5%-10%	0.4300	N	YES	C
Sa	SAND AND GRAVEL PITS	N/A	N/A	N/A	N/A	N/A

20 0 20 40
SCALE IN FEET 1" = 20'

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THE STATE OF MARYLAND, LICENSE NO. XXXXX, EXPIRATION DATE: XX/XX/XXXX.

S/C PLAN # 59914	Revisions
GRA-004622-2025	
SIGN AND SEAL	

HARFORD COUNTY, MARYLAND
EDGEWATER VILLAGE PARK
STREAM RESTORATION
EXISTING CONDITIONS

Drawn By : CA
Designed By : CA
Reviewed By : BWA
Drawing No. EX-01 of EX-02
Sheet No. 04 of 65
Scale : 1" = 20'
Date : SEPTEMBER 2025
HGC DWG ID No. :
SCALE : 1 inch

HARFORD COUNTY
ROUTE 40
EDGEWOOD, MD 21040
PARCEL ID: 0254

SSMH-65153 TOP=98.29'
SW 8" INV IN ELEV=80.34'
NE 8" INV OUT ELEV=80.30'
N:642167.5153
E:1505098.0555


REFER TO EDGEWATER VILLAGE SEWER REPLACEMENT PLANS FOR MANHOLE MODIFICATIONS

MATCHLINE SEE SHEET EX-01


DEMOLISH AND REMOVE 20 LF OF STORM DRAIN
60' RCP INV EL=85.69'

TOP=86.59'
MANHOLE LID IS
WELDED SHUT

BROWN JAMES A JR
1701 HARBINGER TRAIL
EDGEWOOD, MD 21040
PARCEL ID: 0961

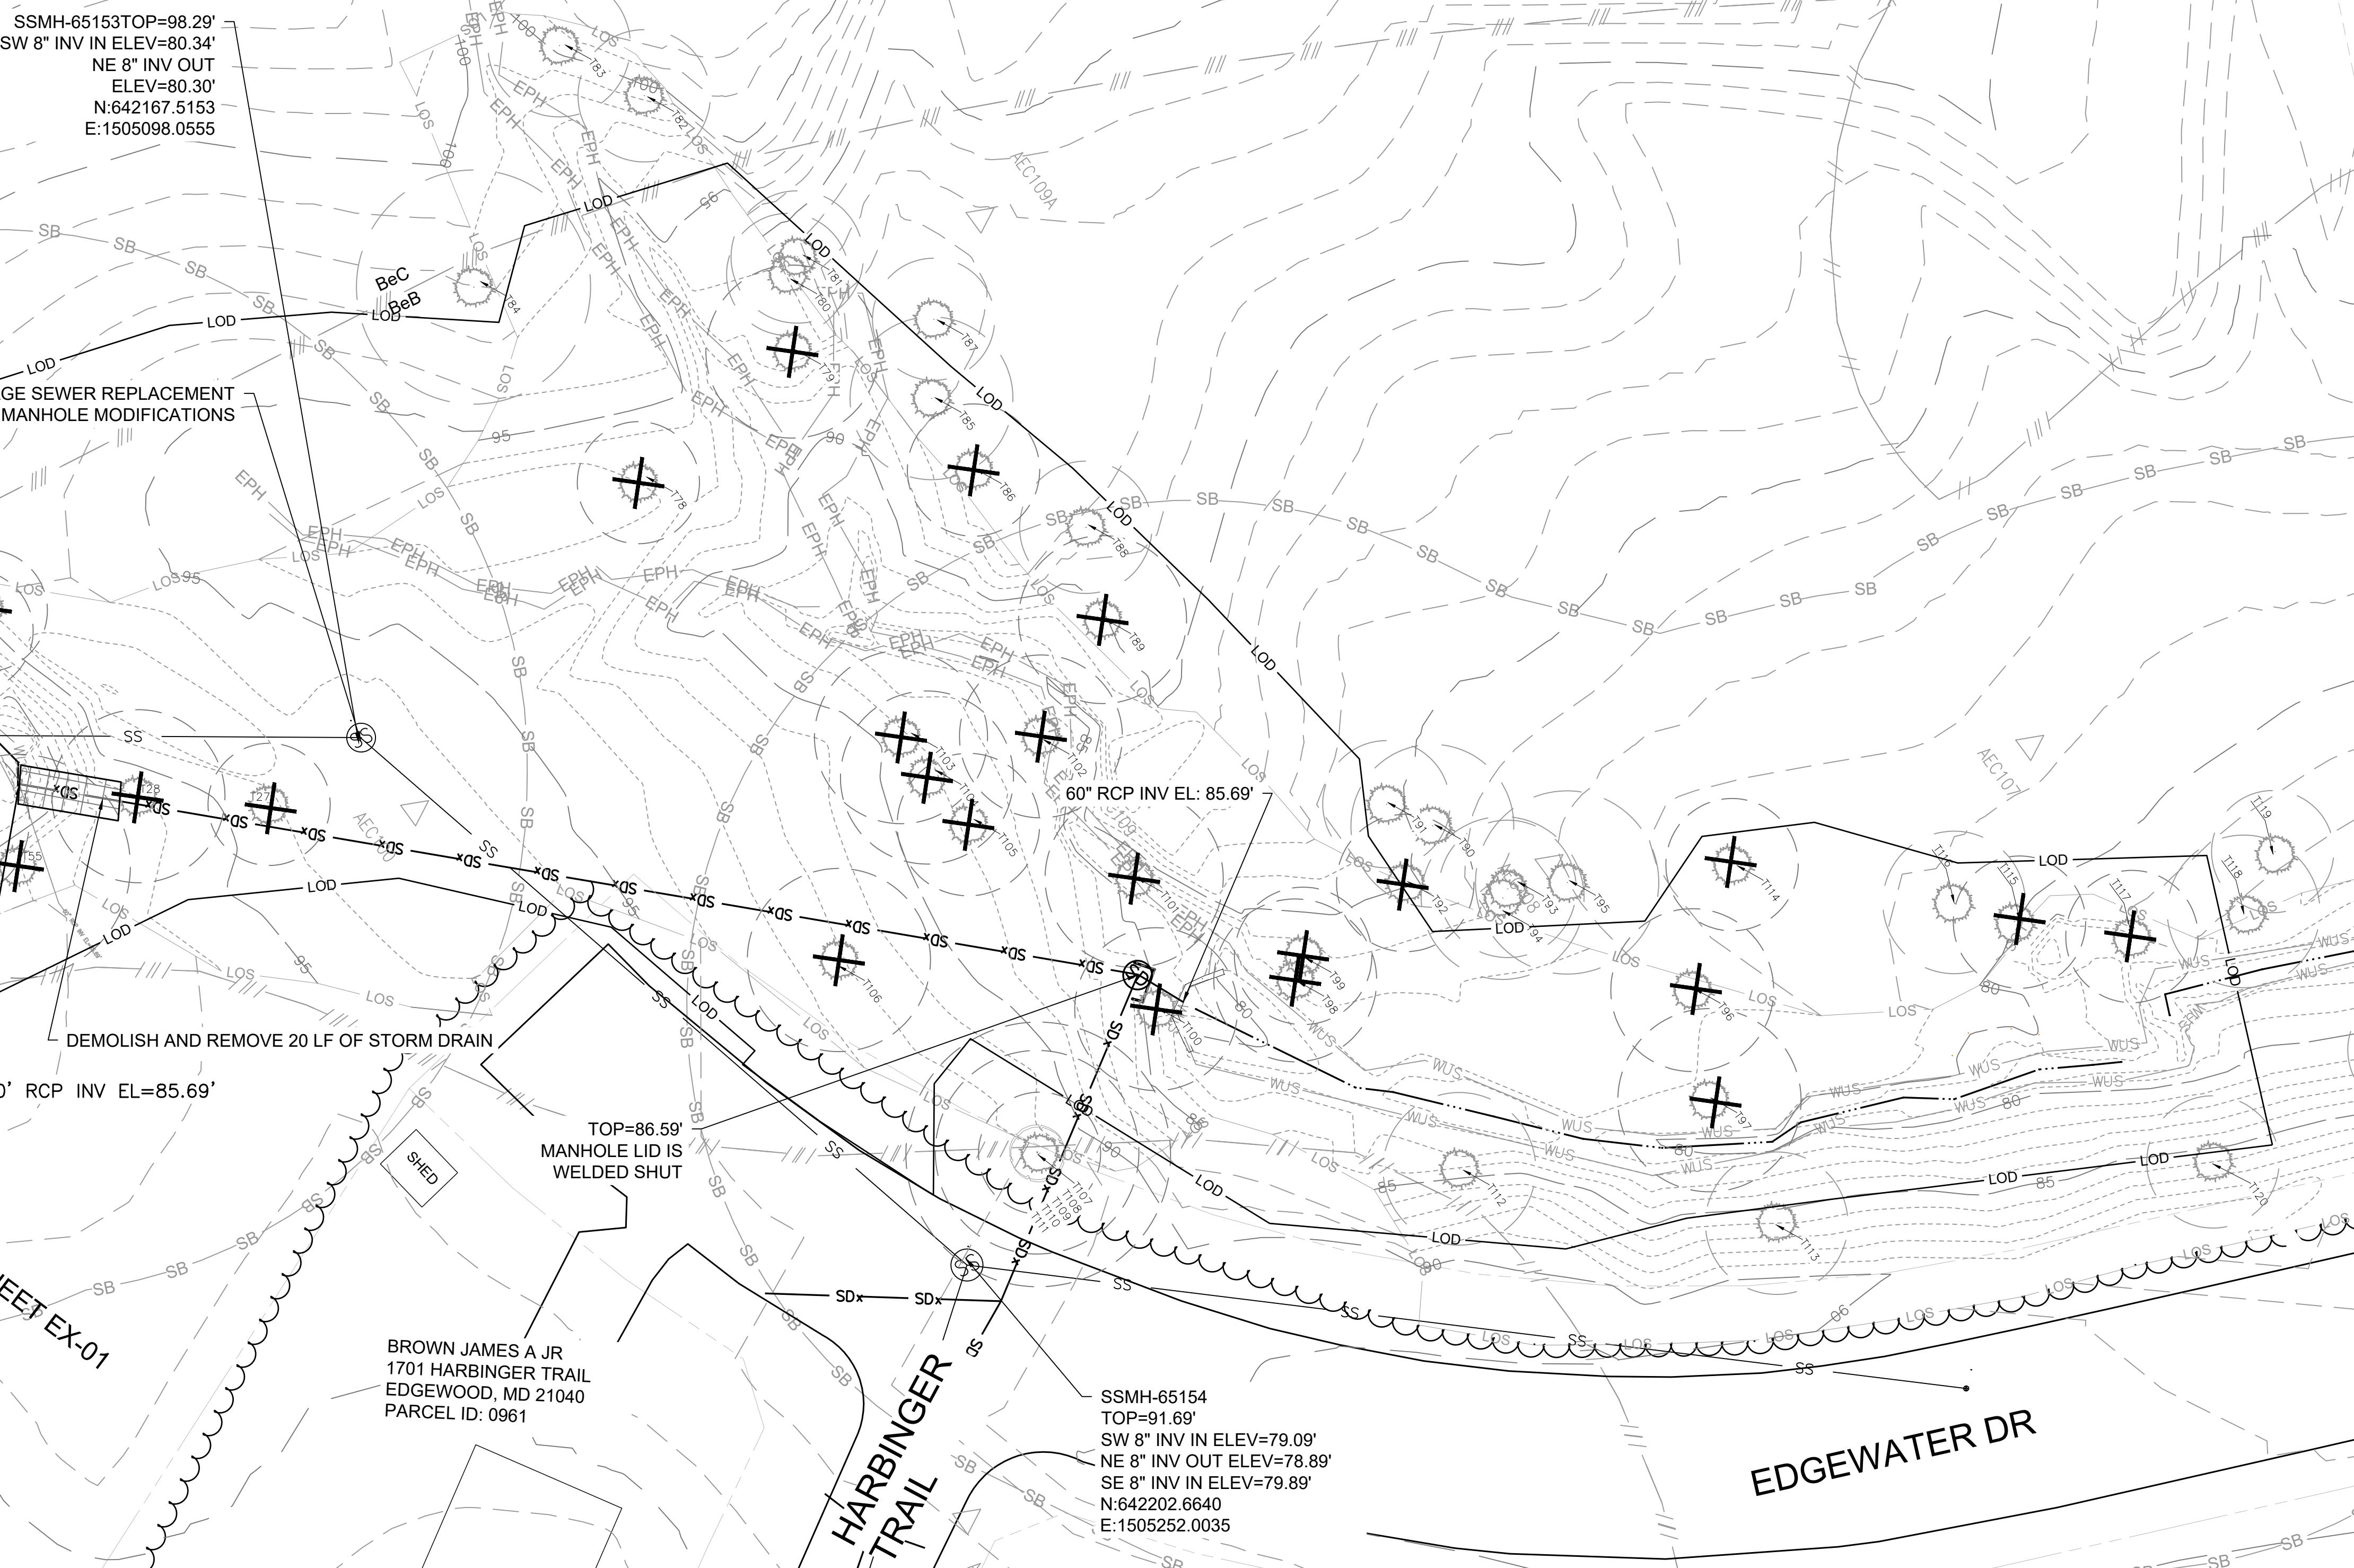

SOILS TABLE						
SOIL SYMBOL	SOIL NAME	PERCENT SLOPE	KF VALUE	HYDRIC (Y/N)	HIGHLY ERODIBLE SOILS	HSG
BeB	BELTSVILLE SILT LOAM	2%-5%	0.3700	N	NO	C
BeC	BELTSVILLE SILT LOAM	5%-10%	0.4300	N	YES	C
Sa	SAND AND GRAVEL PITS	N/A	N/A	N/A	N/A	N/A

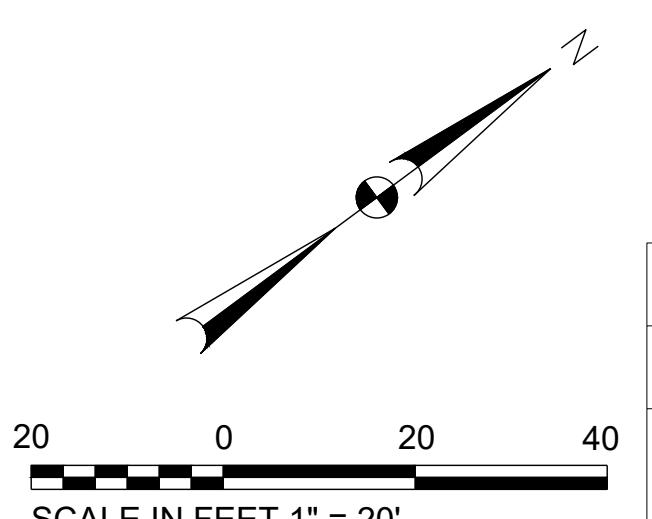


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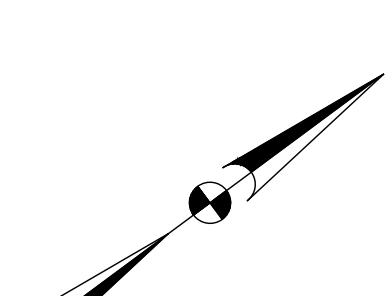
S/C PLAN # 59914	Revisions
GRA-004622-2025	
SIGN AND SEAL	

HARFORD COUNTY, MARYLAND	
EDGEWATER VILLAGE PARK STREAM RESTORATION EXISTING CONDITIONS	
Drawn By : CA	Scale : 1" = 20'
Designed By : CA	Date : SEPTEMBER 2025
Reviewed By : BWA	
Drawing No. EX-02 of EX-02	
Sheet No. 05 of 65	



HARFORD COUNTY
ROUTE 40
EDGEWOOD, MD 21040
PARCEL ID: 0254

MATCHLINE SEE SHEET FC-01

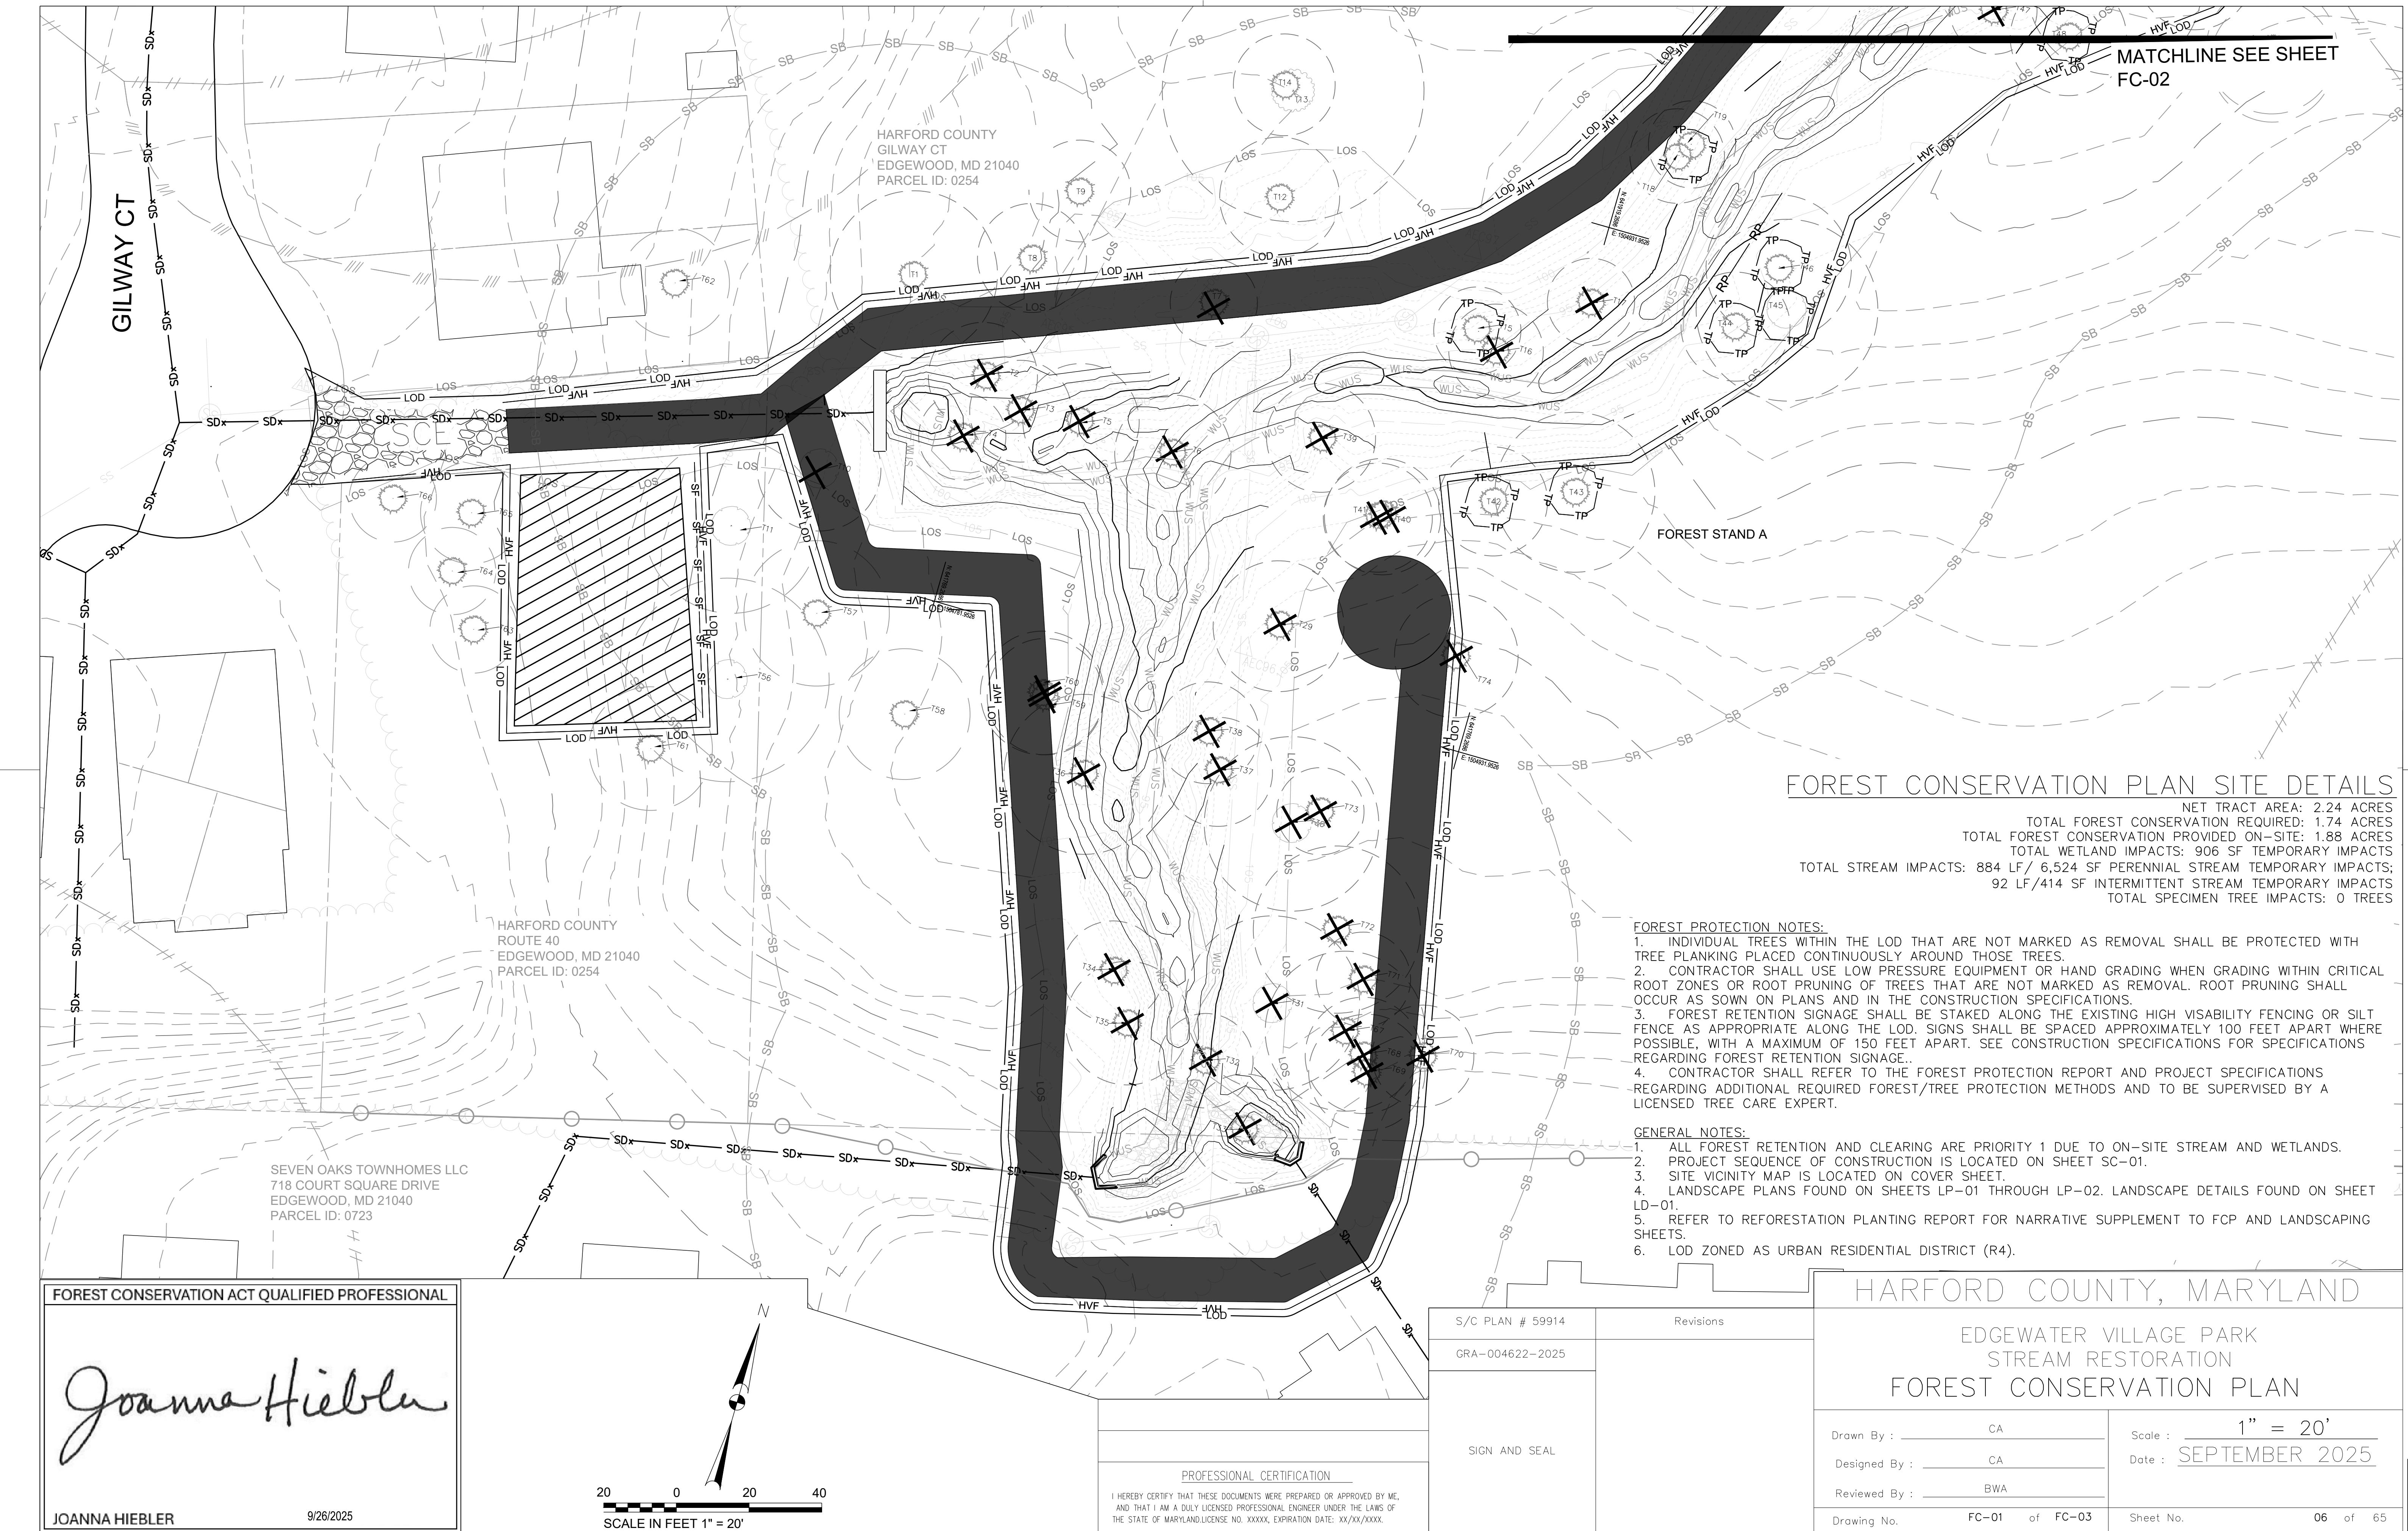

20 0 20 40
SCALE IN FEET 1" = 20'

FOREST CONSERVATION ACT QUALIFIED PROFESSIONAL
JOANNA HIEBLER 9/26/2025

BROWN JAMES A JR
1701 HARBINGER TRAIL
EDGEWOOD, MD 21040
PARCEL ID: 0961

HARBINGER
TRAIL

EDGEWATER DR

S/C PLAN # 59914	Revisions
GRA-004622-2025	
SIGN AND SEAL	


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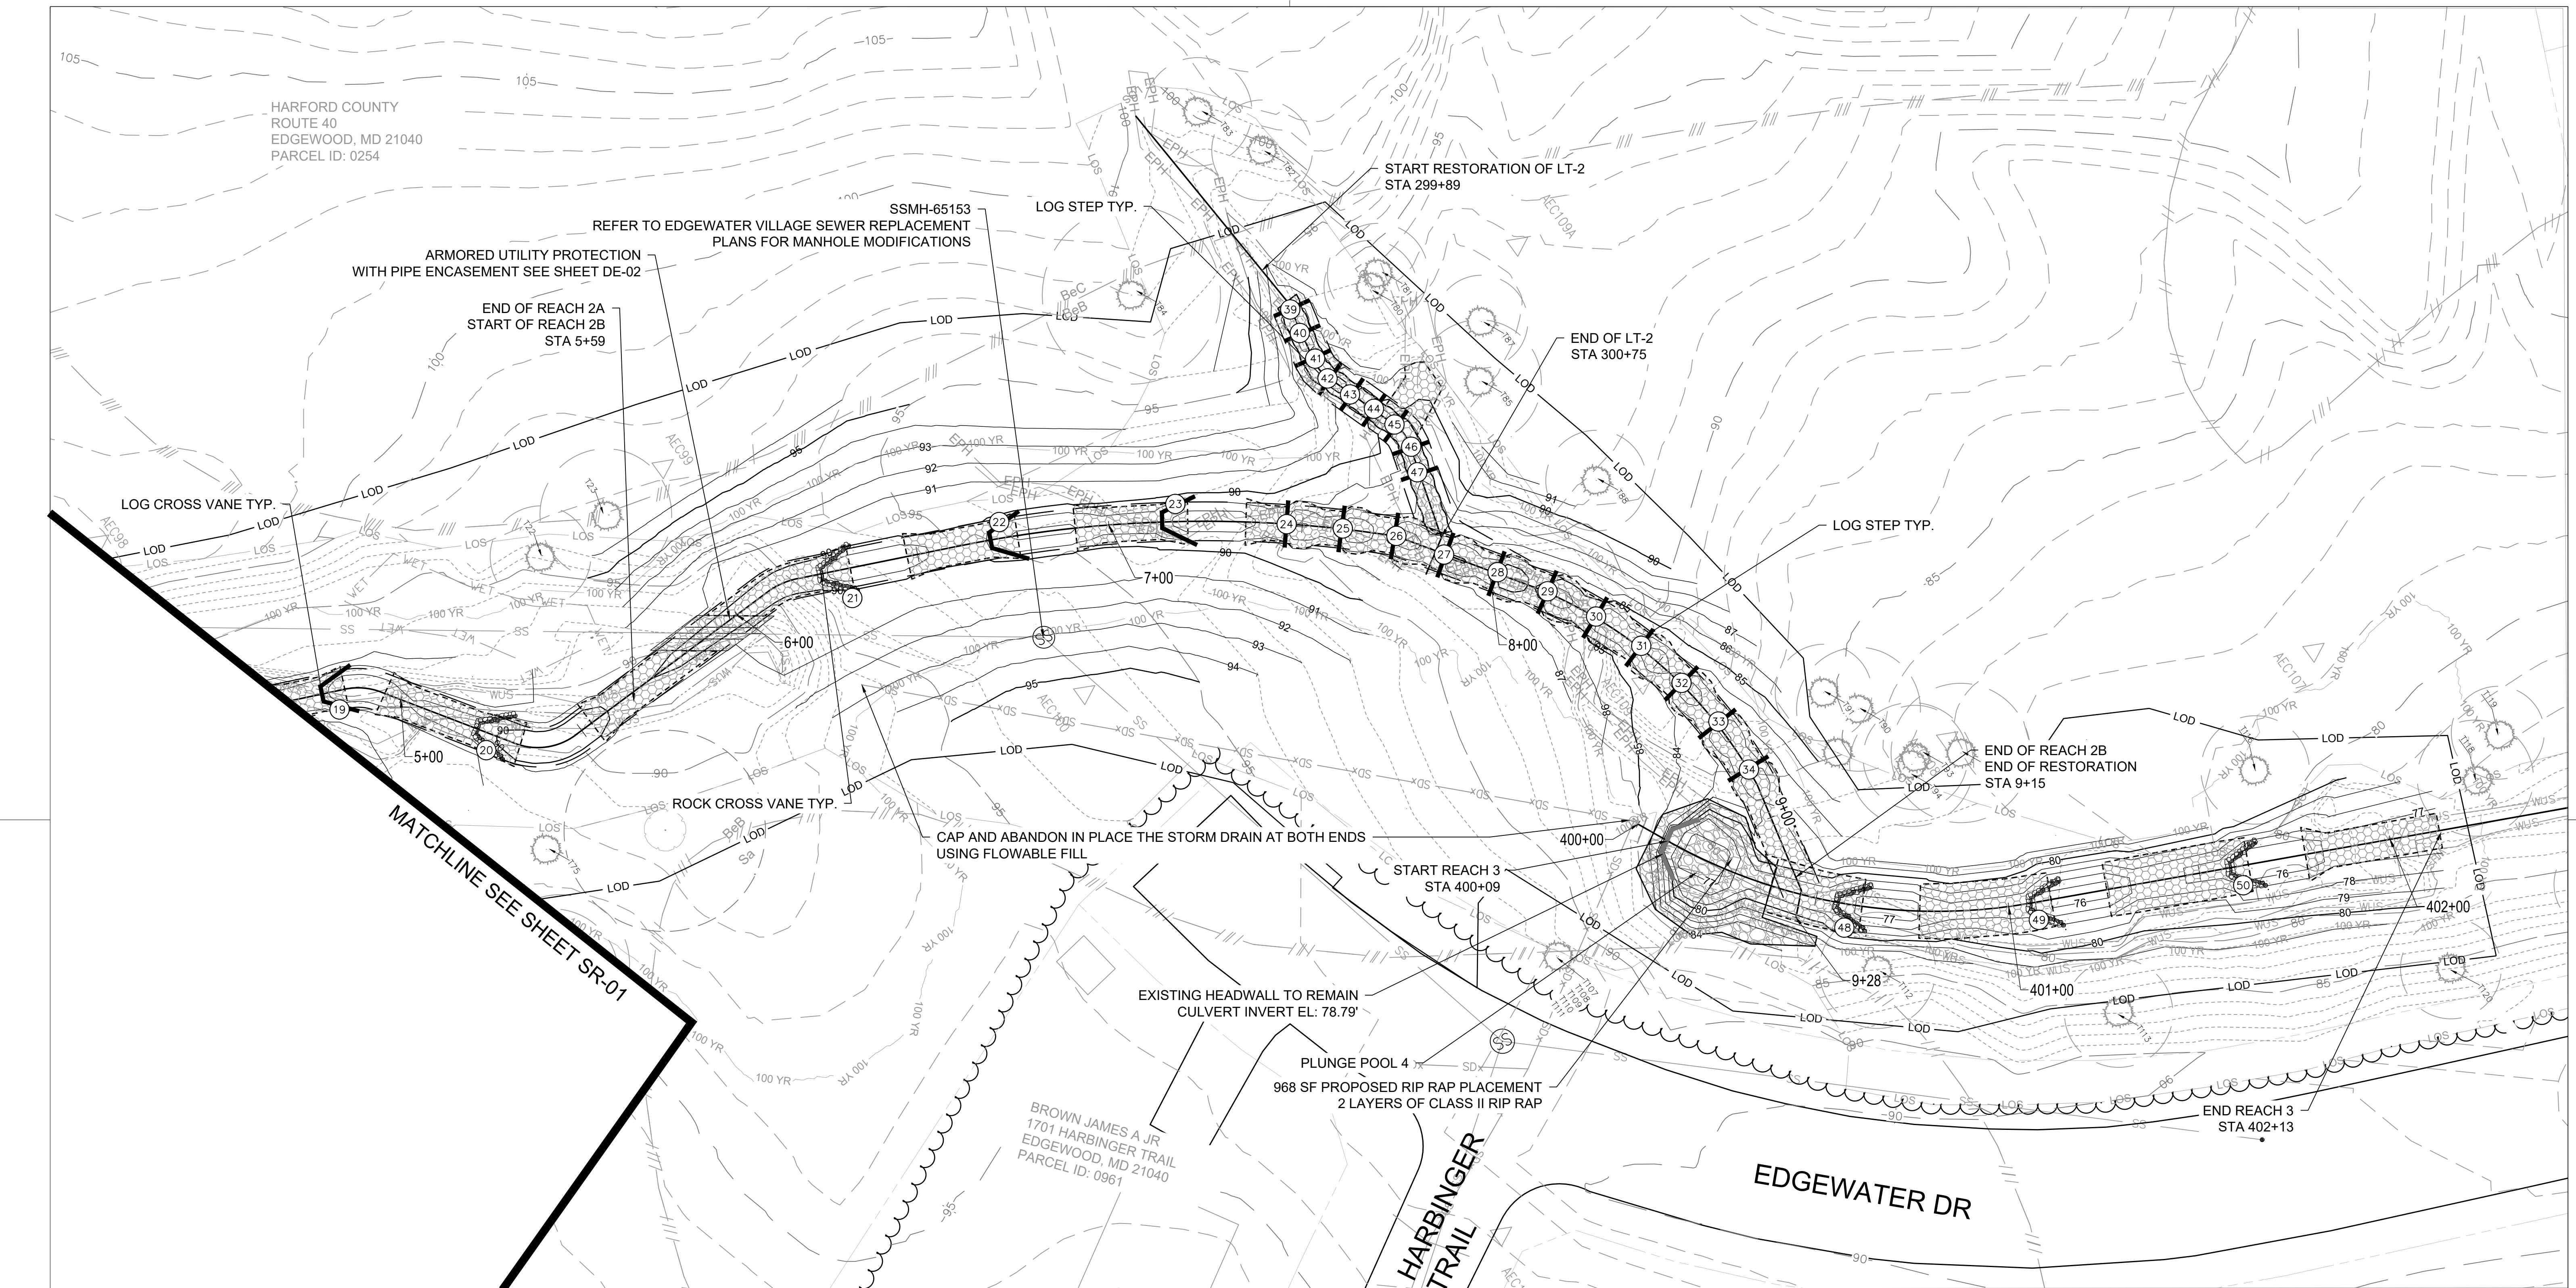
HARFORD COUNTY, MARYLAND
EDGEWATER VILLAGE PARK
STREAM RESTORATION
FOREST CONSERVATION PLAN

Drawn By : CA	Scale : 1" = 20'
Designed By : CA	Date : SEPTEMBER 2025
Reviewed By : BWA	
Drawing No. FC-02 of FC-03	Sheet No. 07 of 65

Tree ID	Common Name	DBH (in)	Appraisal	CRZ (ft)	Suitable for Re-use (Y/N)	Specimen Tree	Within LOD (Y/N)	To be Removed
1	American sycamore	23	Good	23	N	N	N	N
2	Tulip poplar	15	Good	15	Y	N	Y	Y
3	Red maple	14	Good	14	Y	N	Y	Y
4	Red maple	12	Good	12	N	N	Y	Y
5	Tulip poplar	16	Good	16	Y	N	Y	Y
6	Red maple	16	Good	16	Y	N	Y	Y
7	Tulip poplar	12	Good	12	N	N	Y	Y
8	Pitch pine	15	Poor	15	N	N	N	N
9	Red maple	14	Good	14	N	N	N	N
10	Tulip poplar	17	Good	17	Y	N	Y	Y
11	Chestnut oak	24	Poor	24	N	N	Y	N
12	Tulip poplar	16.5	Good	16.5	N	N	N	N
13	Red maple	36	Poor	36	N	Y	N	N
14	Red maple	14	Fair	14	Y	N	N	N
15	Tulip poplar	12	Good	12	N	N	Y	N
16	Tulip poplar	13	Good	13	Y	N	Y	Y
17	Tulip poplar	12	Fair	12	Y	N	Y	Y
18	Red maple	13	Good	13	Y	N	Y	N
19	Silver maple	12	Good	12	N	N	Y	N
20	Red maple	15	Good	15	Y	N	Y	Y
21	Tulip poplar	19	Good	19	Y	N	Y	Y
22	Red maple	13	Good	13	Y	N	Y	N
23	Red maple	17	Good	17	Y	N	Y	N
24	Black gum	12	Good	12	N	N	Y	Y
25	Red maple	14	Good	14	Y	N	Y	Y
26	Red maple	18	Good	18	Y	N	Y	Y
27	Black locust	12	Fair	12	Y	N	Y	Y
28	Black locust	17	Fair	17	Y	N	Y	Y
29	Chestnut oak	18	Good	18	Y	N	Y	Y
30	Chestnut oak	24	Poor	24	N	N	Y	Y
31	Scarlet oak	24	Good	24	Y	N	Y	Y
32	Tulip poplar	13	Good	13	Y	N	Y	Y
33	Tulip poplar	15	Good	15	Y	N	Y	Y
34	American beech	14	Good	14	Y	N	Y	Y
35	Tulip poplar	17	Good	17	Y	N	Y	Y
36	Tulip poplar	22	Good	22	Y	N	Y	Y
37	Tulip poplar	15	Good	15	Y	N	Y	Y
38	Chestnut oak	14	Good	14	Y	N	Y	Y
39	Pitch pine	15	Good	15	Y	N	Y	Y
40	Chestnut oak	16	Good	16	Y	N	Y	Y
41	Chestnut oak	15	Good	15	Y	N	Y	Y
42	Scarlet oak	15	Good	15	N	N	Y	N
43	Chestnut oak	22	Good	22	N	N	Y	N
44	Swamp white oak	15	Good	15	N	N	Y	N
45	White oak	25	Good	25	N	N	Y	Y
46	Chestnut oak	20	Good	20	Y	N	Y	N
47	Tulip poplar	12	Good	12	N	N	Y	Y
48	Chestnut oak	16	Good	16	N	N	Y	N
49	Chestnut oak	24	Good	24	Y	N	Y	Y
50	Tulip poplar	14	Good	14	Y	N	Y	Y
51	Chestnut oak	13	Good	13	Y	N	Y	Y
52	Tulip poplar	12	Good	12	N	N	Y	Y
53	White oak	26	Good	26	N	N	Y	N
54	Red maple	16	Fair	16	Y	N	Y	Y
55	Tulip poplar	22	Good	22	Y	N	Y	Y
56	Black gum	28	Fair	28	Y	N	Y	N
57	Black gum	20	Fair	20	Y	N	Y	N
58	Black gum	18	Good	18	Y	N	Y	N
59	Chestnut oak	16	Good	16	Y	N	Y	Y
60	Chestnut oak	17	Good	17	Y	N	Y	Y
61	White oak	17	Poor	17	N	N	N	N
62	Red maple	15	Poor	15	N	N	N	N
63	Chinese elm	12	Good	12	Y	N	Y	N
64	Chinese elm	12	Poor	12	N	N	Y	N
65	Chinese elm	14	Poor	14	N	N	Y	N
66	Chinese elm	12	Poor	12	N	N	Y	N
67	Chestnut oak	22	Fair	22	Y	N	Y	Y
68	Black cherry	16	Fair	16	Y	N	Y	Y
69	Japanese elm	16	Fair	16	Y	N	Y	Y
70	Red maple	14	Fair	14	Y	N	Y	Y
71	Chestnut oak	13	Fair	13	Y	N	Y	Y
72	Chestnut oak	23	Fair	23	Y	N	Y	Y
73	Chestnut oak	12	Good	12	Y	N	Y	Y
74	Chestnut oak	17	Fair	17	Y	N	Y	Y
75	Chestnut oak	16	Good	16	Y	N	Y	N
76	Chestnut oak	18	Good	18	Y	N	N	N
77	White oak	17	Fair	17	Y	N	N	N
78	Red maple	12	Fair	12	Y	N	Y	Y
79	Loblolly pine	17	Fair	17	Y	N	Y	Y
80	Virginia Pine	12	Fair	12	Y	N	Y	N
81	Virginia Pine	13	Fair	13	Y	N	Y	N
82	Red maple	13	Poor	13	N	N	Y	N
83	Tulip poplar	14	Poor	14	N	N	Y	N
84	Black cherry	23	Poor	23	N	N	Y	N
85	Virginia pine	16	Good	16	Y	N	Y	N
86	Black cherry	13	Poor	13	N	N	Y	Y
87	Virginia pine	12	Fair	12	Y	N	N	N
88	Red maple	13	Fair	13	Y	N	Y	N
89	Red maple	16.5	Fair	16.5	Y	N	Y	Y
90	Loblolly pine	16	Fair	16	Y	N	N	N
91	Loblolly pine	12.5	Fair	12.5	Y	N	Y	N
92	Virginia pine	13.5	Fair	13.5	Y	N	Y	Y
93	Loblolly pine	13.5	Fair	13.5	Y	N	N	N
94	Loblolly pine	16	Fair	16	Y	N	Y	N
95	Loblolly pine	18	Fair	18	Y	N	N	N
96	American sycamore	16	Fair	16	Y	N	N	Y
97	American sycamore	18	Fair	18	Y	N	N	Y
98	Red maple	16	Fair	16	Y	N	Y	Y
99	Sweet gum	13.5	Fair	13.5	Y	N	Y	Y
100	Red maple	16	Fair	16	Y	N	Y	Y

Tree ID	Common Name	DBH (in)	Appraisal	CRZ (ft)	Suitable for Re-use (Y/N)	Specimen Tree	Within LOD (Y/N)	To be Removed
101	American sycamore	17.5	Fair	17.5	Y	N	Y	Y
102	Loblolly pine	16	Fair	16	Y	N	Y	Y
103	Virginia pine	17	Fair	17	Y	N	Y	Y
104	Loblolly pine	17	Fair	17	Y	N	Y	Y
105	Loblolly pine	14	Poor	14	N	N	Y	Y
106	Bradford pear	18	Fair	18	Y	N	Y	Y
107	Red maple	14	Good	14	Y	N	Y	N
108	Red maple	14	Fair	14	Y	N	Y	N
109	Red maple	12	Fair	12	Y	N	Y	N
110	Red maple	20	Fair	20	Y	N	Y	N
111	Red maple	26	Fair	26	Y	N	Y	N
112	Bradford pear	15	Poor	15	N	N	Y	N
113	White mulberry	14	Fair	14	Y	N	Y	N
114	Loblolly pine	13	Fair	13	Y	N	Y	N



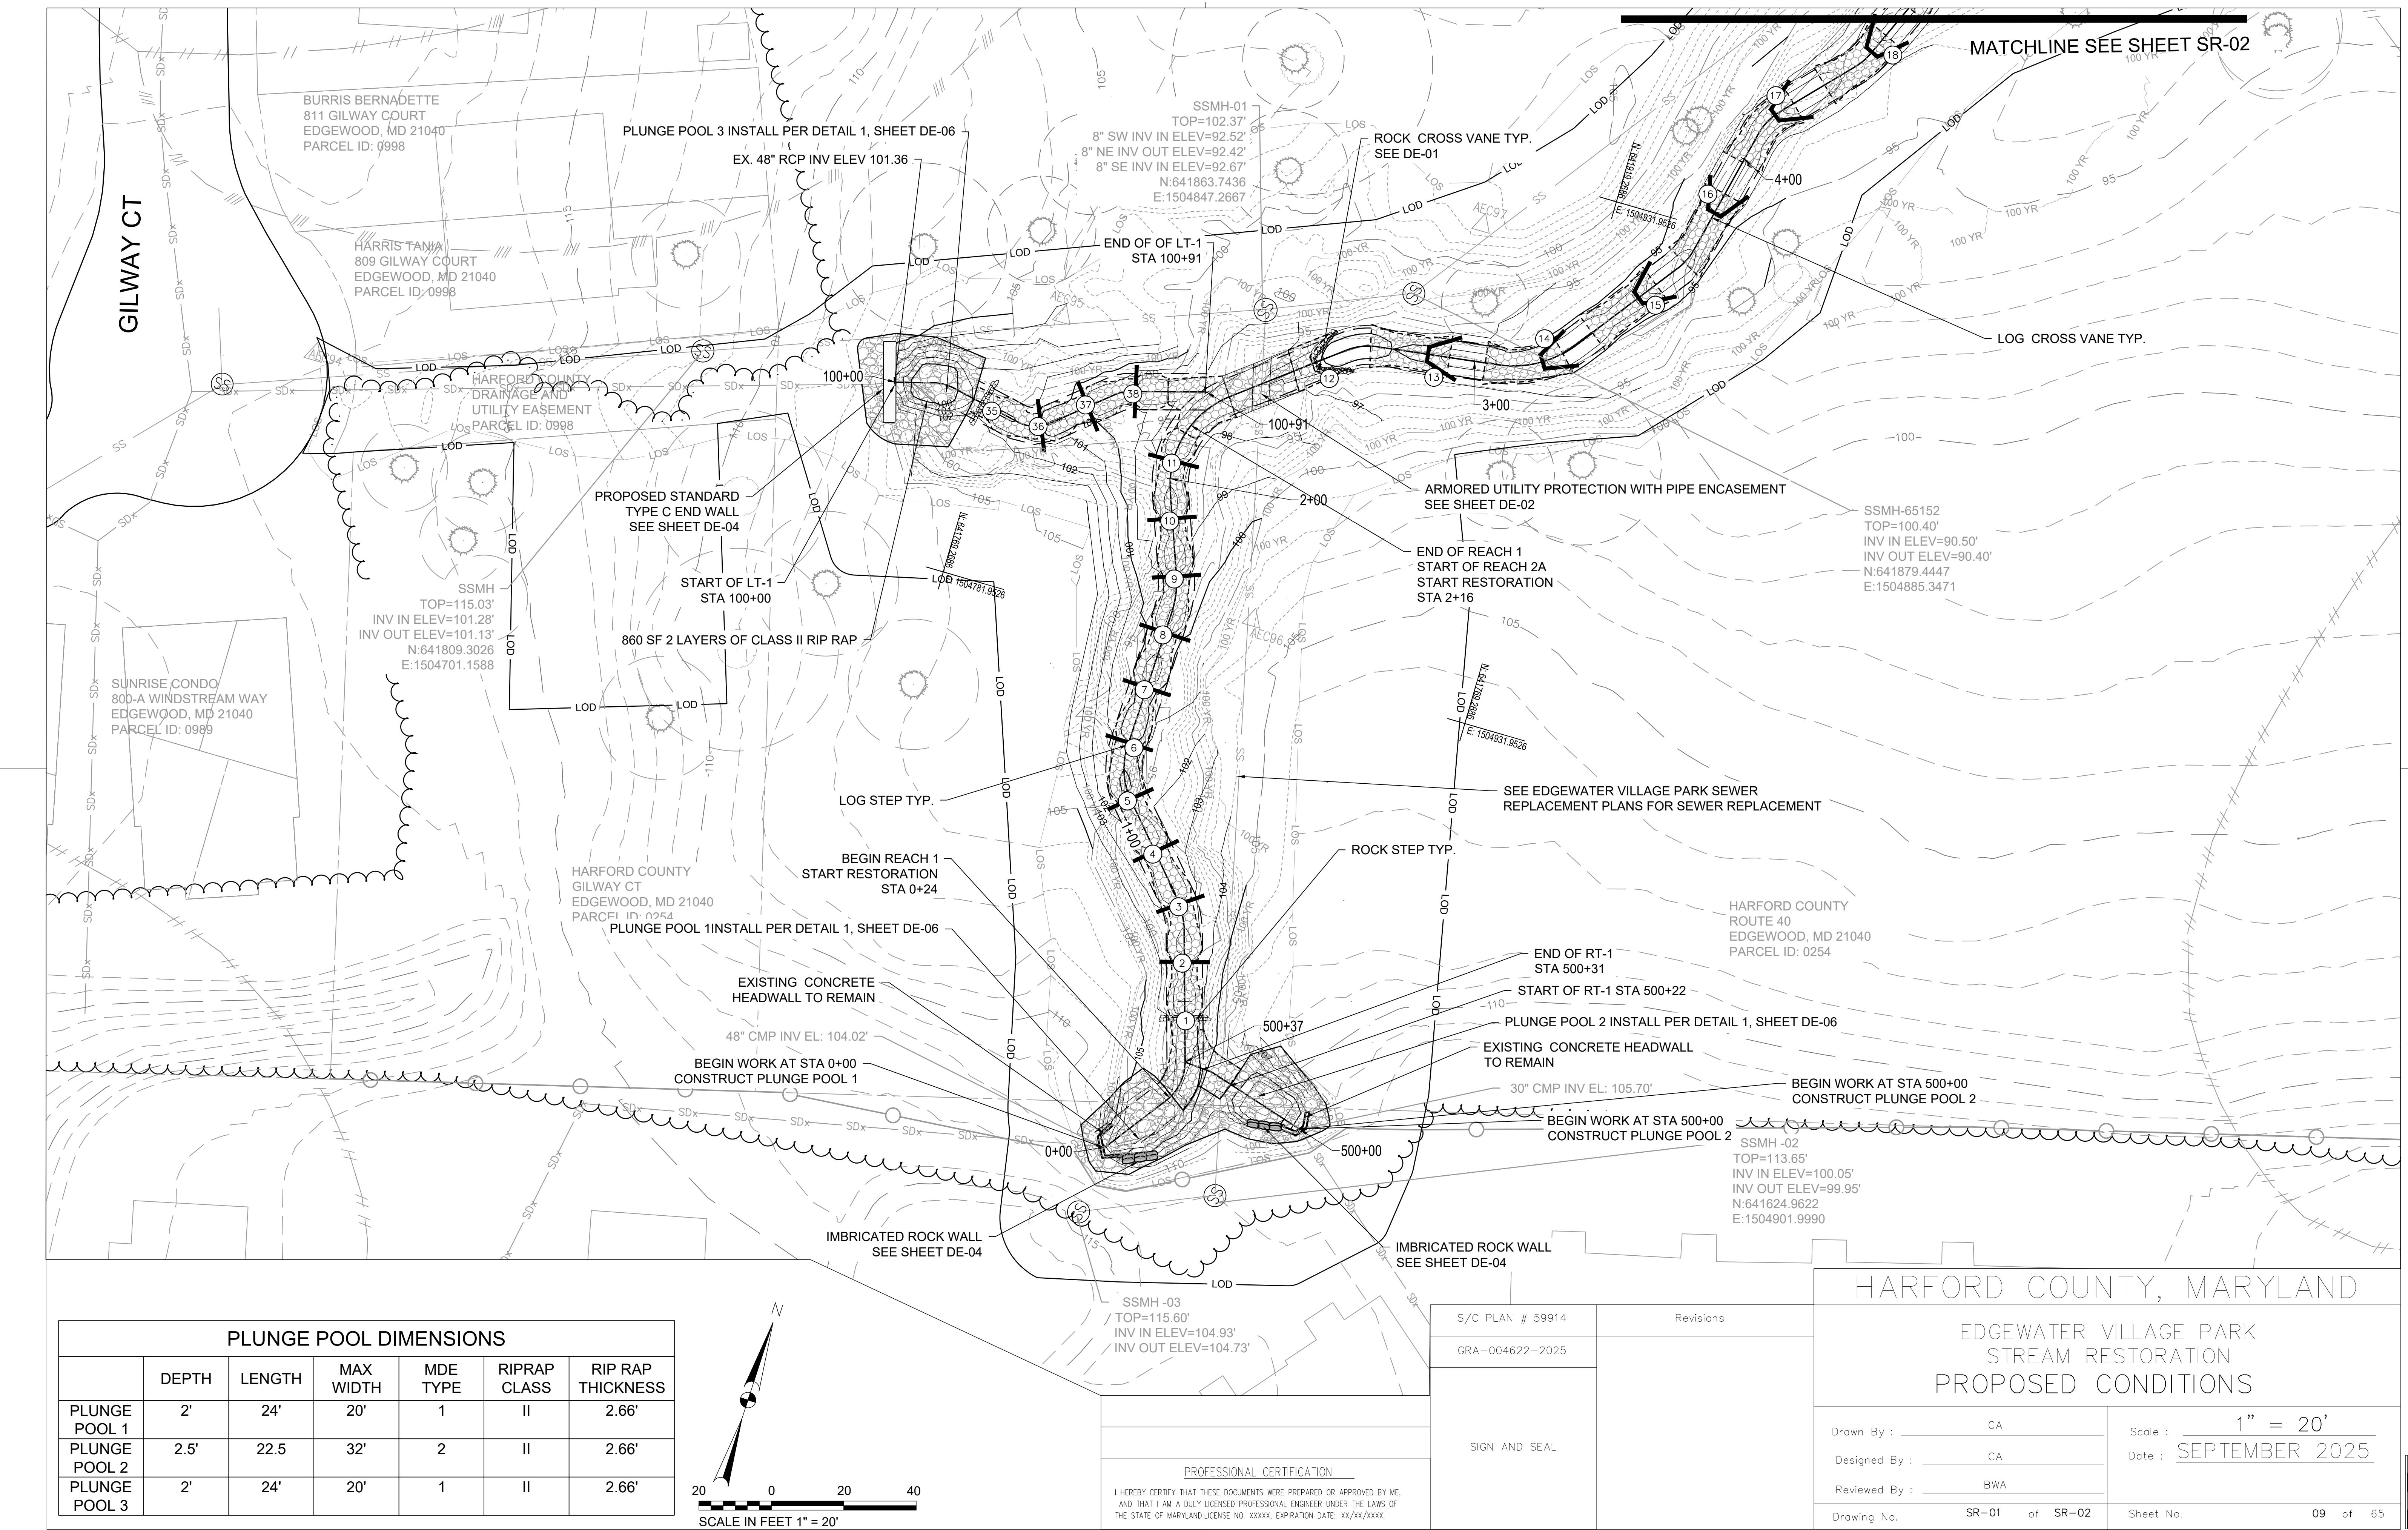

PLUNGE POOL DIMENSIONS


	DEPTH	LENGTH	MAX WIDTH	MDE TYPE	RIPRAP CLASS	RIP RAP THICKNESS
PLUNGE POOL 4	2'	24'	20'	1	II	2.66'

S/C PLAN # 59914	Revisions
GRA-004622-2025	
SIGN AND SEAL	
,	


HARFORD COUNTY, MARYLAND

EDGEWATER VILLAGE PARK STREAM RESTORATION PROPOSED CONDITIONS

Drawn By : _____	CA	Scale : <u>1" = 20'</u>
Signed By : _____	CA	Date : <u>SEPTEMBER 2025</u>
Checked By : _____	BWA	
Sheet No.	SR-02 of SR-02	10 of

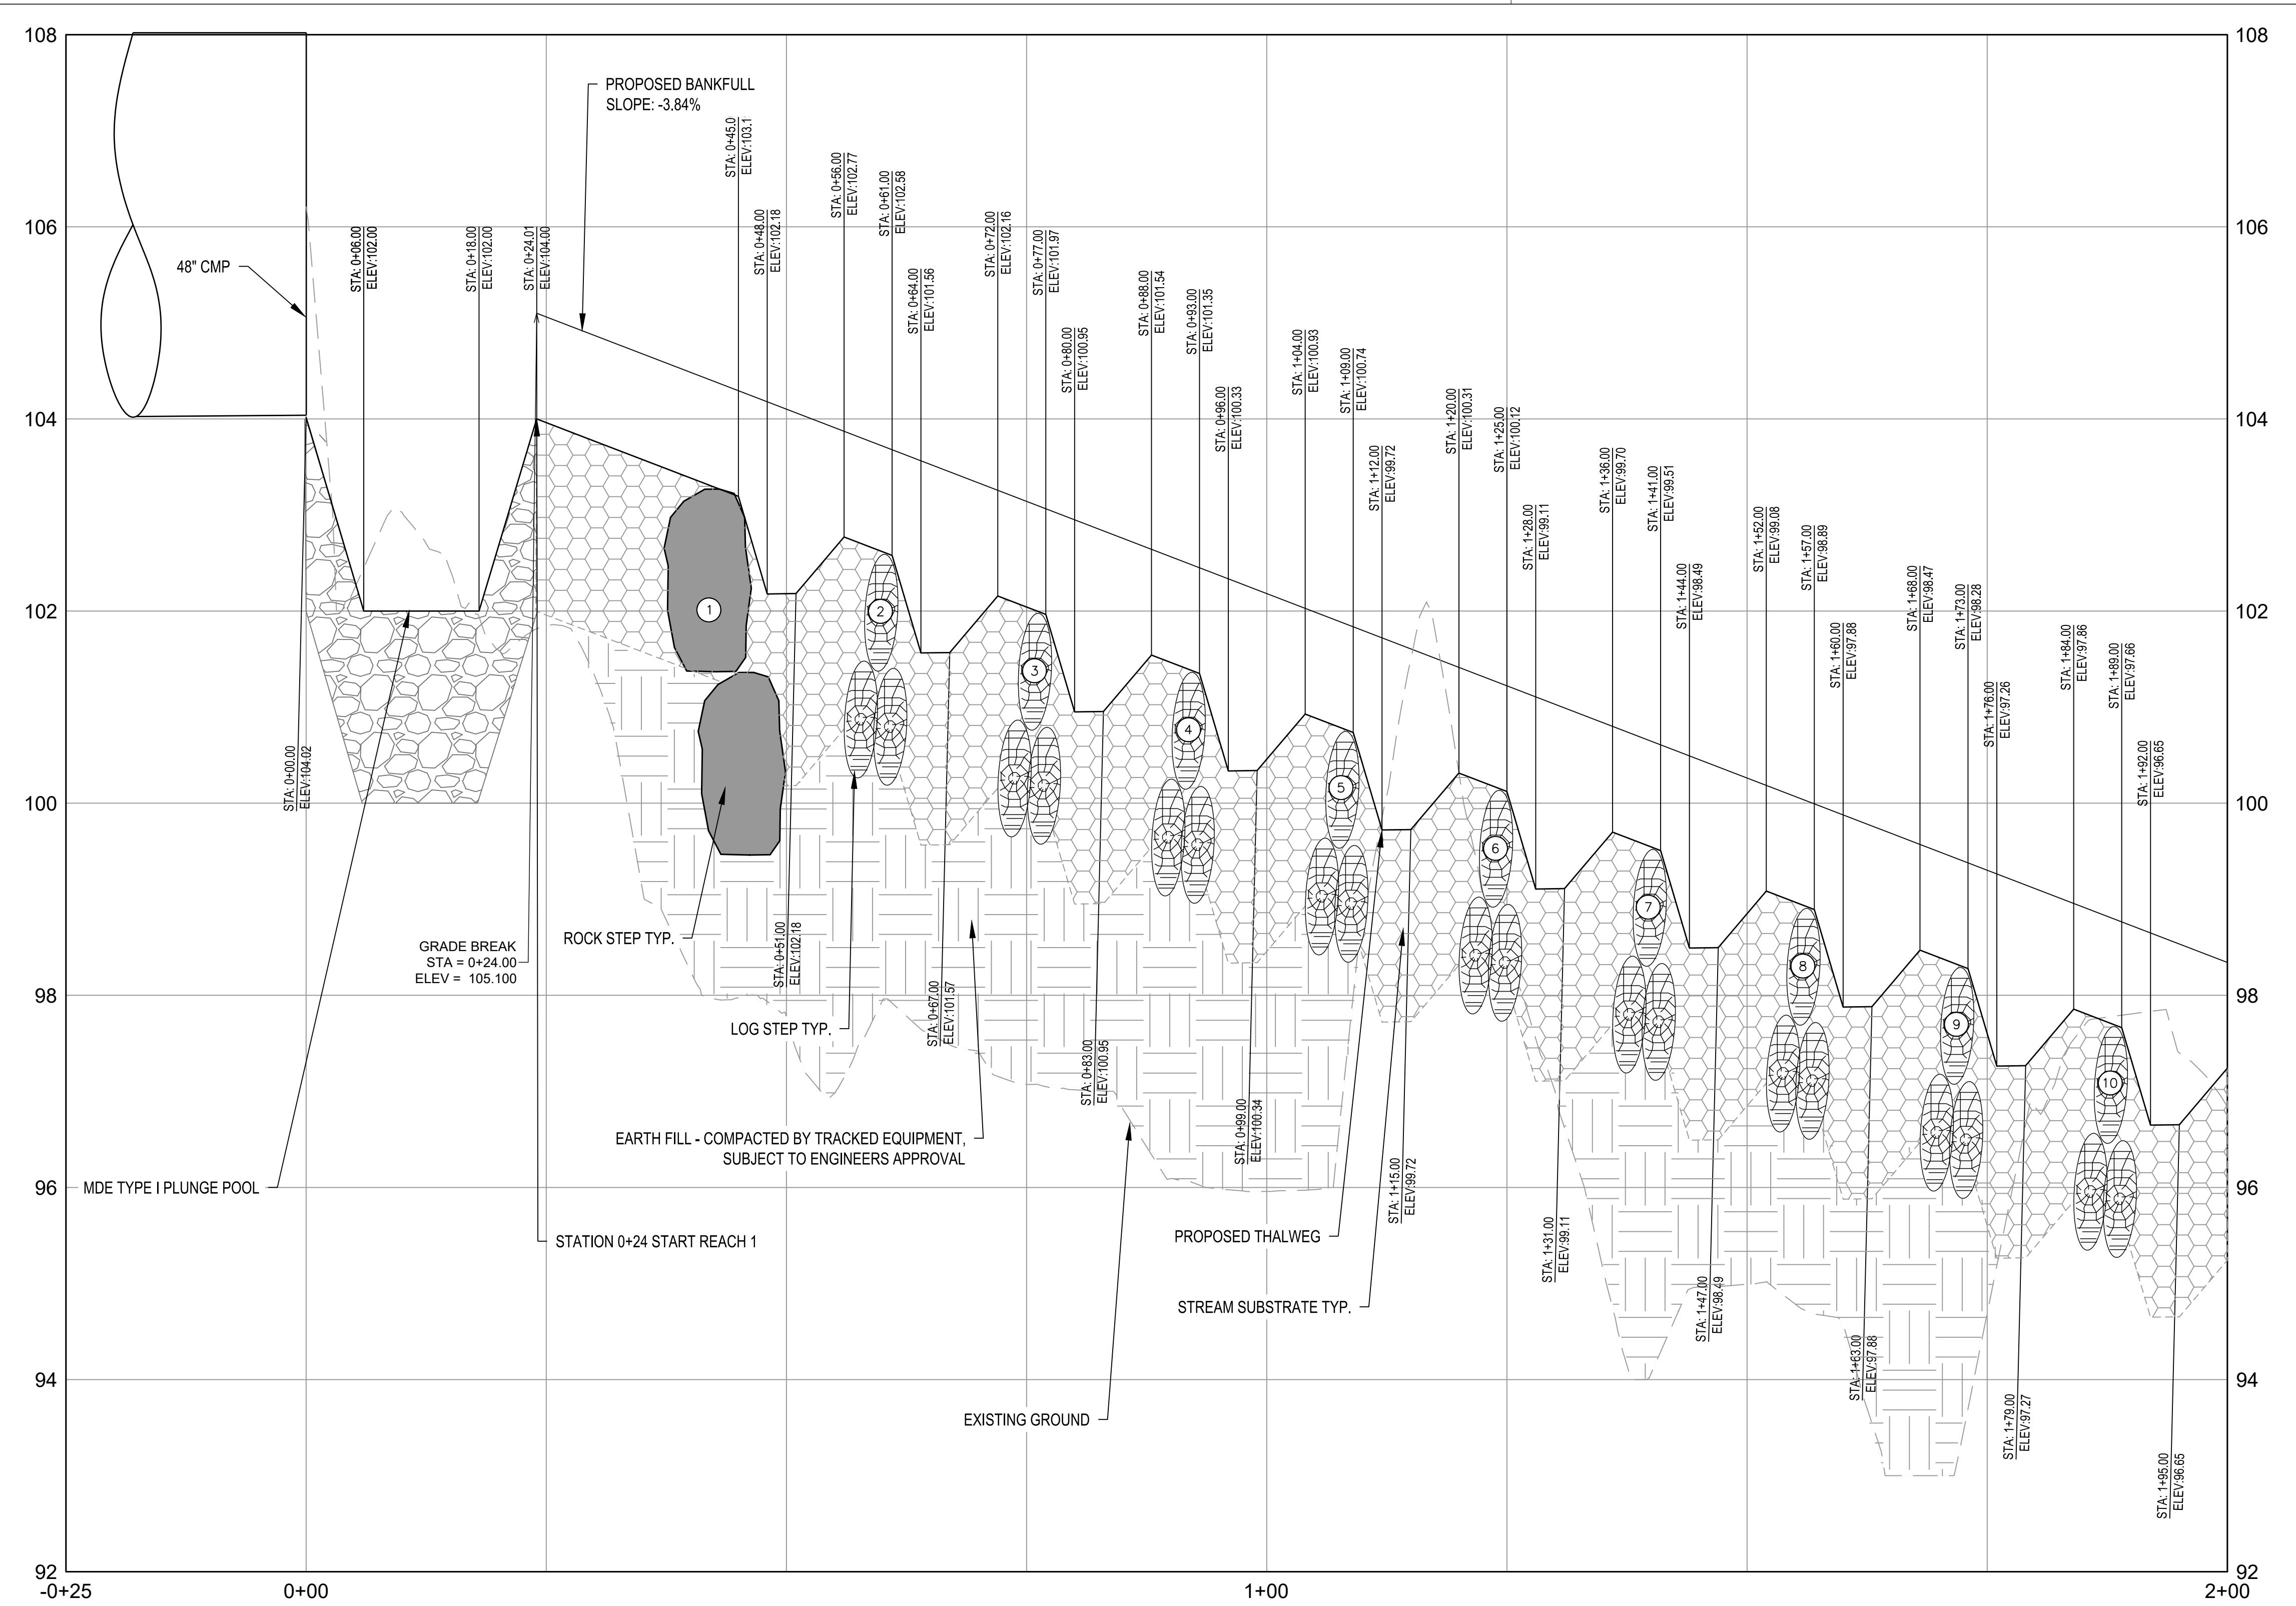

1 REACH 1 PROFILE STA 0+00-2+00

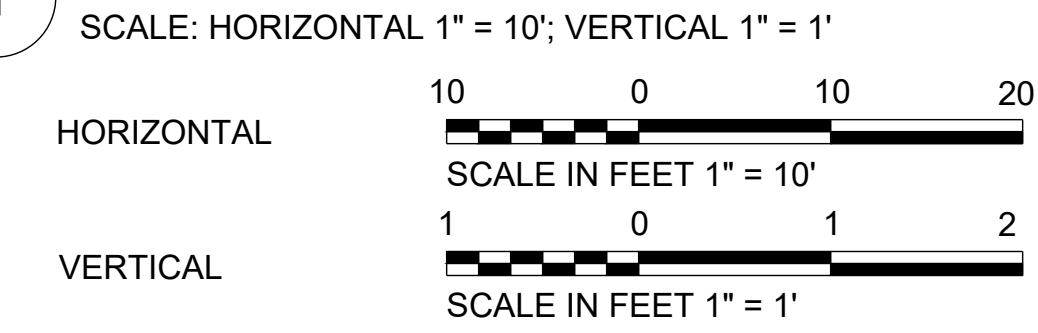

S/C PLAN # 59914

GRA-004622-2025

PROFESSIONAL CERTIFICATION

I HEREBY CERTIFY THAT THESE DOCUMENTS WERE PREPARED OR APPROVED BY ME, AND THAT I AM A DULY LICENSED PROFESSIONAL ENGINEER UNDER THE LAWS OF THE STATE OF MARYLAND. LICENSE NO. XXXXX, EXPIRATION DATE: XX/XX/XXXX.

SIGN AND SEAL

HARFORD COUNTY, MARYLAND

EDGEWATER VILLAGE PARK

STREAM RESTORATION


PROFILE VIEW

AS SHOWN

Scale : AS SHOWN

Date : SEPTEMBER 2025

Drawn By : CA	Designed By : CA
Reviewed By : BWA	
Drawing No. PR-01	of PR-08
Sheet No. 11 of 65	

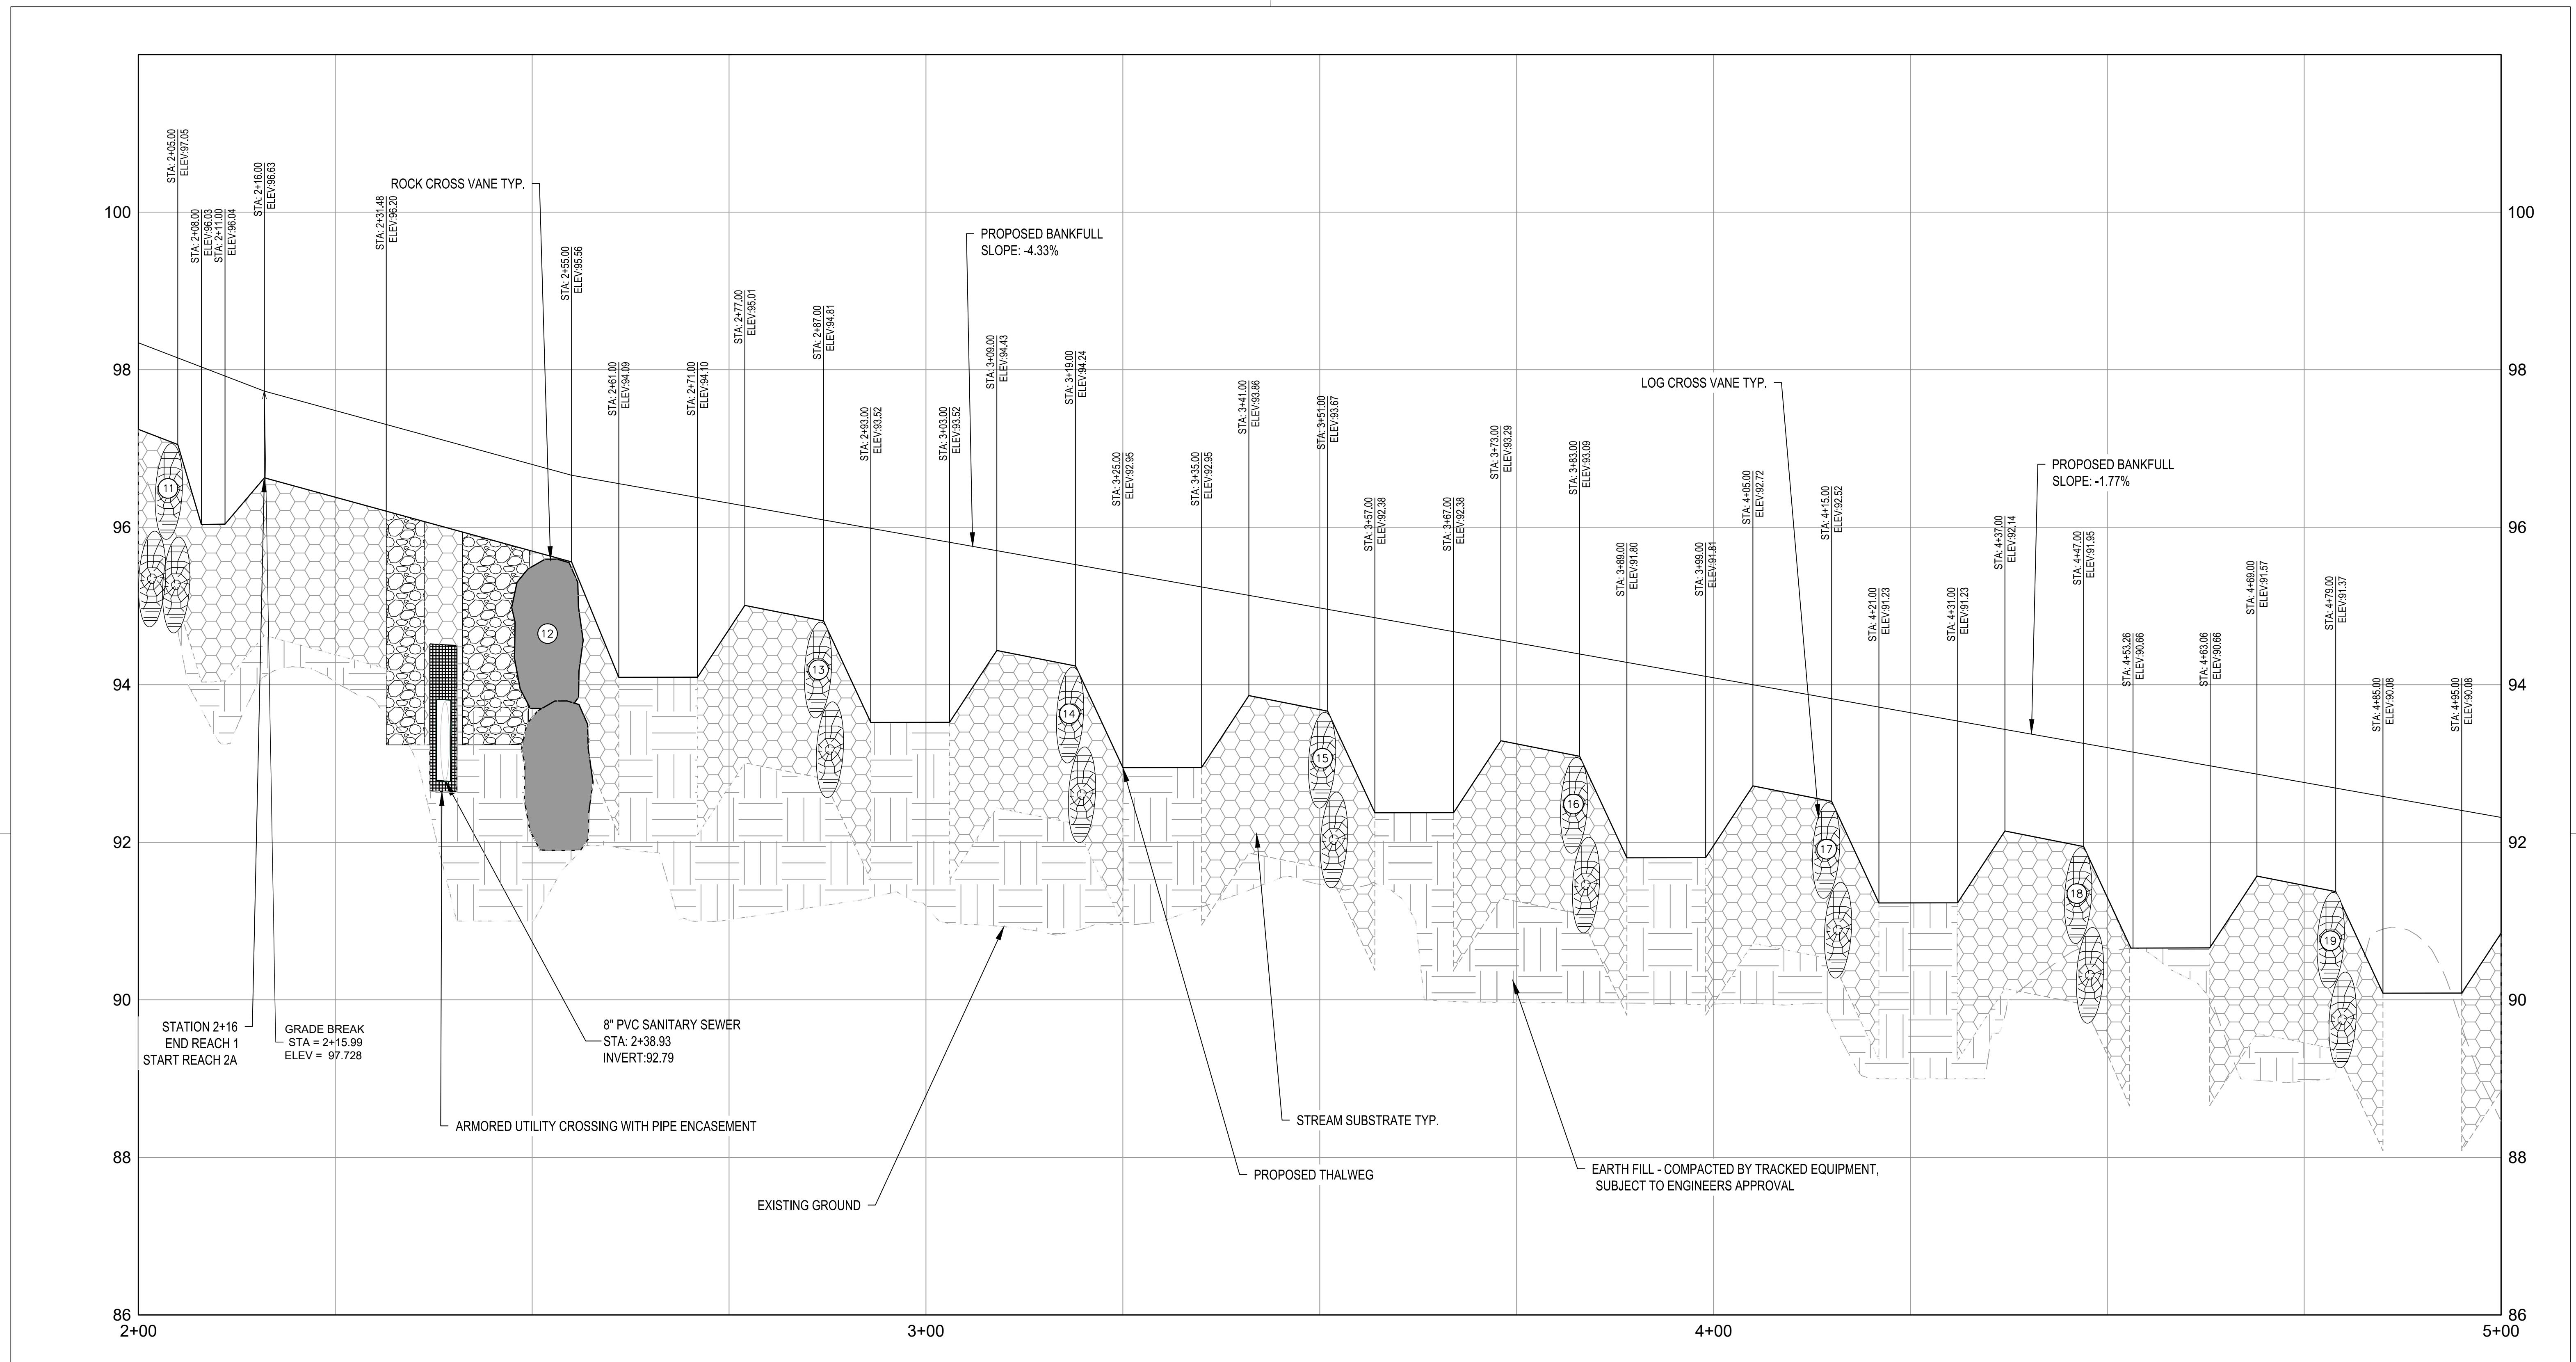

1 REACH 1 & 2A PROFILE STA 2+00-5+00


SCALE: HORIZONTAL 1" = 10'; VERTICAL 1" = 1'

HORIZONTAL



SCALE IN FEET 1" = 10'

VERTICAL

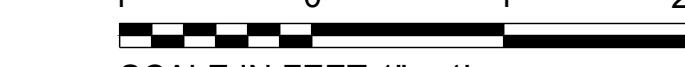

SCALE IN FEET 1" = 1'

S/C PLAN # 59914

Revisions

GRA-004622-2025

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HARFORD COUNTY, MARYLAND
EDGEWATER VILLAGE PARK
STREAM RESTORATION
PROFILE VIEW


AS SHOWN
Scale : 1" = 10'
Date : SEPTEMBER 2025

Drawn By : CA
Designed By : CA
Reviewed By : BWA

Drawing No. PR-02 of PR-08
Sheet No. 12 of 65

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THE STATE OF MARYLAND LICENSE NO. XXXXX, EXPIRATION DATE: XX/XX/XXXX.

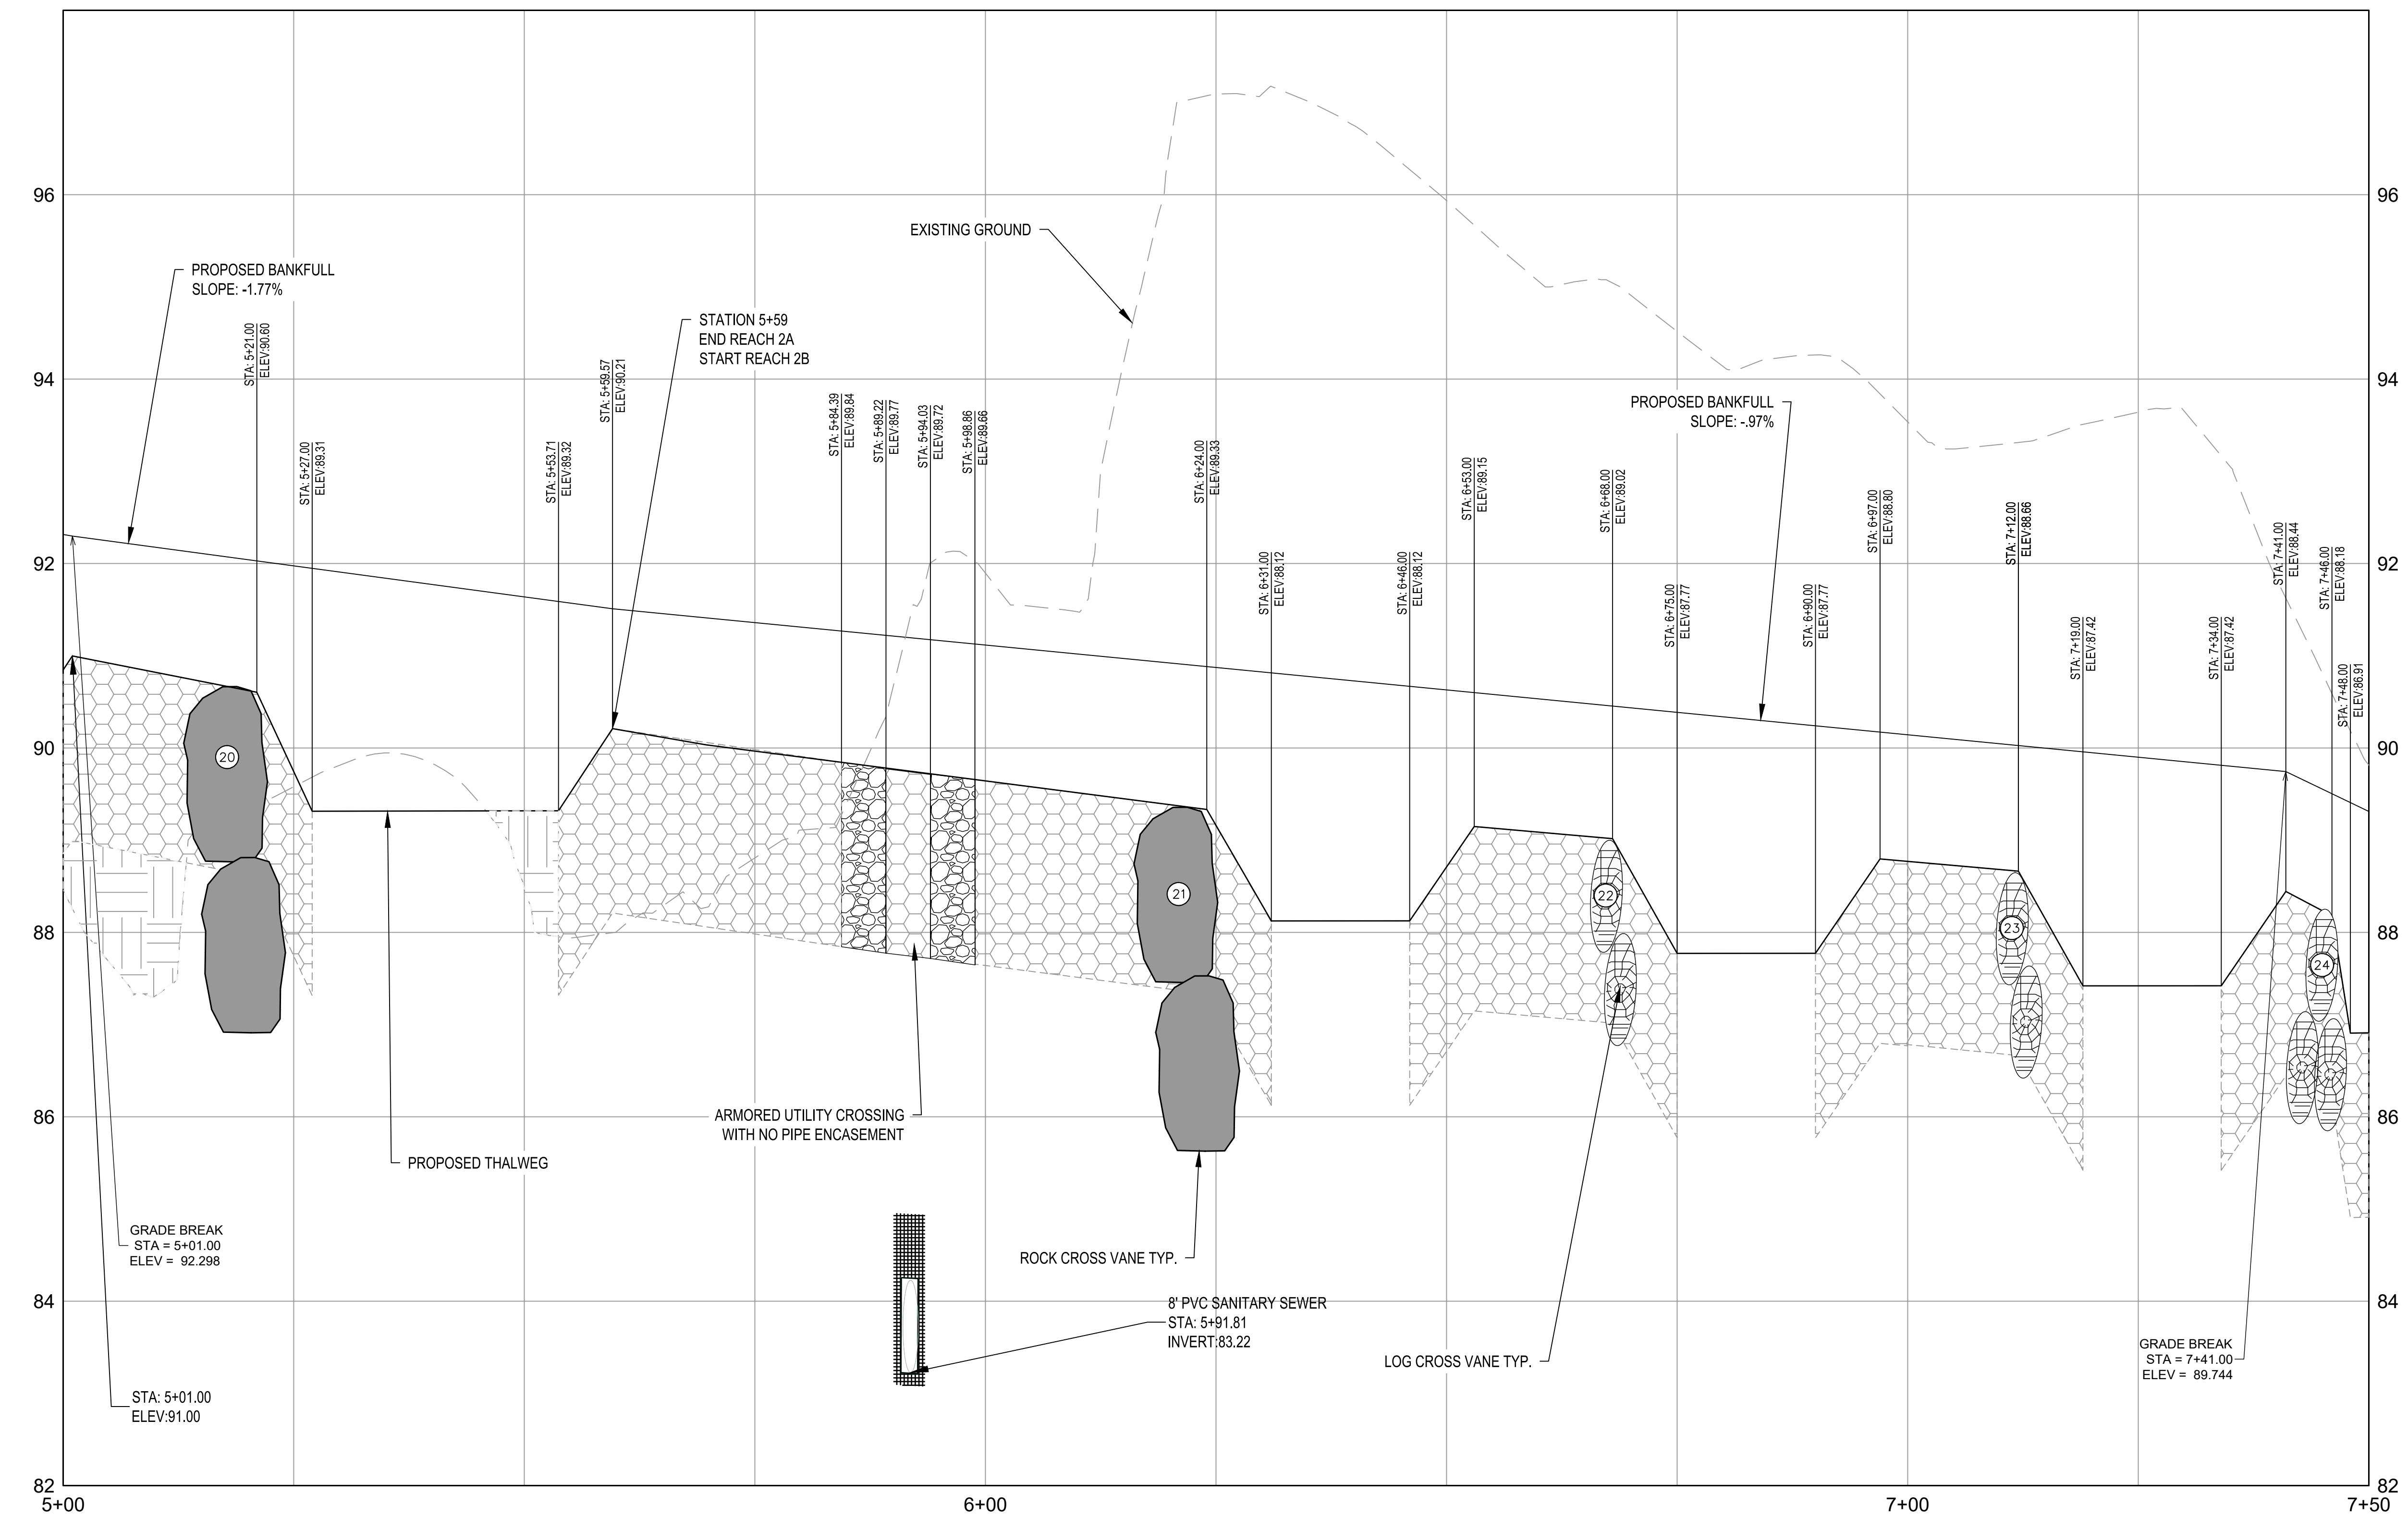

1 REACH 2A & 2B PROFILE STA 5+00-7+50

SCALE: HORIZONTAL 1" = 10'; VERTICAL 1"

HORIZONTAL

SCALING IN MILLIMETERS

SCALE IN FEET 1" = 10'

VERTICAL

A horizontal bar consisting of a checkered pattern of black and white squares, followed by a solid black segment, and then another checkered pattern. Above the bar, the numbers 1, 0, and 1 are positioned above the first, middle, and last segments respectively.

SCALE IN FEET 1" = 1'

S/C PLAN

Revision

GRA-00462

SIGN AND

HARFORD COUNTY, MARYLAND

EDGEWATER VILLAGE PARK STREAM RESTORATION PROFILE VIEW


AS SHOWN

SEPTEMBER 2025

designed By : CA Date : SEPTEMBER 2025

Reviewed By : DWA

PROFESSIONAL CERTIFICATION

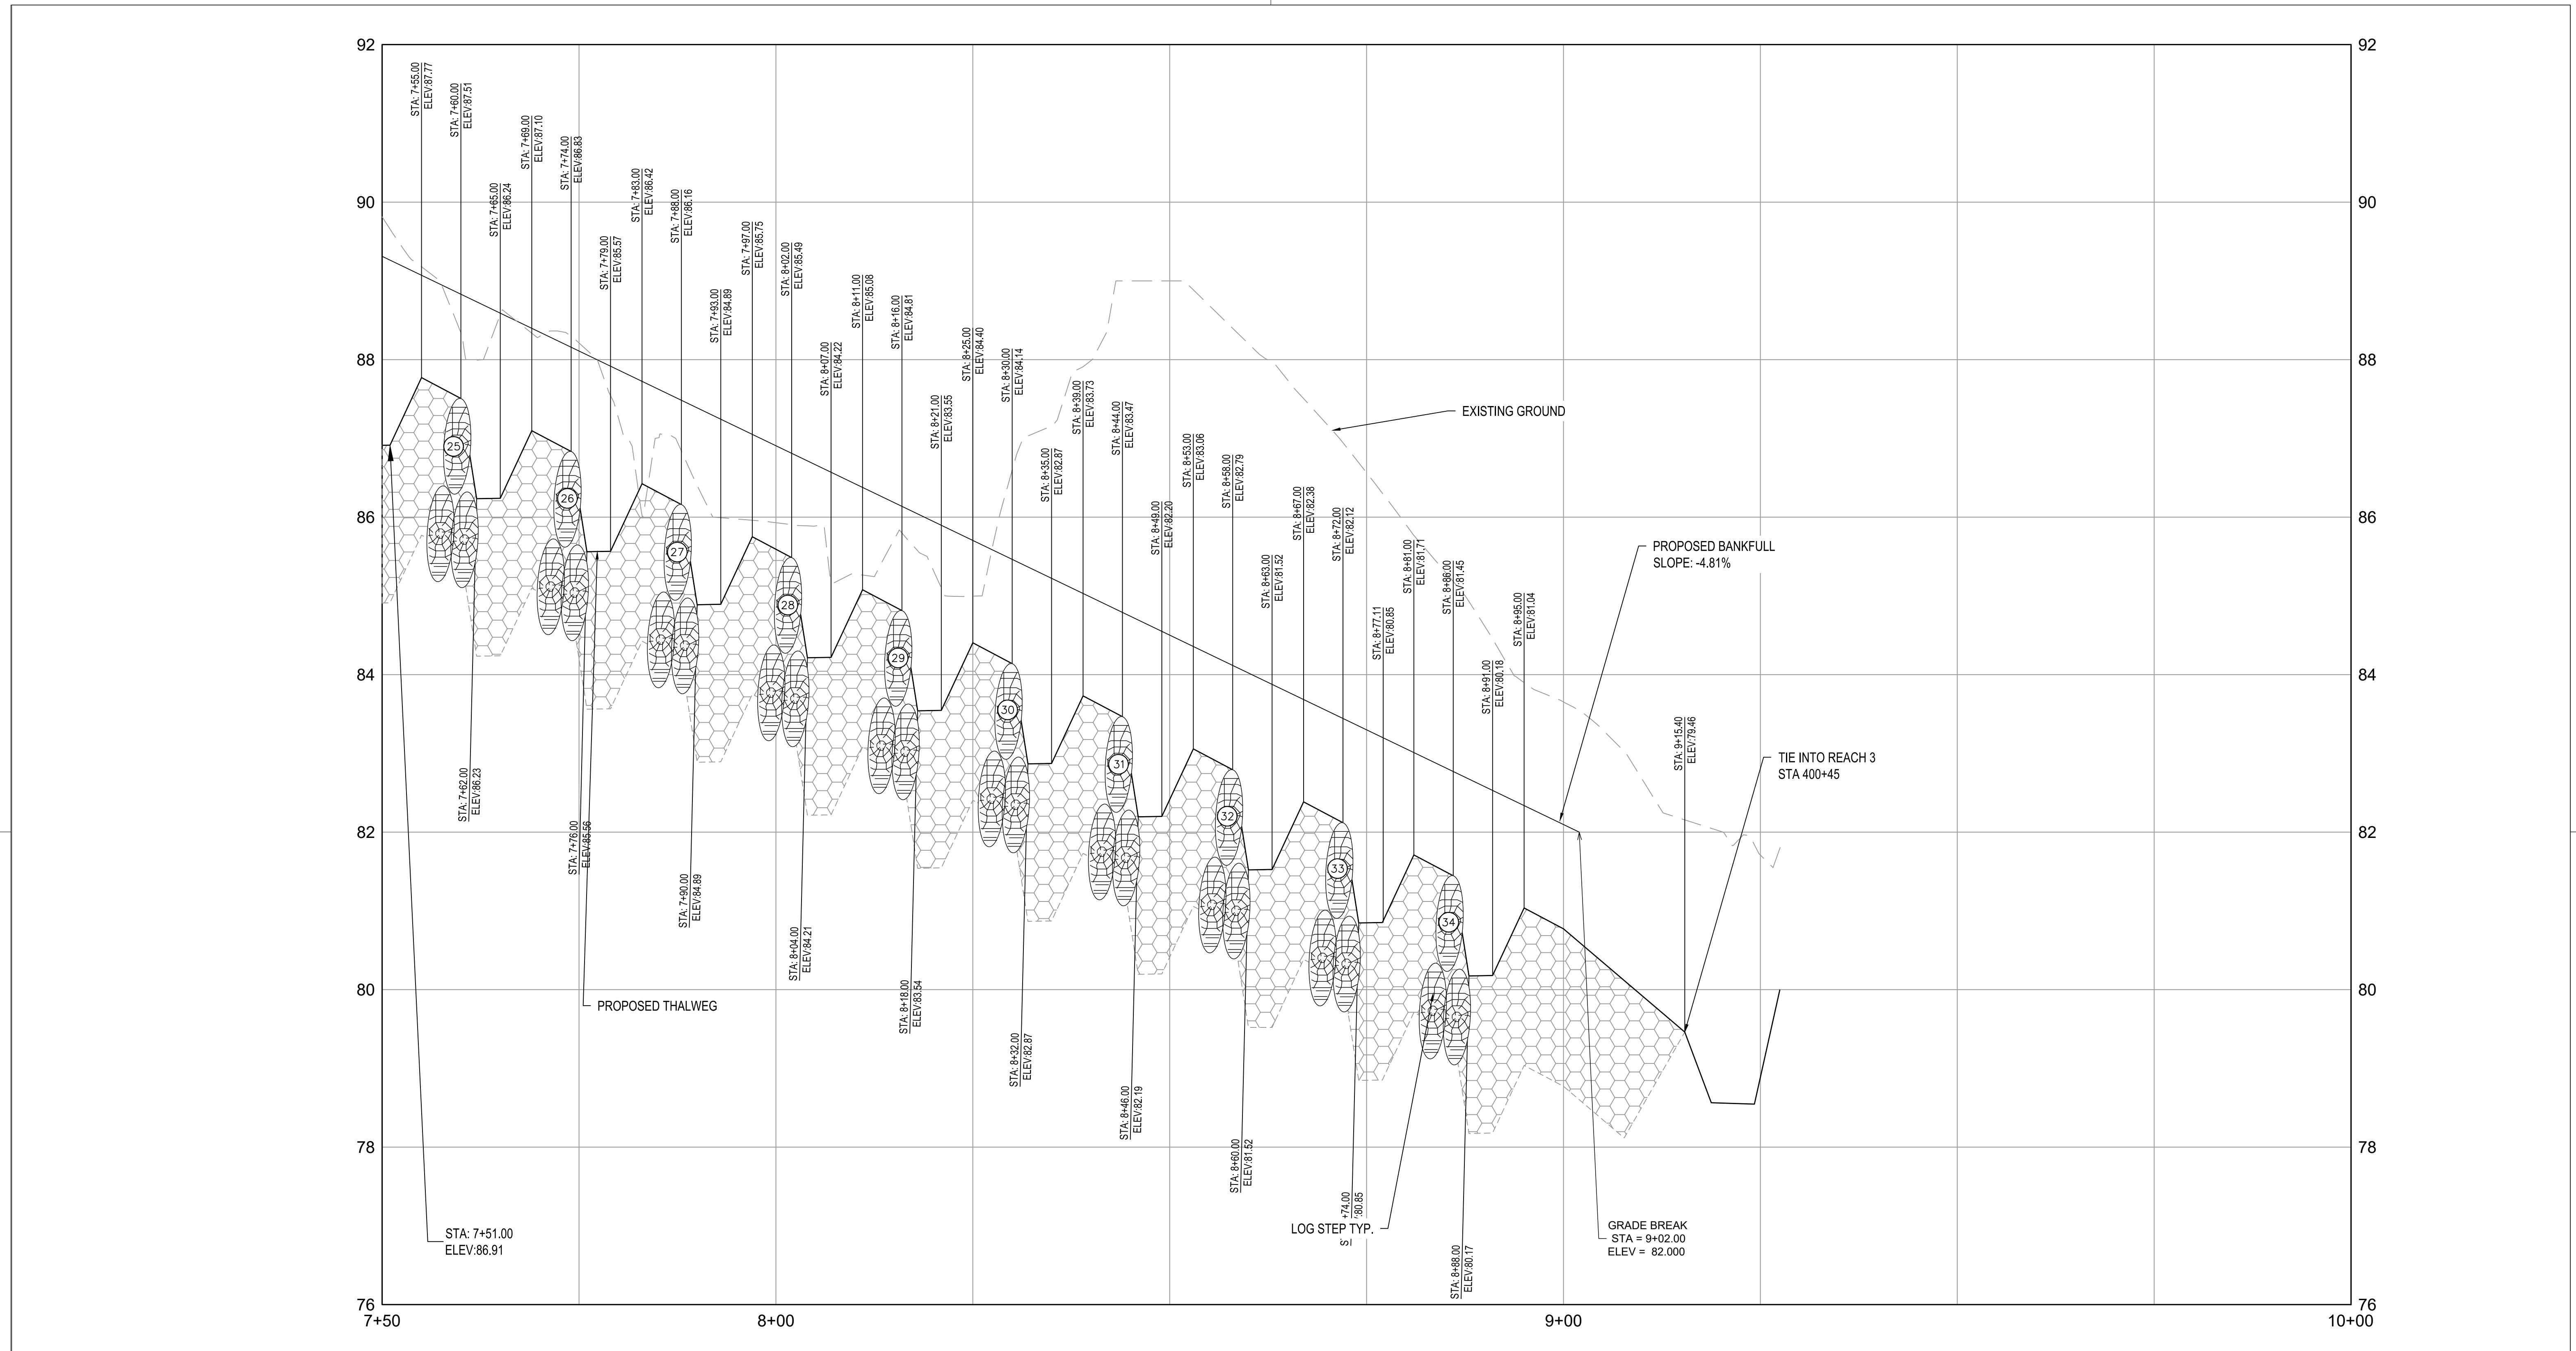

1 REACH 2B PROFILE STA 7+50 - 9+20

SCALE: HORIZONTAL 1" = 10'; VERTICAL 1" = 1'

HORIZONTAL




SCALE IN FEET 1" = 10'

VERTICAL



SCALE IN FEET 1" = 1'

HARFORD COUNTY, MARYLAND	
EDGEWATER VILLAGE PARK	
STREAM RESTORATION	
PROFILE VIEW	
AS SHOWN	
Scale : SEPTEMBER 2025	
Drawing No. PR-04 of PR-08	
Sheet No. 14 of 65	
S/C PLAN # 59914	
Revisions	
GRA-004622-2025	
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S/C PLAN # 59914

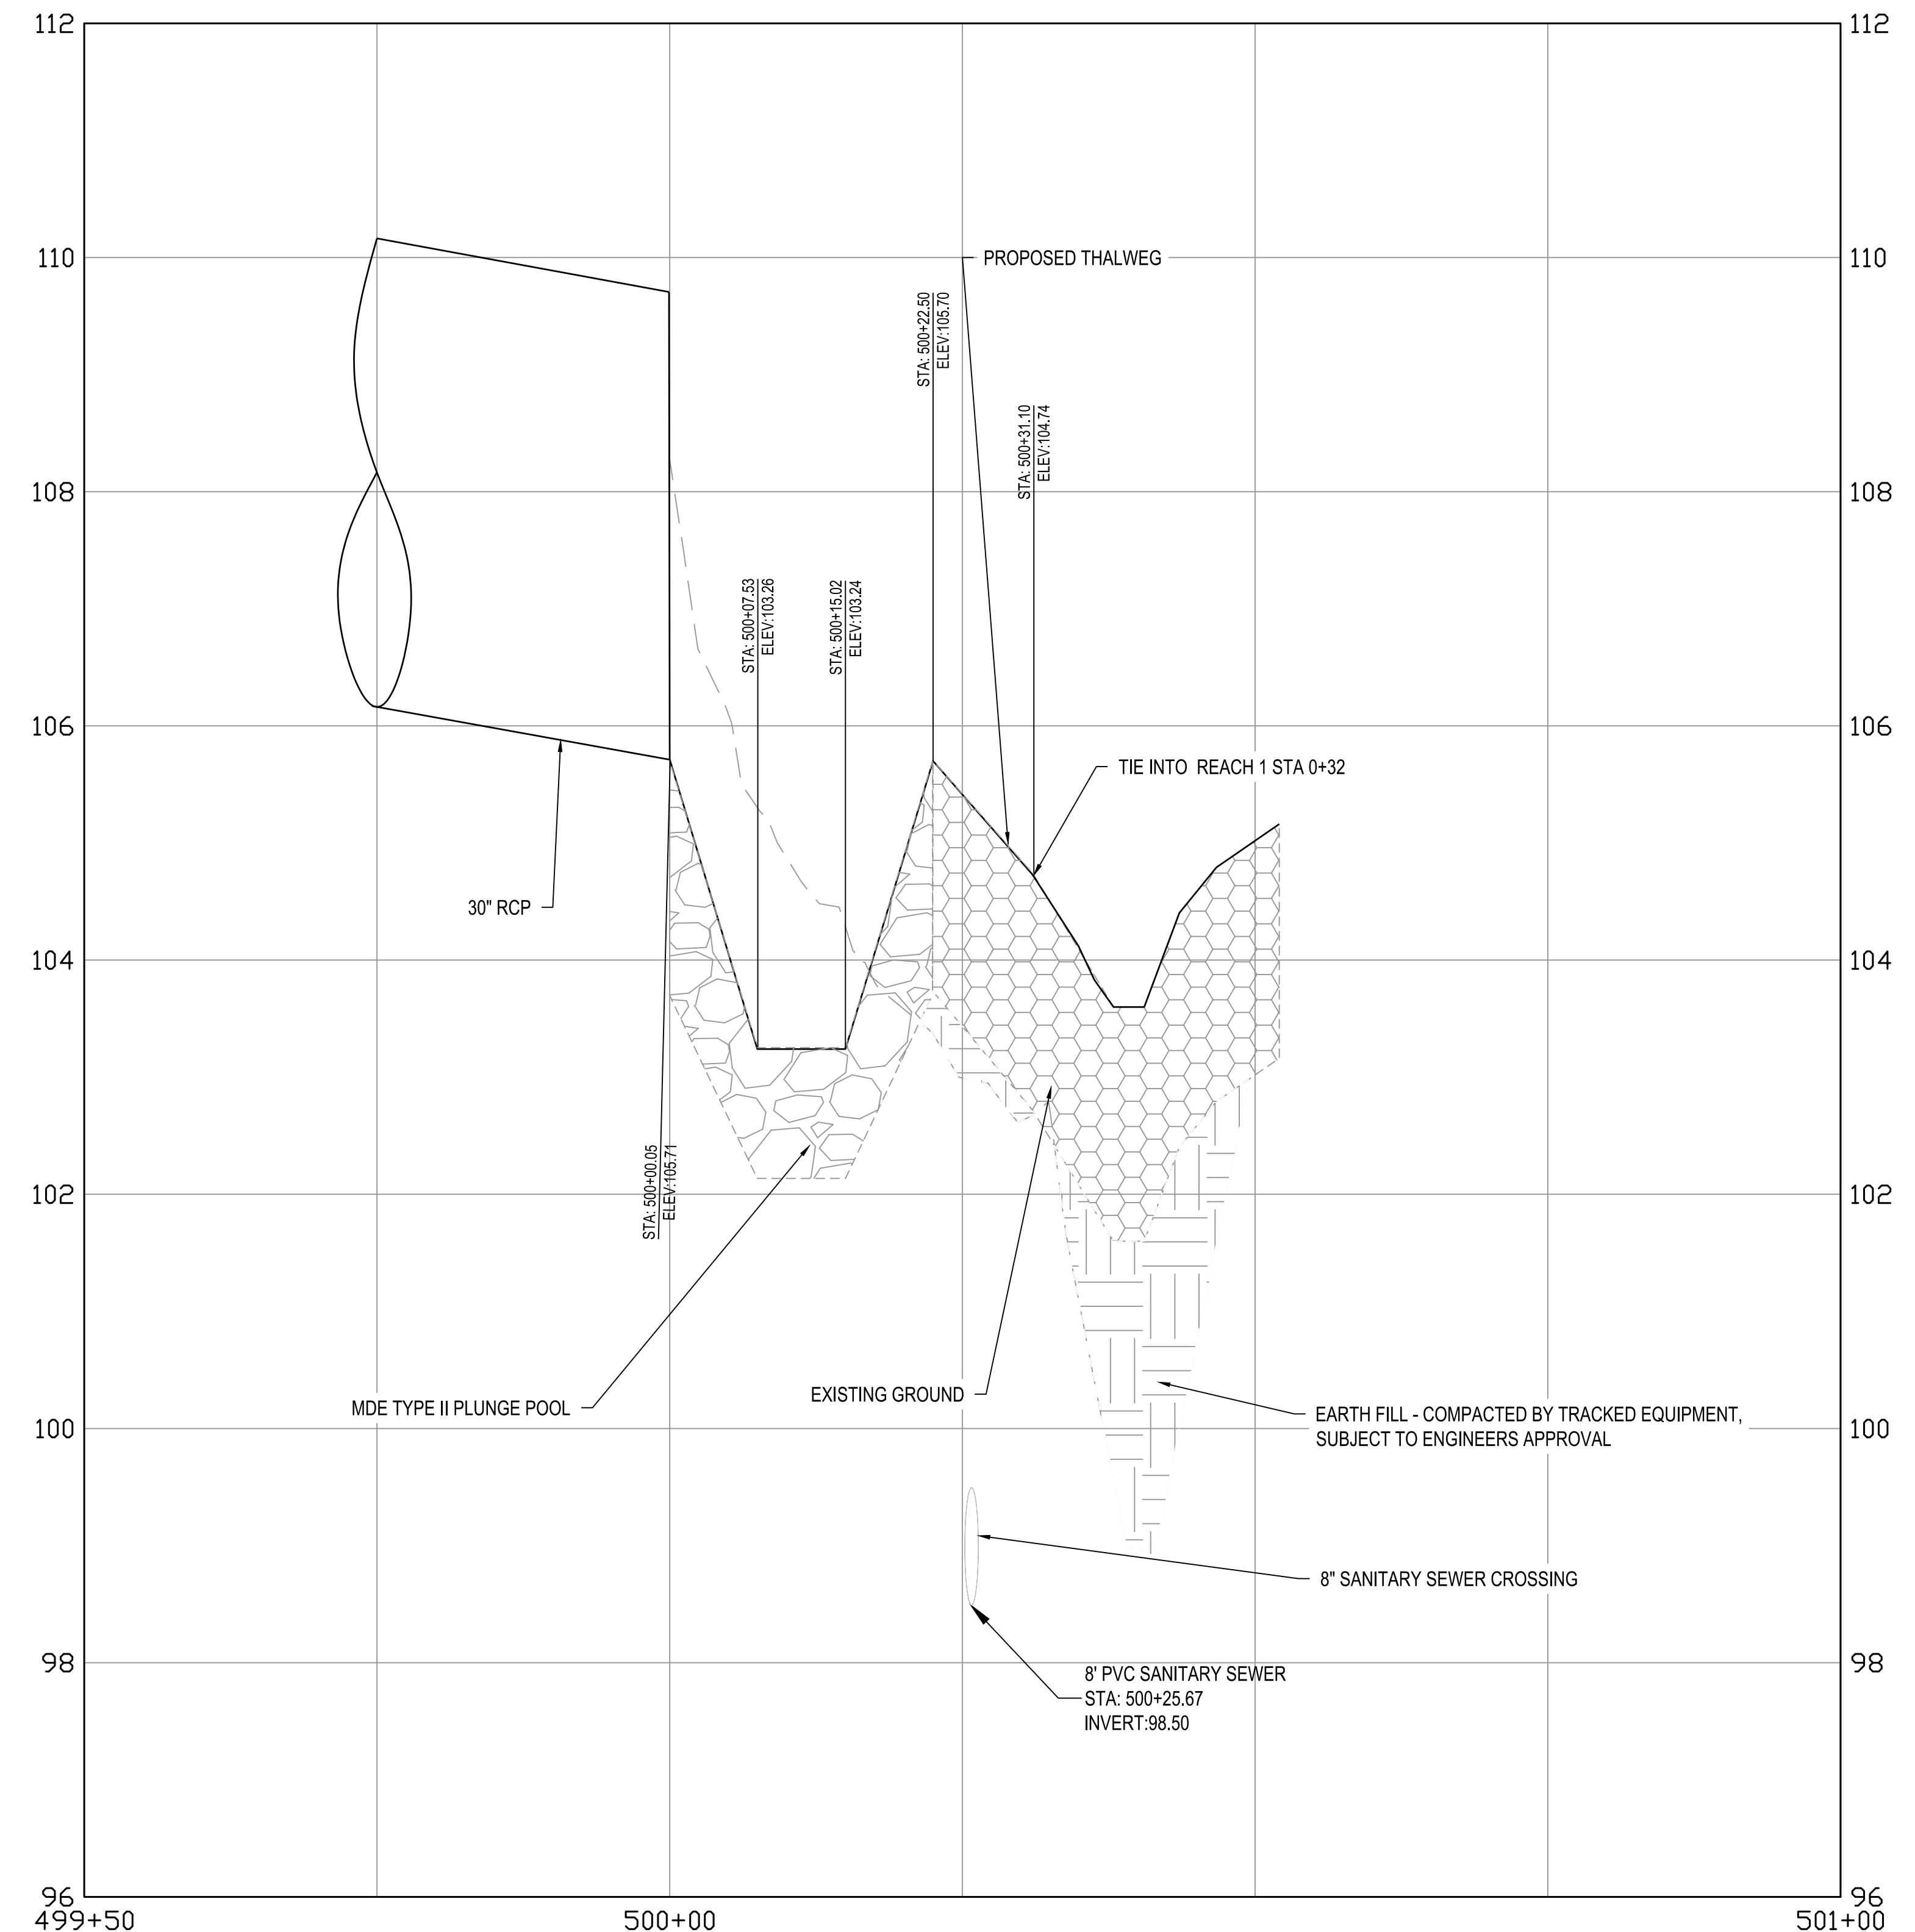Revisions

GRA-004622-2025

SIGN AND SEAL

HARFORD COUNTY, MARYLAND

EDGEMARSH VILLAGE PARK
STREAM RESTORATION
PROFILE VIEW


Drawn By : CA
Designed By : CA
Reviewed By : BWA

Scale : AS SHOWN
Date : SEPTEMBER 2025

PROFESSIONAL CERTIFICATION

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Drawing No. PR-05 of PR-08 Sheet No. 15 of 65

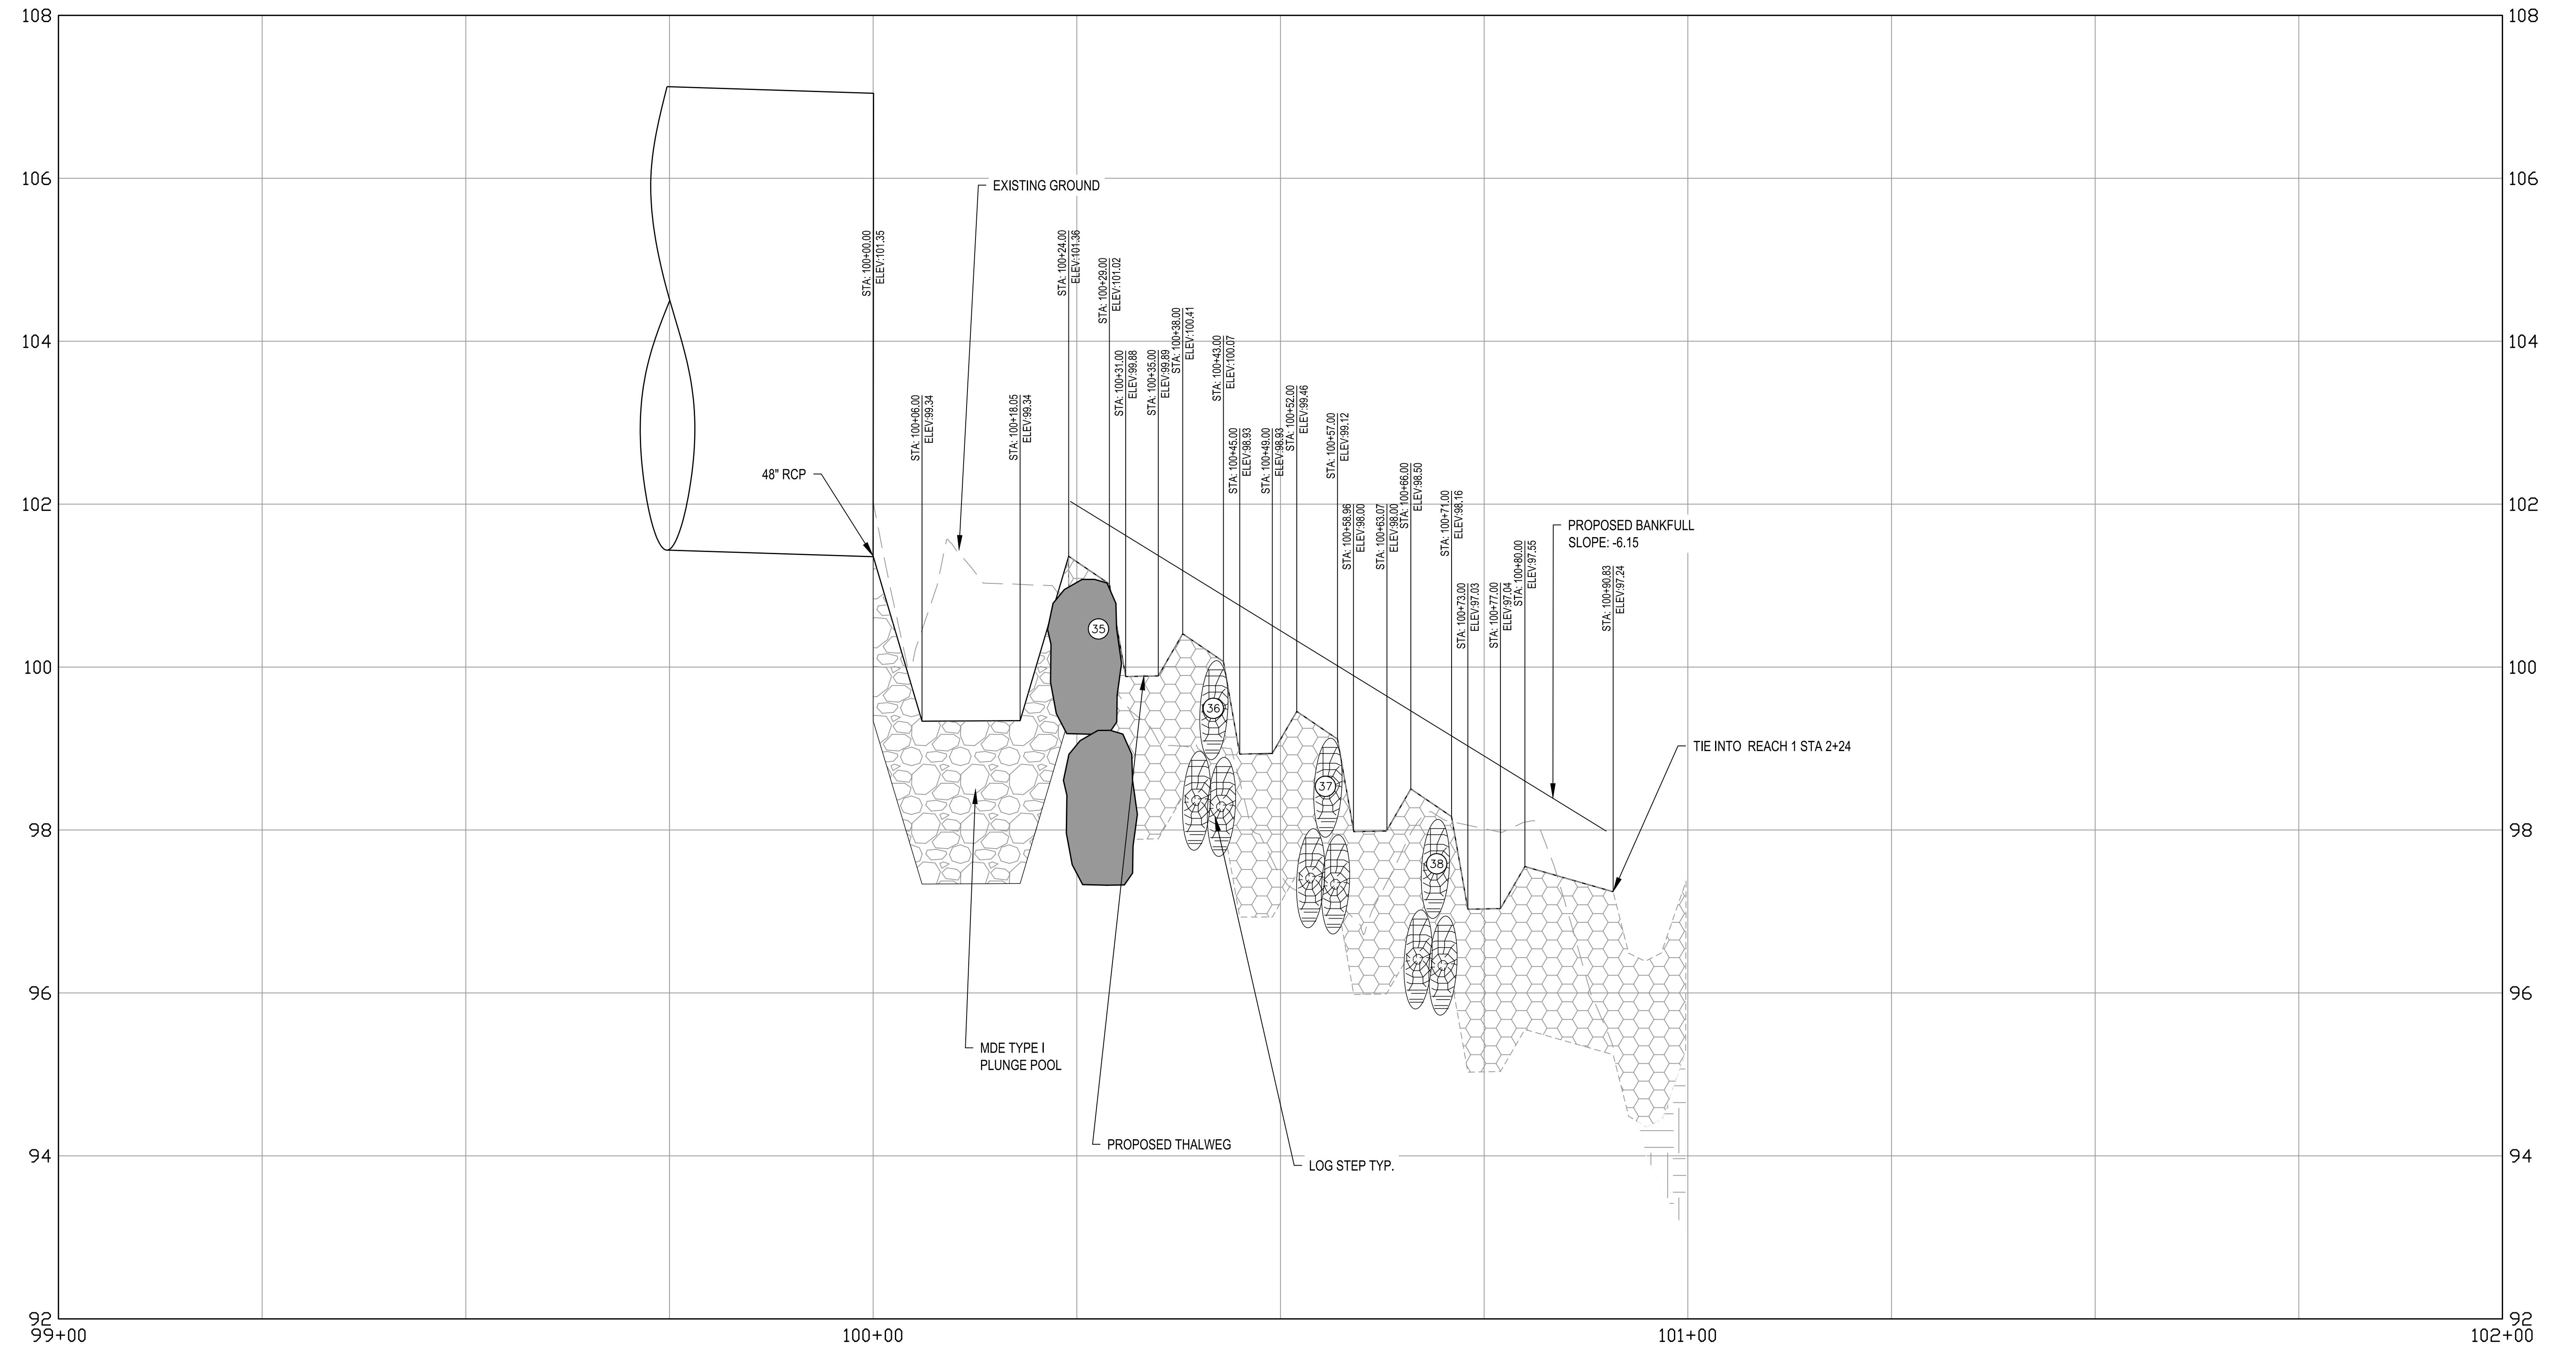

1 LT-1 PROFILE STA 100+00-101+00

SCALE: HORIZONTAL 1" = 10'; VERTICAL 1" = 1'

HORIZONTAL



SCALE IN FEET 1" = 10'

VERTICAL




SCALE IN FEET 1" = 1'

HARFORD COUNTY, MARYLAND

EDGEWATER VILLAGE PARK
STREAM RESTORATION
PROFILE VIEW

S/C PLAN # 59914	Revisions	SIGN AND SEAL
GRA-004622-2025		
Drawn By : CA	AS SHOWN	
Designed By : CA	Scale : SEPTEMBER 2025	
Reviewed By : BWA	Date :	
Drawing No. PR-06	of PR-08	Sheet No. 16 of 65

PROFESSIONAL CERTIFICATION
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THE STATE OF MARYLAND LICENSE NO. XXXXX, EXPIRATION DATE: XX/XX/XXXX.

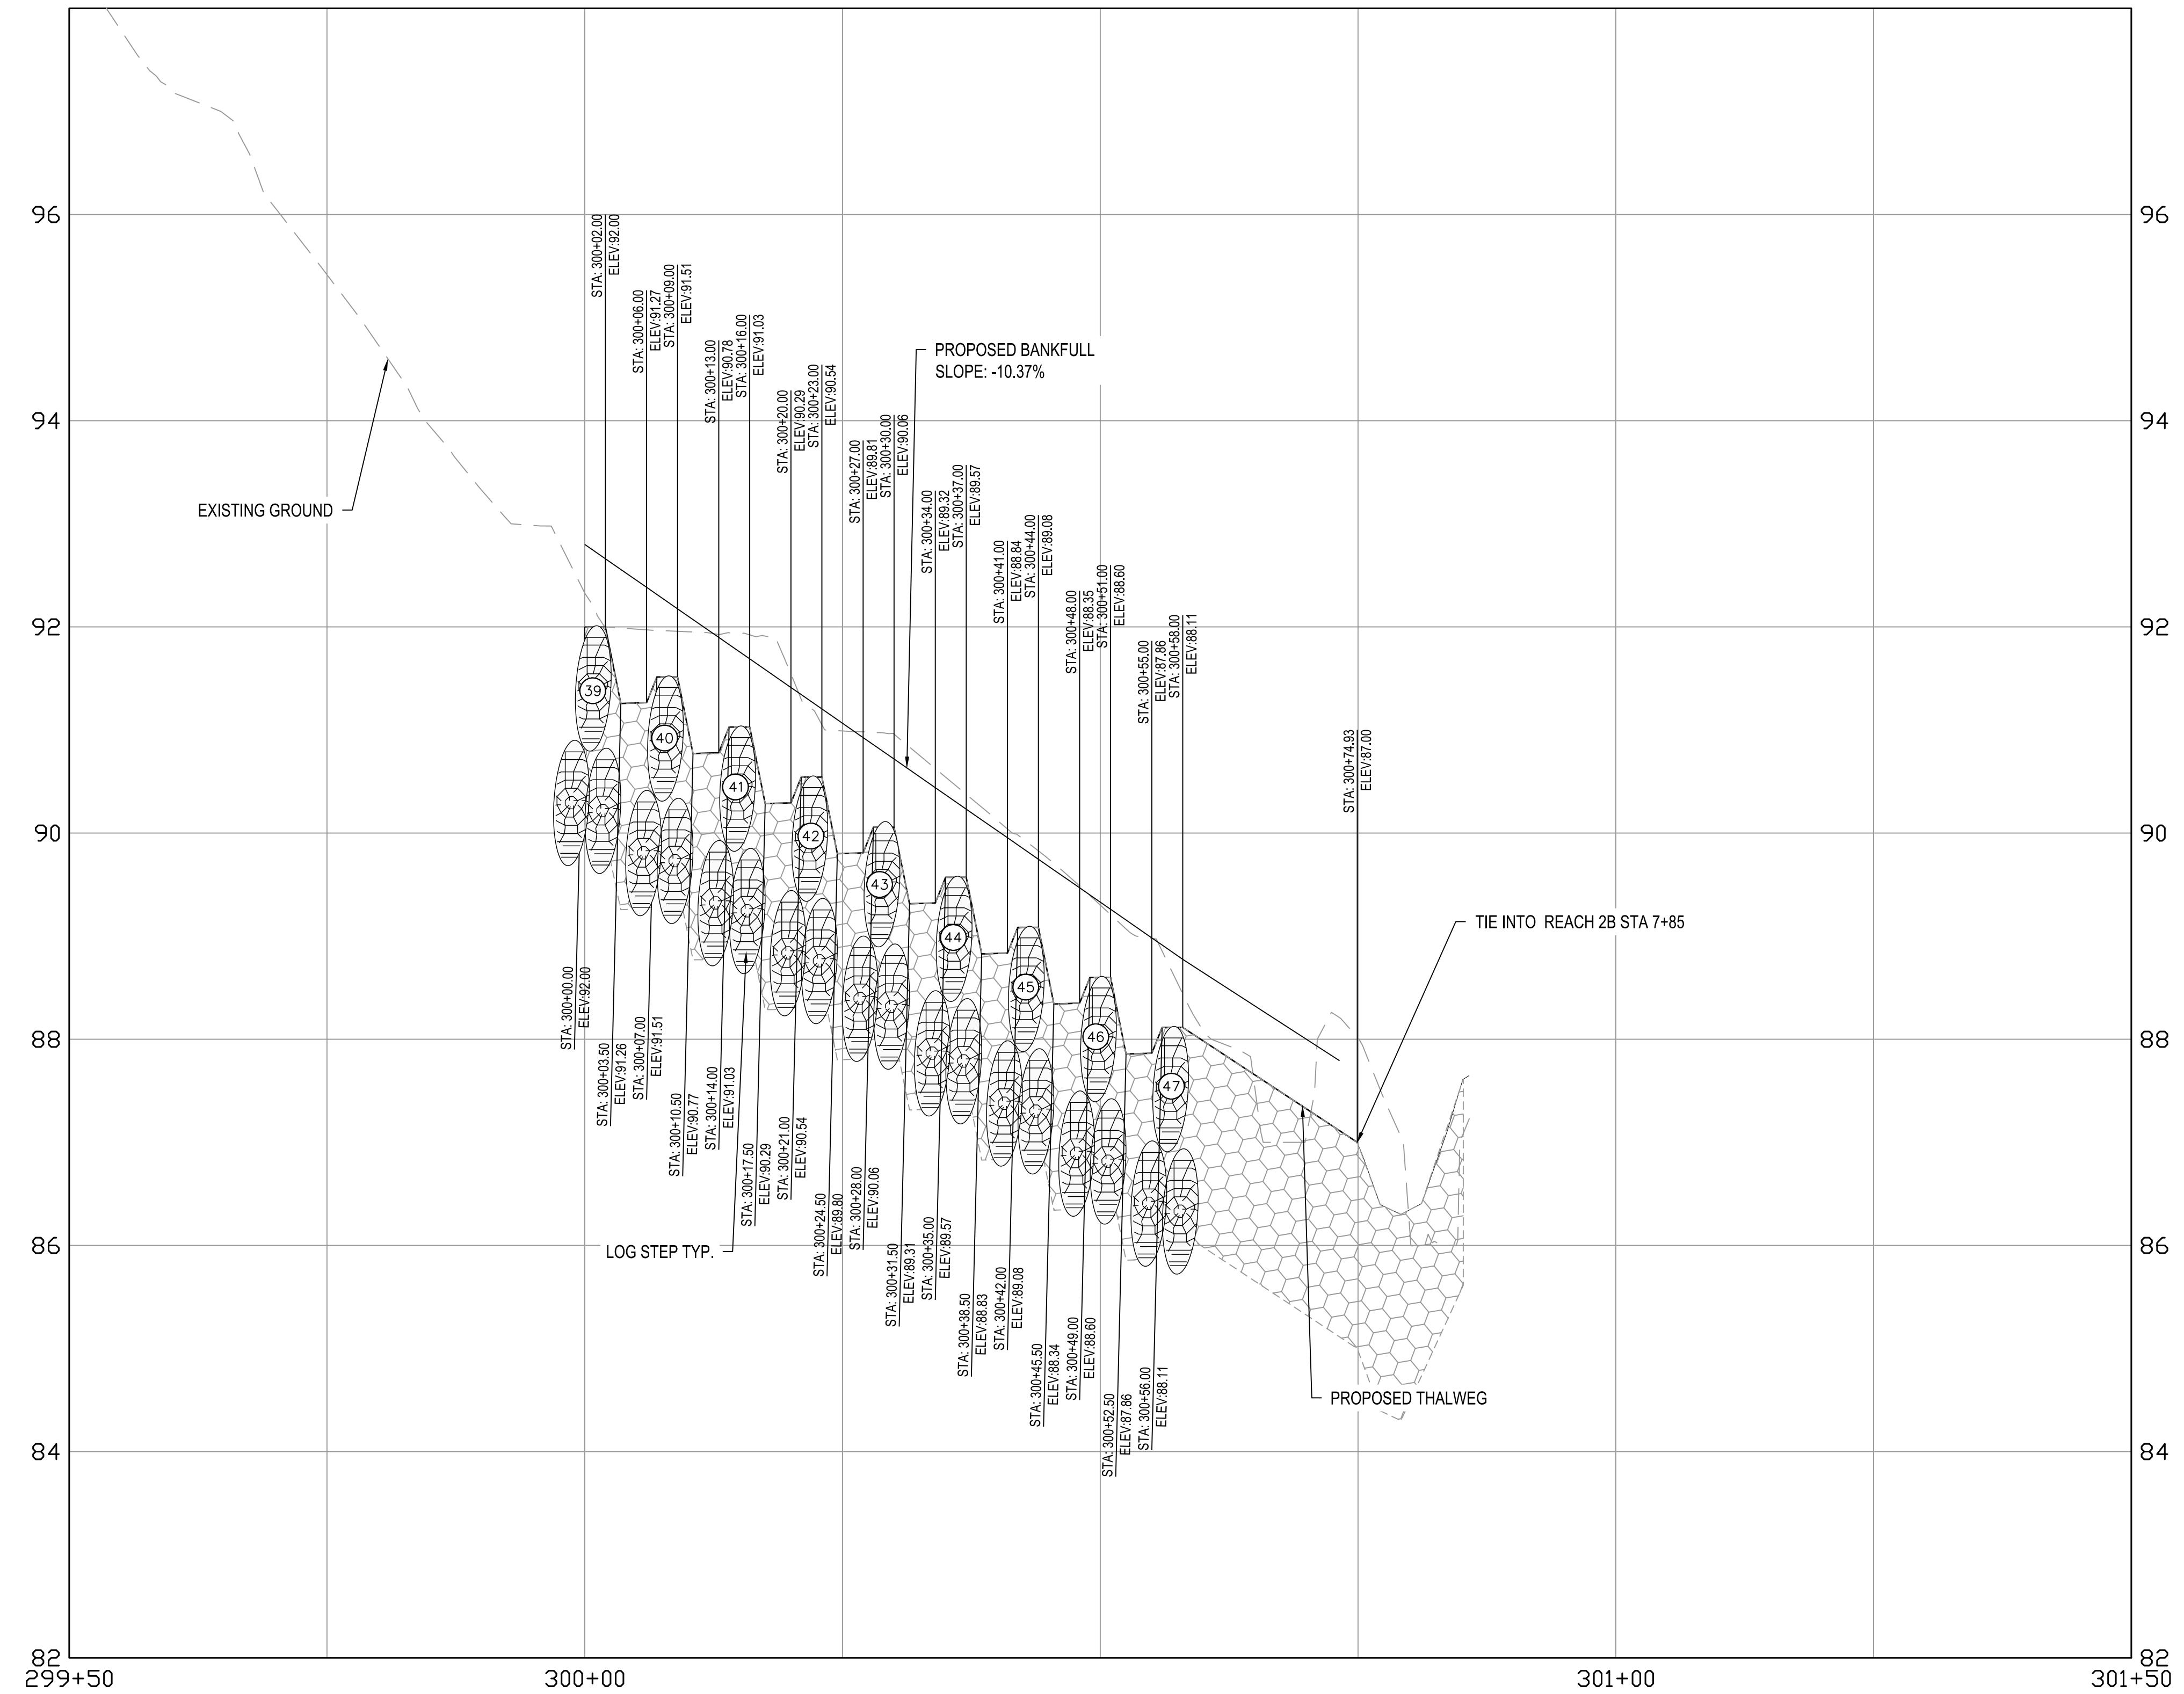

1 LT-2 PROFILE STA 300+00-300+75

SCALE: HORIZONTAL 1" = 10'; VERTICAL 1" = 1'

HORIZONTAL



SCALE IN FEET 1" = 10'

VERTICAL



SCALE IN FEET 1" = 1'

PROFESSIONAL CERTIFICATION

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HARFORD COUNTY, MARYLAND

EDGEWATER VILLAGE PARK
STREAM RESTORATION
PROFILE VIEW


AS SHOWN
Scale : SEPTEMBER 2025
Drawing No. PR-07 of PR-08
Sheet No. 17 of 65

S/C PLAN # 59914

Revisions

GRA-004622-2025

SIGN AND SEAL

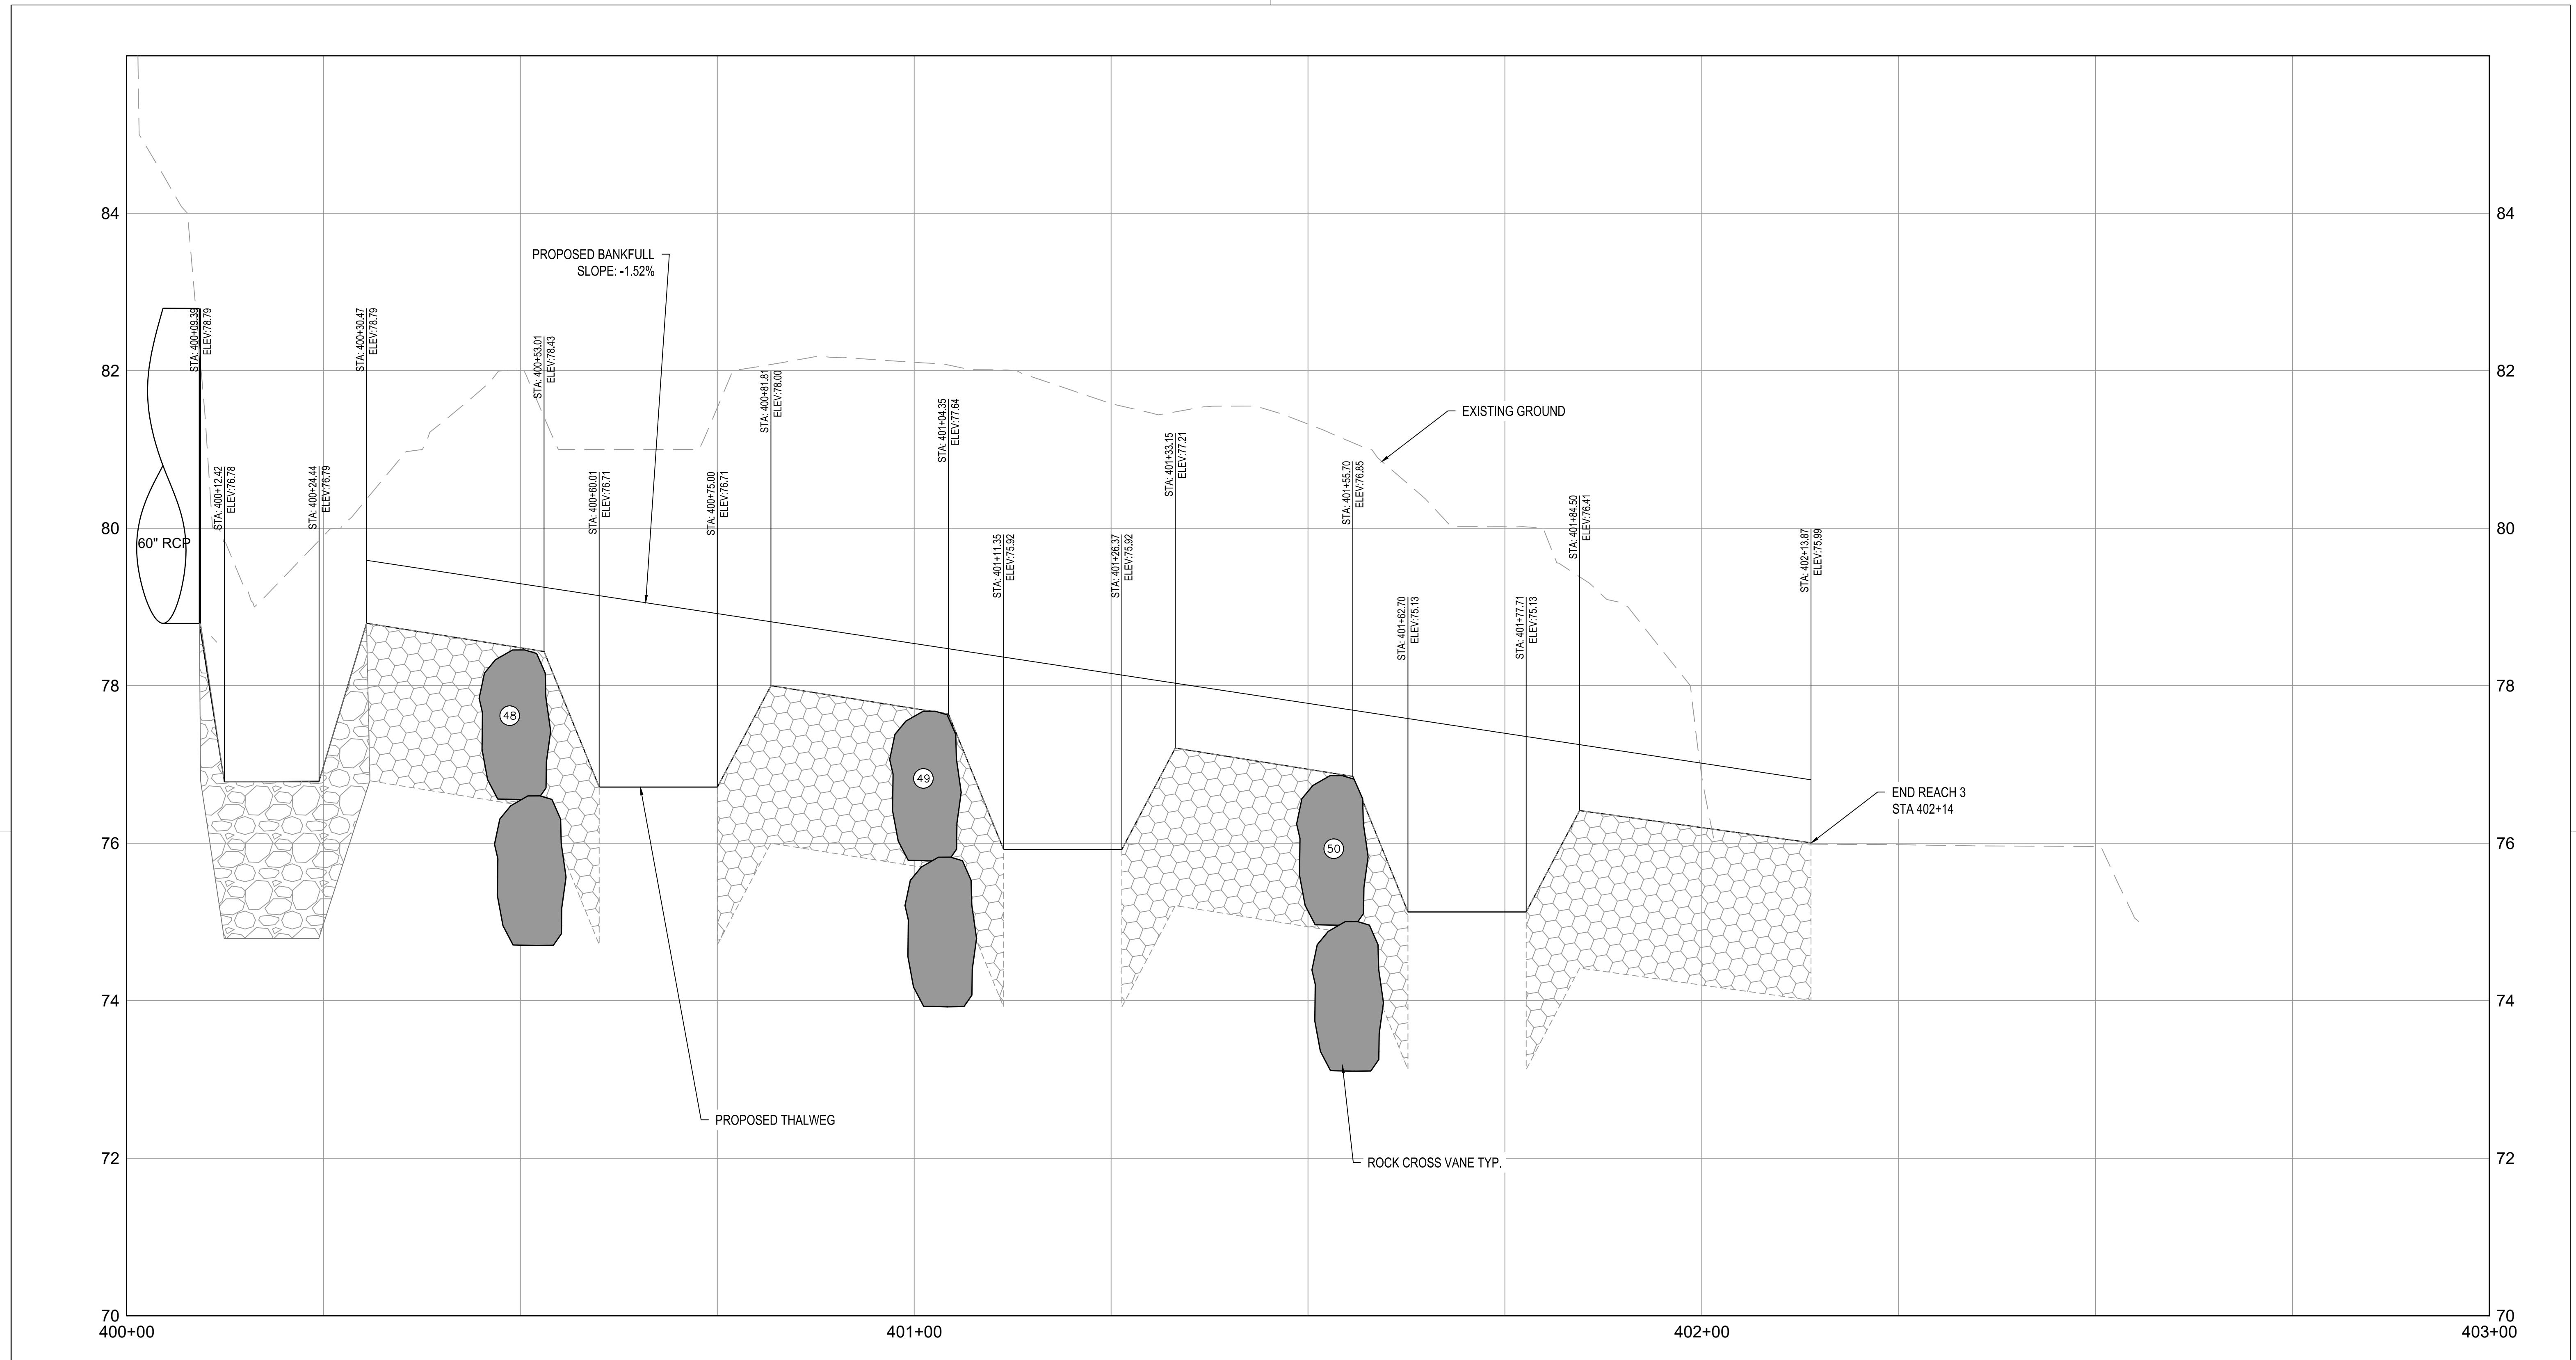

1 REACH 3 STA 400+00-402+14

SCALE: HORIZONTAL 1" = 10'; VERTICAL 1" = 1'

HORIZONTAL



SCALE IN FEET 1" = 10'

VERTICAL



SCALE IN FEET 1" = 1'

S/C PLAN # 59914

Revisions

GRA-004622-2025

SIGN AND SEAL

HARFORD COUNTY, MARYLAND


EDGEWATER VILLAGE PARK
STREAM RESTORATION
PROFILE VIEW

AS SHOWN
Scale :
Date : SEPTEMBER 2025

PROFESSIONAL CERTIFICATION

I HEREBY CERTIFY THAT THESE DOCUMENTS WERE PREPARED OR APPROVED BY ME,
AND THAT I AM A DULY LICENSED PROFESSIONAL ENGINEER UNDER THE LAWS OF
THE STATE OF MARYLAND LICENSE NO. XXXXX, EXPIRATION DATE: XX/XX/XXXX.

Drawn By : CA
Designed By : CA
Reviewed By : BWA
Drawing No. PR-08 of PR-08 Sheet No. 18 of 65

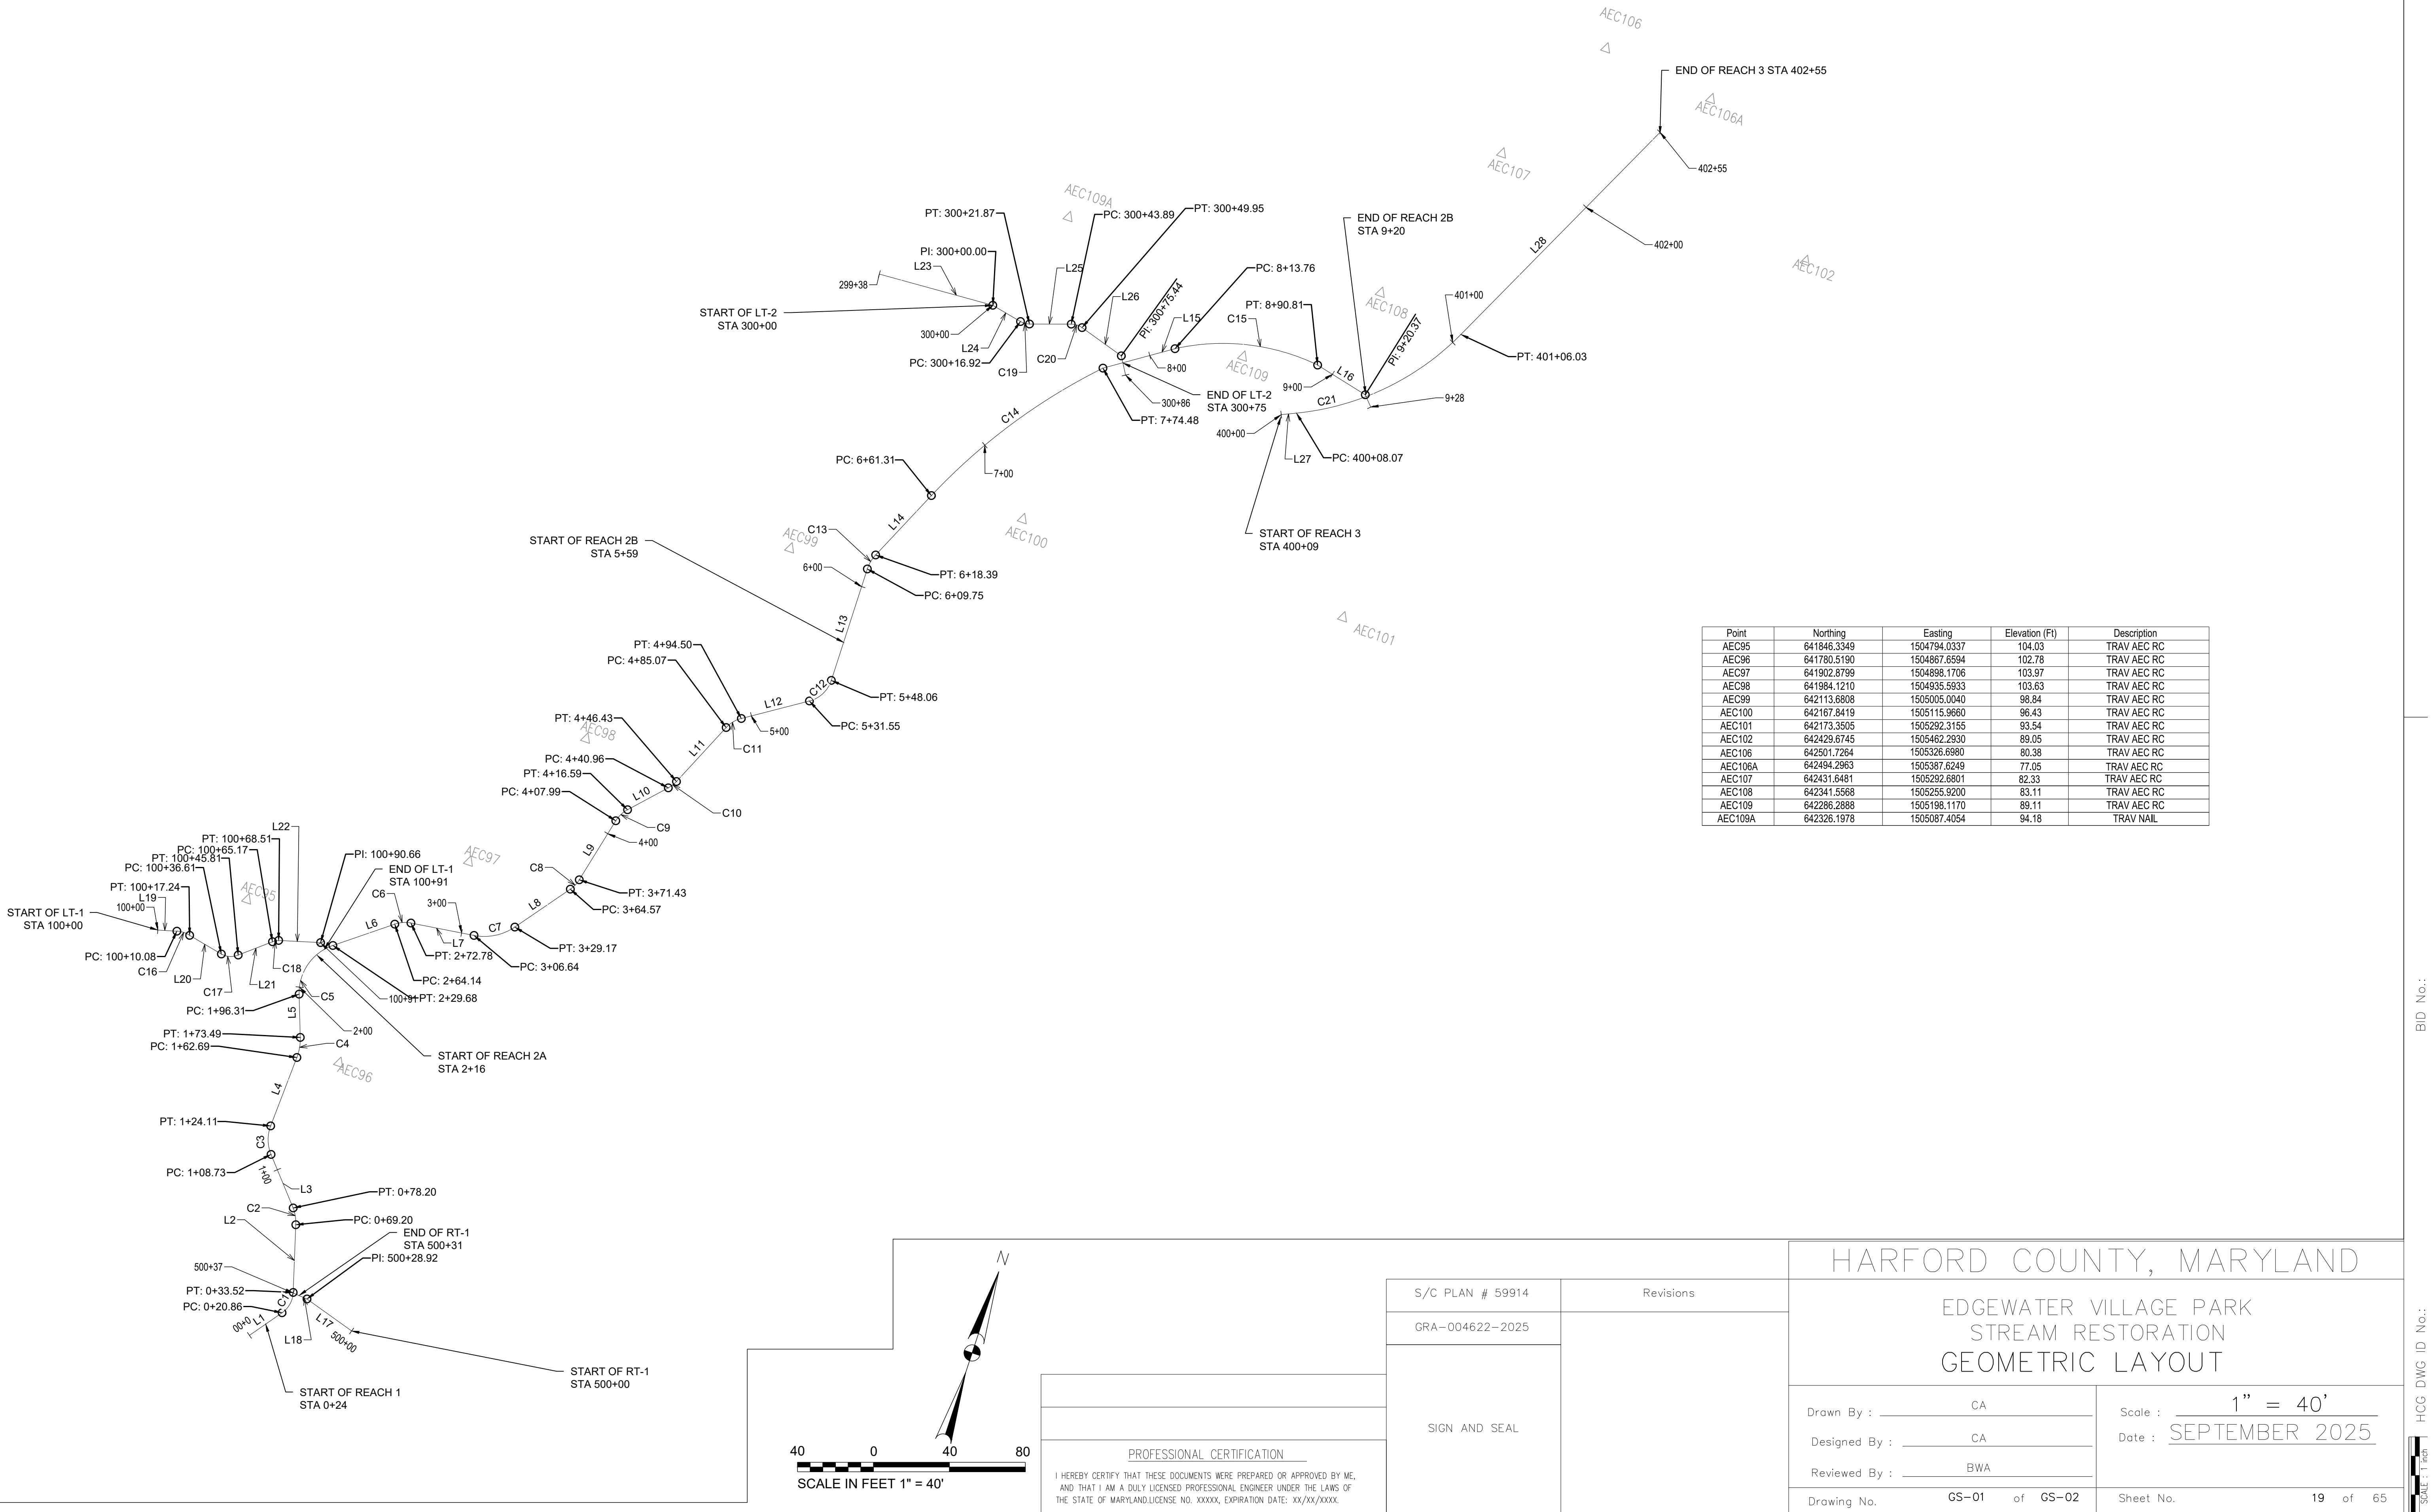

Line Table: Reach 1, 2A & 2B				
Line #	Length	Direction	Start Point	End Point
L1	20.86	N36° 24' 59.47"E	(1504869.31,641629.39)	(1504881.69,641646.18)
L2	35.68	N16° 37' 57.35"W	(1504883.79,641658.21)	(1504873.58,641692.39)
L3	30.53	N41° 19' 12.71"W	(1504869.44,641700.33)	(1504849.28,641723.26)
L4	38.58	N2° 07' 09.23"E	(1504844.24,641737.40)	(1504845.67,641775.96)
L5	22.83	N20° 21' 00.01"W	(1504843.97,641786.55)	(1504836.03,641807.95)
L6	34.47	N52° 07' 59.53"E	(1504844.57,641837.94)	(1504871.78,641859.10)
L7	33.87	N82° 17' 09.49"E	(1504879.65,641862.40)	(1504913.21,641866.95)
L8	35.40	N36° 51' 03.54"E	(1504932.12,641878.06)	(1504953.36,641906.39)
L9	36.56	N12° 53' 01.15"E	(1504956.22,641912.57)	(1504964.37,641948.21)
L10	24.37	N42° 55' 28.73"E	(1504968.35,641955.72)	(1504984.95,641973.57)
L11	38.64	N23° 48' 15.94"E	(1504987.94,641978.12)	(1505003.54,642013.47)
L12	37.05	N56° 45' 33.36"E	(1505009.55,642020.56)	(1505040.54,642040.87)
L13	61.69	N0° 55' 36.10"W	(1505047.95,642054.85)	(1505046.95,642116.53)
L14	42.92	N24° 21' 13.08"E	(1505048.69,642124.92)	(1505066.39,642164.02)
L15	39.28	N56° 05' 09.34"E	(1505130.24,642256.74)	(1505162.84,642278.66)
L16	29.56	S76° 52' 35.75"E	(1505236.73,642294.77)	(1505265.51,642288.06)

Curve Table: Reach 1, 2A & 2B					
Curve #	Radius	Length	Chord Direction	Start Point	End Point
C1	13.67	12.66	N9° 53' 31.06"E	(1504881.69,641646.18)	(1504883.79,641658.21)
C2	23.67	9.01	N27° 31' 58.83"W	(1504873.58,641692.39)	(1504869.44,641700.33)
C3	20.28	15.37	N19° 36' 01.74"W	(1504849.28,641723.26)	(1504844.24,641737.40)
C4	27.53	10.80	N9° 06' 55.39"W	(1504845.67,641775.96)	(1504843.97,641786.55)
C5	26.37	33.36	N15° 53' 29.76"E	(1504836.03,641807.95)	(1504844.57,641837.94)
C6	16.40	8.63	N67° 12' 34.51"E	(1504871.78,641859.10)	(1504879.65,641862.40)
C7	28.40	22.52	N59° 34' 06.51"E	(1504913.21,641866.95)	(1504932.12,641878.06)
C8	16.40	6.86	N24° 52' 02.34"E	(1504953.36,641906.39)	(1504956.22,641912.57)
C9	16.40	8.60	N27° 54' 14.94"E	(1504964.37,641948.21)	(1504968.35,641955.72)
C10	16.40	5.47	N33° 21' 52.33"E	(1504984.95,641973.57)	(1504987.94,641978.12)
C11	16.40	9.43	N40° 16' 54.65"E	(1505003.54,642013.47)	(1505009.55,642020.56)
C12	16.40	16.51	N27° 54' 58.63"E	(1505040.54,642040.87)	(1505047.95,642054.85)
C13	19.58	8.64	N11° 42' 48.49"E	(1505046.95,642116.53)	(1505048.69,642124.92)
C14	317.89	113.17	N34° 33' 09.93"E	(1505066.39,642164.02)	(1505130.24,642256.74)
C15	115.40	77.05	N77° 41' 53.08"E	(1505162.84,642278.66)	(1505236.73,642294.77)

Line Table: RT-1				
Line #	Length	Direction	Start Point	End Point
L17	28.92	N73° 11' 09.53"W	(1504919.49,641648.96)	(1504891.80,641657.33)
L18	7.96	N85° 28' 01.57"W	(1504891.80,641657.33)	(1504883.86,641657.96)

Line Table: LT-1				
Line #	Length	Direction	Start Point	End Point
L19	10.08	N74° 33' 10.71"E	(1504754.66,641815.86)	(1504764.38,641818.54)
L20	19.37	S78° 23' 34.73"E	(1504771.45,641818.61)	(1504790.42,641814.72)
L21	19.37	N49° 58' 37.55"E	(1504799.00,641817.05)	(1504813.83,641829.51)
L22	22.15	N74° 08' 11.52"E	(1504816.66,641831.23)	(1504837.97,641837.29)

Line Table: LT-2				
Line #	Length	Direction	Start Point	End Point
L23	61.97	N86° 32' 28.06"E	(1505002.77,642265.59)	(1505064.63,642269.33)
L24	16.92	S78° 24' 04.95"E	(1505064.63,642269.33)	(1505081.20,642265.93)
L25	22.02	N71° 20' 18.44"E	(1505086.08,642266.23)	(1505106.95,642273.28)
L26	25.48	S73° 06' 16.99"E	(1505112.92,642273.37)	(1505137.30,642265.97)

Line Table: Reach 3				
Line #	Length	Direction	Start Point	End Point
L27	8.07	N65° 27' 57.94"E	(1505227.02,642263.88)	(1505234.36,642267.22)
L28	149.46	N25° 43' 20.91"E	(1505302.95,642334.40)	(1505367.82,642469.05)

Curve Table: LT-1					
Curve #	Radius	Length	Chord Direction	Start Point	End Point
C16	13.57	7.15	N89° 24' 22.58"E	(1504764.38,641818.54)	(1504771.45,641818.61)
C17	10.14	9.20	N74° 45' 29.12"E	(1504790.42,641814.72)	(1504799.00,641817.05)
C18	9.93	3.33	N58° 39' 13.77"E	(1504813.83,641829.51)	(1504816.66,641831.23)

Curve Table: LT-2					
Curve #	Radius	Length	Chord Direction	Start Point	End Point
C19	9.37	4.95	N86° 28' 06.75"E	(1505081.20,642265.93)	(1505086.08,642266.23)
C20	9.78	6.07	N89° 07' 00.72"E	(1505106.95,642273.28)	(1505112.92,642273.37)

Curve Table: Reach 3					
Curve #	Radius	Length	Chord Direction	Start Point	End Point


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No.	Reach 1 Structures (Thalweg Station)	IT	Northing:	Easting:	El.	Arm Grade	Description
1	0+46 ROCK STEP		641669.71	1504880.37	103.19		Step
2	0+61 LOG STEP		641684.44	1504875.95	102.77		Step
3	0+77 LOG STEP		641699.37	1504870.13	101.97		Step
4	0+93 LOG STEP		641711.49	1504859.63	101.35		Step
5	1+09 LOG STEP		641723.48	1504849.12	100.74		Step
6	1+25 LOG STEP		641738.32	1504844.23	100.12		Step
7	1+41 LOG STEP		641754.27	1504844.87	99.51		Step
8	1+57 LOG STEP		641770.27	1504845.46	98.89		Step
9	1+73 LOG STEP		641786.09	1504844.12	98.28		Step
10	1+89 LOG STEP		641801.06	1504838.49	97.66		Step
11	2+05 LOG STEP		641816.59	1504834.40	97.05		Step


No.	Reach 2 Structures (Thalweg Station)	IT	Northing:	Easting:	El.	Arm Grade	Description
1	2+55 ROCK CROSS VANE		641862.60	1504868.13	95.93	4.0%	Arm Tie
2			641854.54	1504863.52	95.56		Arm Tip
3			641853.28	1504864.43	95.56		Center
4			641851.75	1504865.61	95.56		Arm Tip
5			641854.79	1504874.39	95.93	4.0%	Arm Tie
12	2+87 LOG CROSS VANE		641870.50	1504901.86	95.19	4.0%	Arm Tie
13			641866.29	1504893.48	94.81		Arm Tip
14			641864.31	1504893.74	94.81		Center
15			641862.33	1504894.01	94.81		Arm Tip
16	3+19 LOG CROSS VANE		641860.55	1504903.23	95.19	4.0%	Arm Tie
17			641881.14	1504928.07	94.61	4.0%	Arm Tie
18			641872.86	1504923.64	94.24		Arm Tip
19			641871.18	1504924.72	94.24		Center
20			641869.49	1504925.80	94.24		Arm Tip
21	3+51 LOG CROSS VANE		641873.03	1504934.47	94.61	4.0%	Arm Tie
22			641905.66	1504946.56	94.05	4.0%	Arm Tie
23			641896.74	1504943.61	93.67		Arm Tip
24			641895.53	1504945.22	93.67		Center
25			641894.34	1504946.80	93.67		Arm Tip
26			641899.67	1504954.56	94.05	4.0%	Arm Tie
27	3+83 LOG CROSS VANE		641933.64	1504955.92	93.47	4.0%	Arm Tie
28			641924.29	1504956.85	93.09		Arm Tip
29			641923.85	1504958.80	93.09		Center
30			641923.40	1504960.77	93.09		Arm Tip
31			641931.43	1504965.67	93.47	4.0%	Arm Tie
32	4+15 LOG CROSS VANE		641964.31	1504969.51	92.90	4.0%	Arm Tie
33			641955.67	1504965.80	92.52		Arm Tip
34			641954.51	1504967.33	92.52		Center
35			641953.35	1504968.84	92.52		Arm Tip
36			641957.79	1504977.13	92.90	4.0%	Arm Tie
37	4+47 LOG CROSS VANE		641988.81	1504987.19	92.32	4.0%	Arm Tie
38			641979.44	1504986.34	91.95		Arm Tip
39			641978.64	1504988.17	91.95		Center
40			641978.04	1504990.02	91.95		Arm Tip
41			641984.82	1504996.37	92.32	4.0%	Arm Tie
42	4+79 LOG CROSS VANE		642018.05	1505000.33	91.75	4.0%	Arm Tie
43			642008.72	1505000.26	91.37		Arm Tip
44			642007.91	1505001.09	91.37		Center
45			642007.12	1505002.88	91.37		Arm Tip
46			642013.78	1505009.50	91.75	4.0%	Arm Tie
47	5+21 ROCK CROSS VANE		642044.09	1505036.33	90.97	4.0%	Arm Tie
48			642036.83	1505030.79	90.60		Arm Tip
49			642035.13	1505031.78	90.60		Center
50			642033.82	1505032.81	90.60		Arm Tip
51			642035.78	1505041.89	90.97	4.0%	Arm Tie
52	6+23 ROCK CROSS VANE		642140.58	1505050.32	89.84	4.0%	Arm Tie
53			642131.21	1505049.74	89.46		Arm Tip
54			642130.53	1505051.23	89.46		Center
55			642129.88	1505052.51	89.46		Arm Tip
56			642136.38	1505059.40	89.84	4.0%	Arm Tie
57	6+68 LOG CROSS VANE		642181.29	1505069.20	89.39	4.0%	Arm Tie
58			642171.99	1505067.98	89.02		Arm Tip
59			642171.15	1505069.72	89.02		Center
60			642170.29	1505071.66	89.02		Arm Tip
61			642177.05	1505078.17	89.39	4.0%	Arm Tie
62	7+12 LOG CROSS VANE		642220.08	1505092.88	89.04	4.0%	Arm Tie
63			642211.23	1505089.82	88.66		Arm Tip
64			642209.83	1505091.86	88.66		Center
65			642208.93	1505093.16	88.66		Arm Tip
66			642214.21	1505100.97	89.04	4.0%	Arm Tie

POINT GUIDE FOR CONTROL POINTS

ROCK AND LOG CROSS VANE

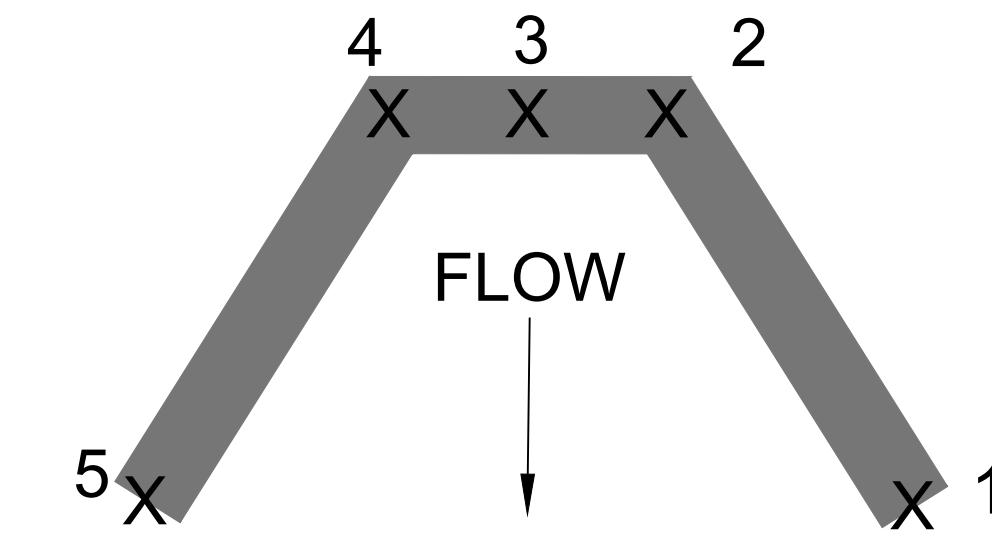



ROCK AND LOG STEP

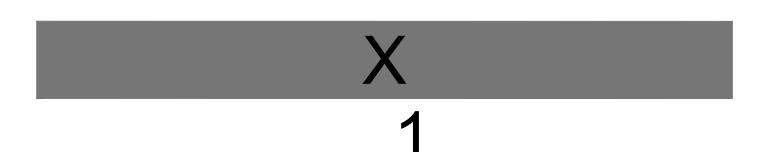

NOTE: LOOKING DOWNSTREAM GRADE CONTROL VANE STRUCTURE IDS INCREASE FROM LEFT BANK SIDE TO RIGHT BANK SIDE

No.	LT-1 Structures (Thalweg Station)	IT	Northing:	Easting:	El.	Arm Grade	Description
35	100+29 ROCK STEP		641816.24	1504783.00	101.02		Step
36	100+43 LOG STEP		641815.57	1504796.77	100.07		Step
37	100+57 LOG STEP		641824.29	1504807.51	99.12		Step
38	100+71 LOG STEP		641831.92	1504819.08	98.16		Step

No.	LT-2 Structures (Thalweg Station)	IT	Northing:	Easting:	El.	Arm Grade	Description
39	300+02 LOG STEP		642268.93	1505066.66	92.00		Step
40	300+09 LOG STEP		642267.50	1505073.59	91.51		Step
41	300+16 LOG STEP		642266.17	1505080.38	91.03		Step
42	300+23 LOG STEP		642266.61	1505087.20	90.54		Step
43	300+30 LOG STEP		642268.84	1505093.79	90.06		Step
44	300+37 LOG STEP		642271.08	1505100.42	89.57		Step
45	300+44 LOG STEP		642273.28</td				

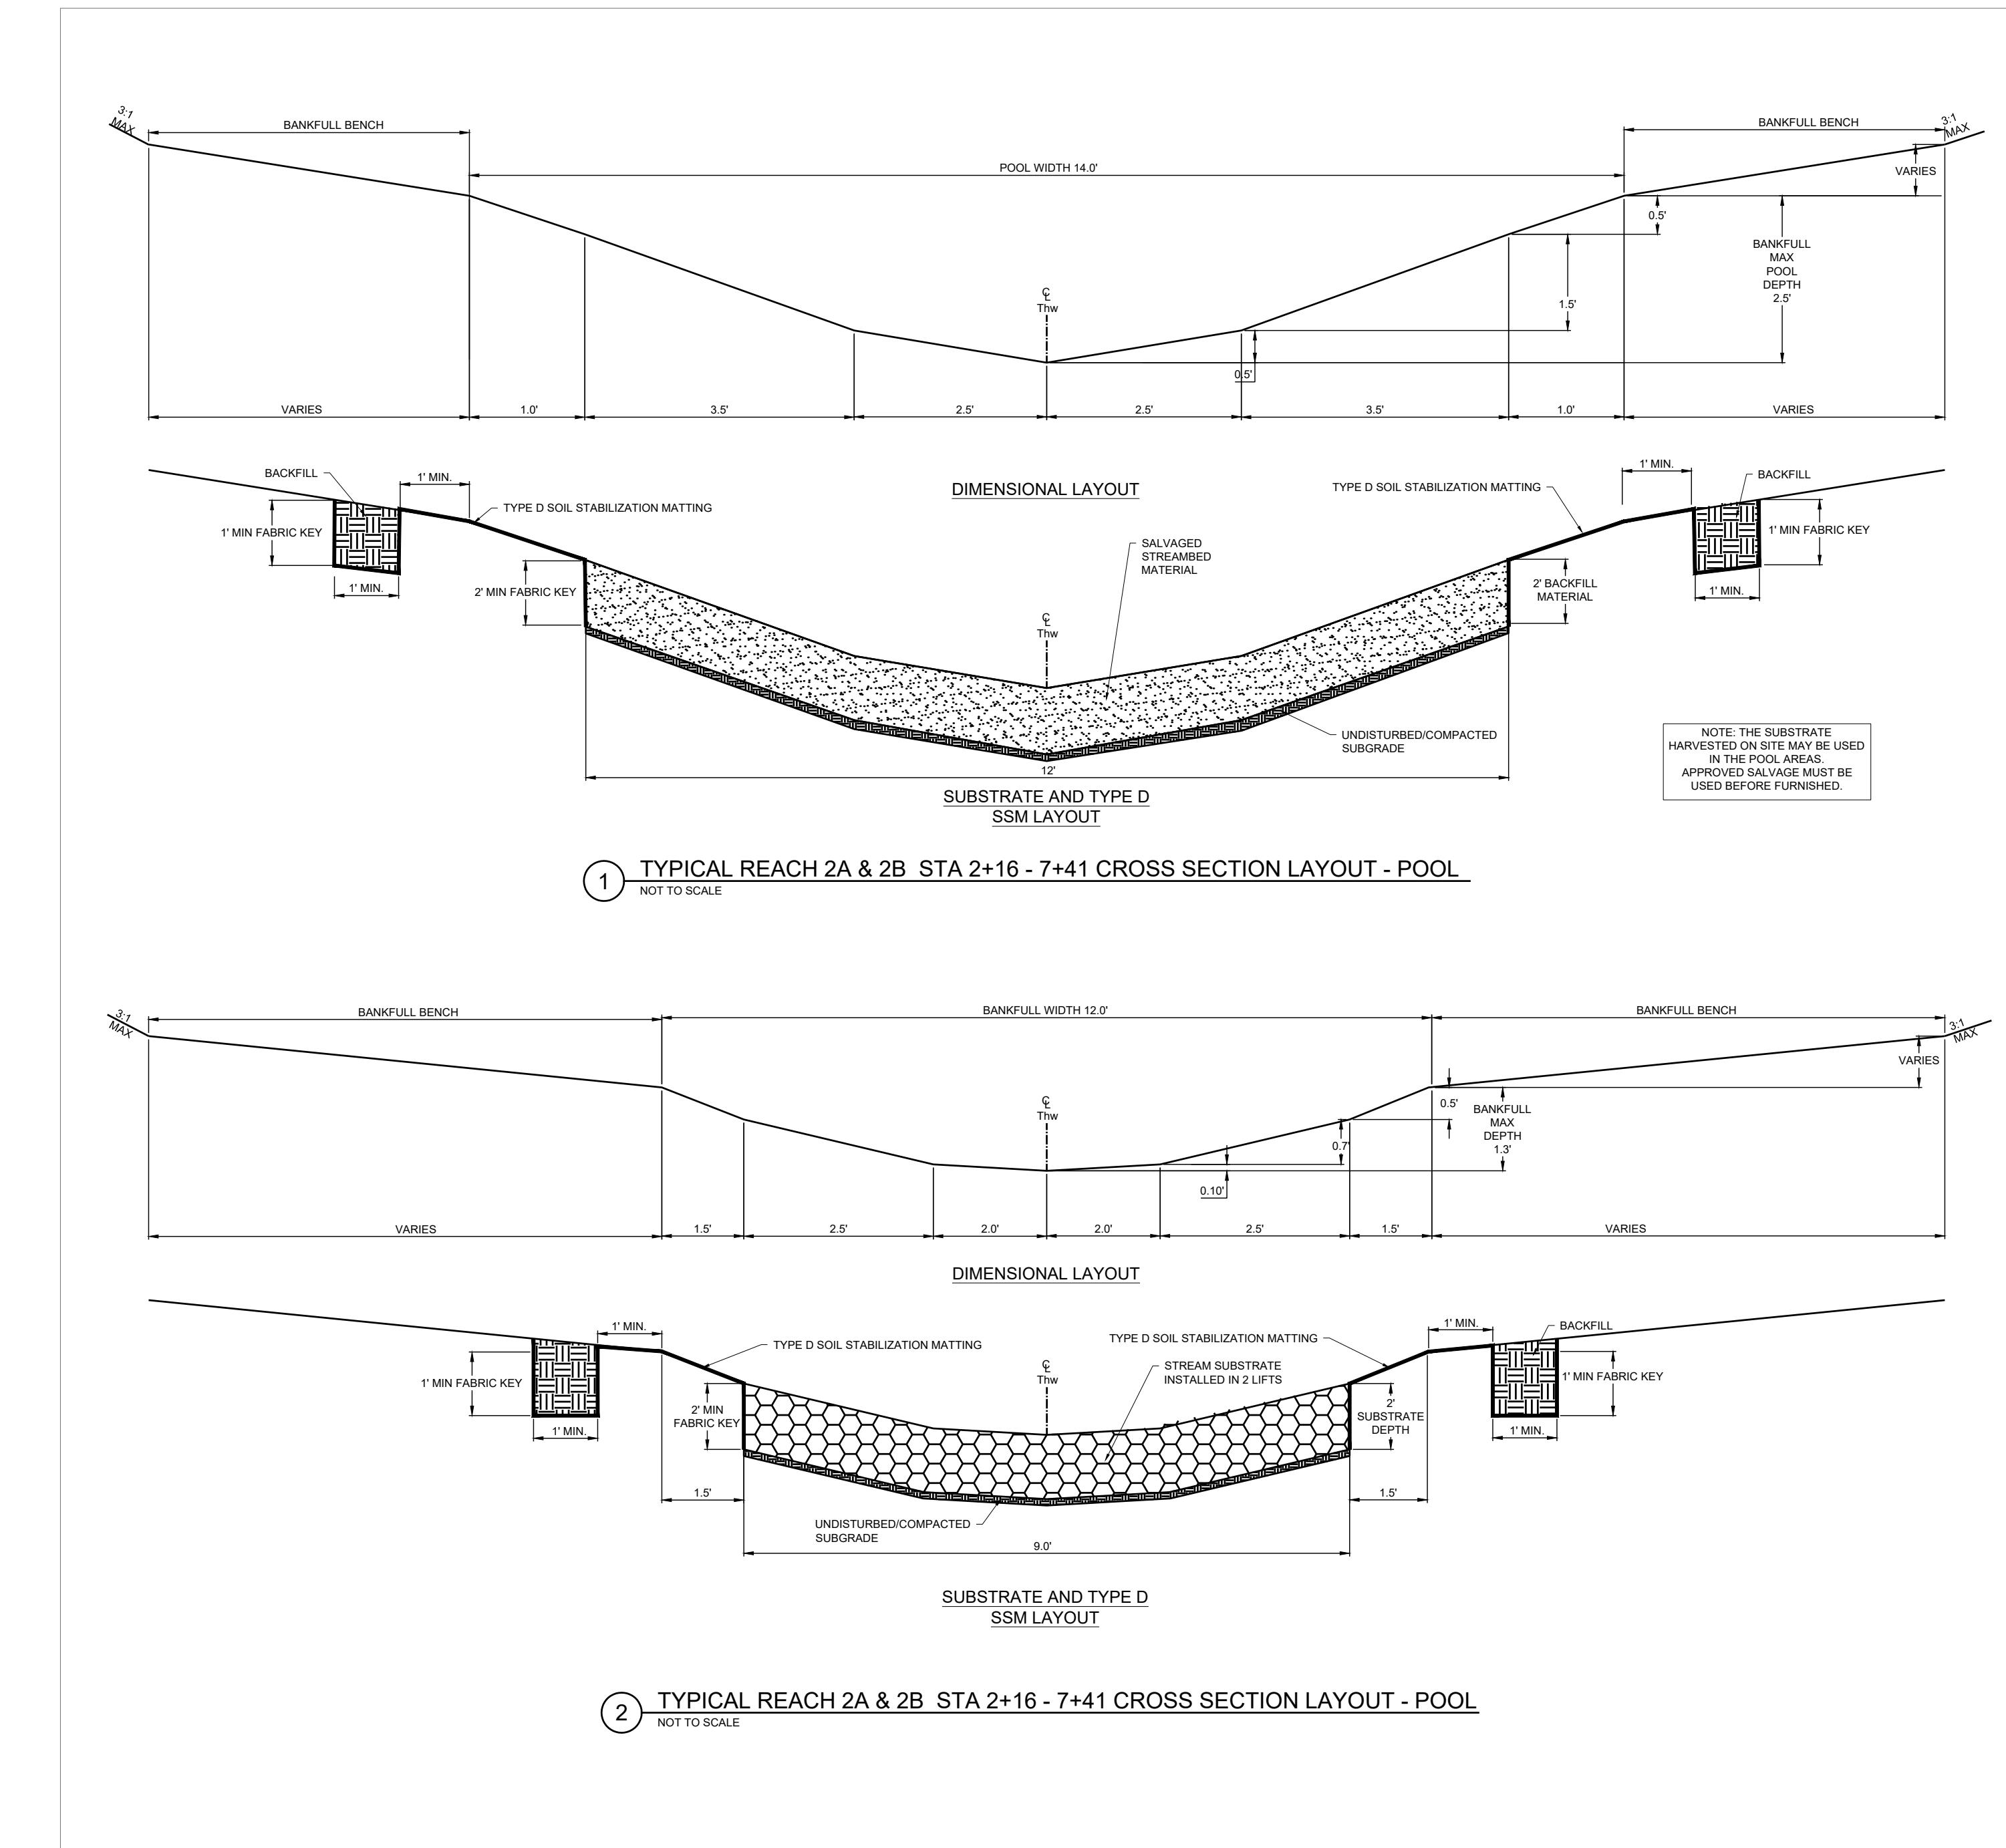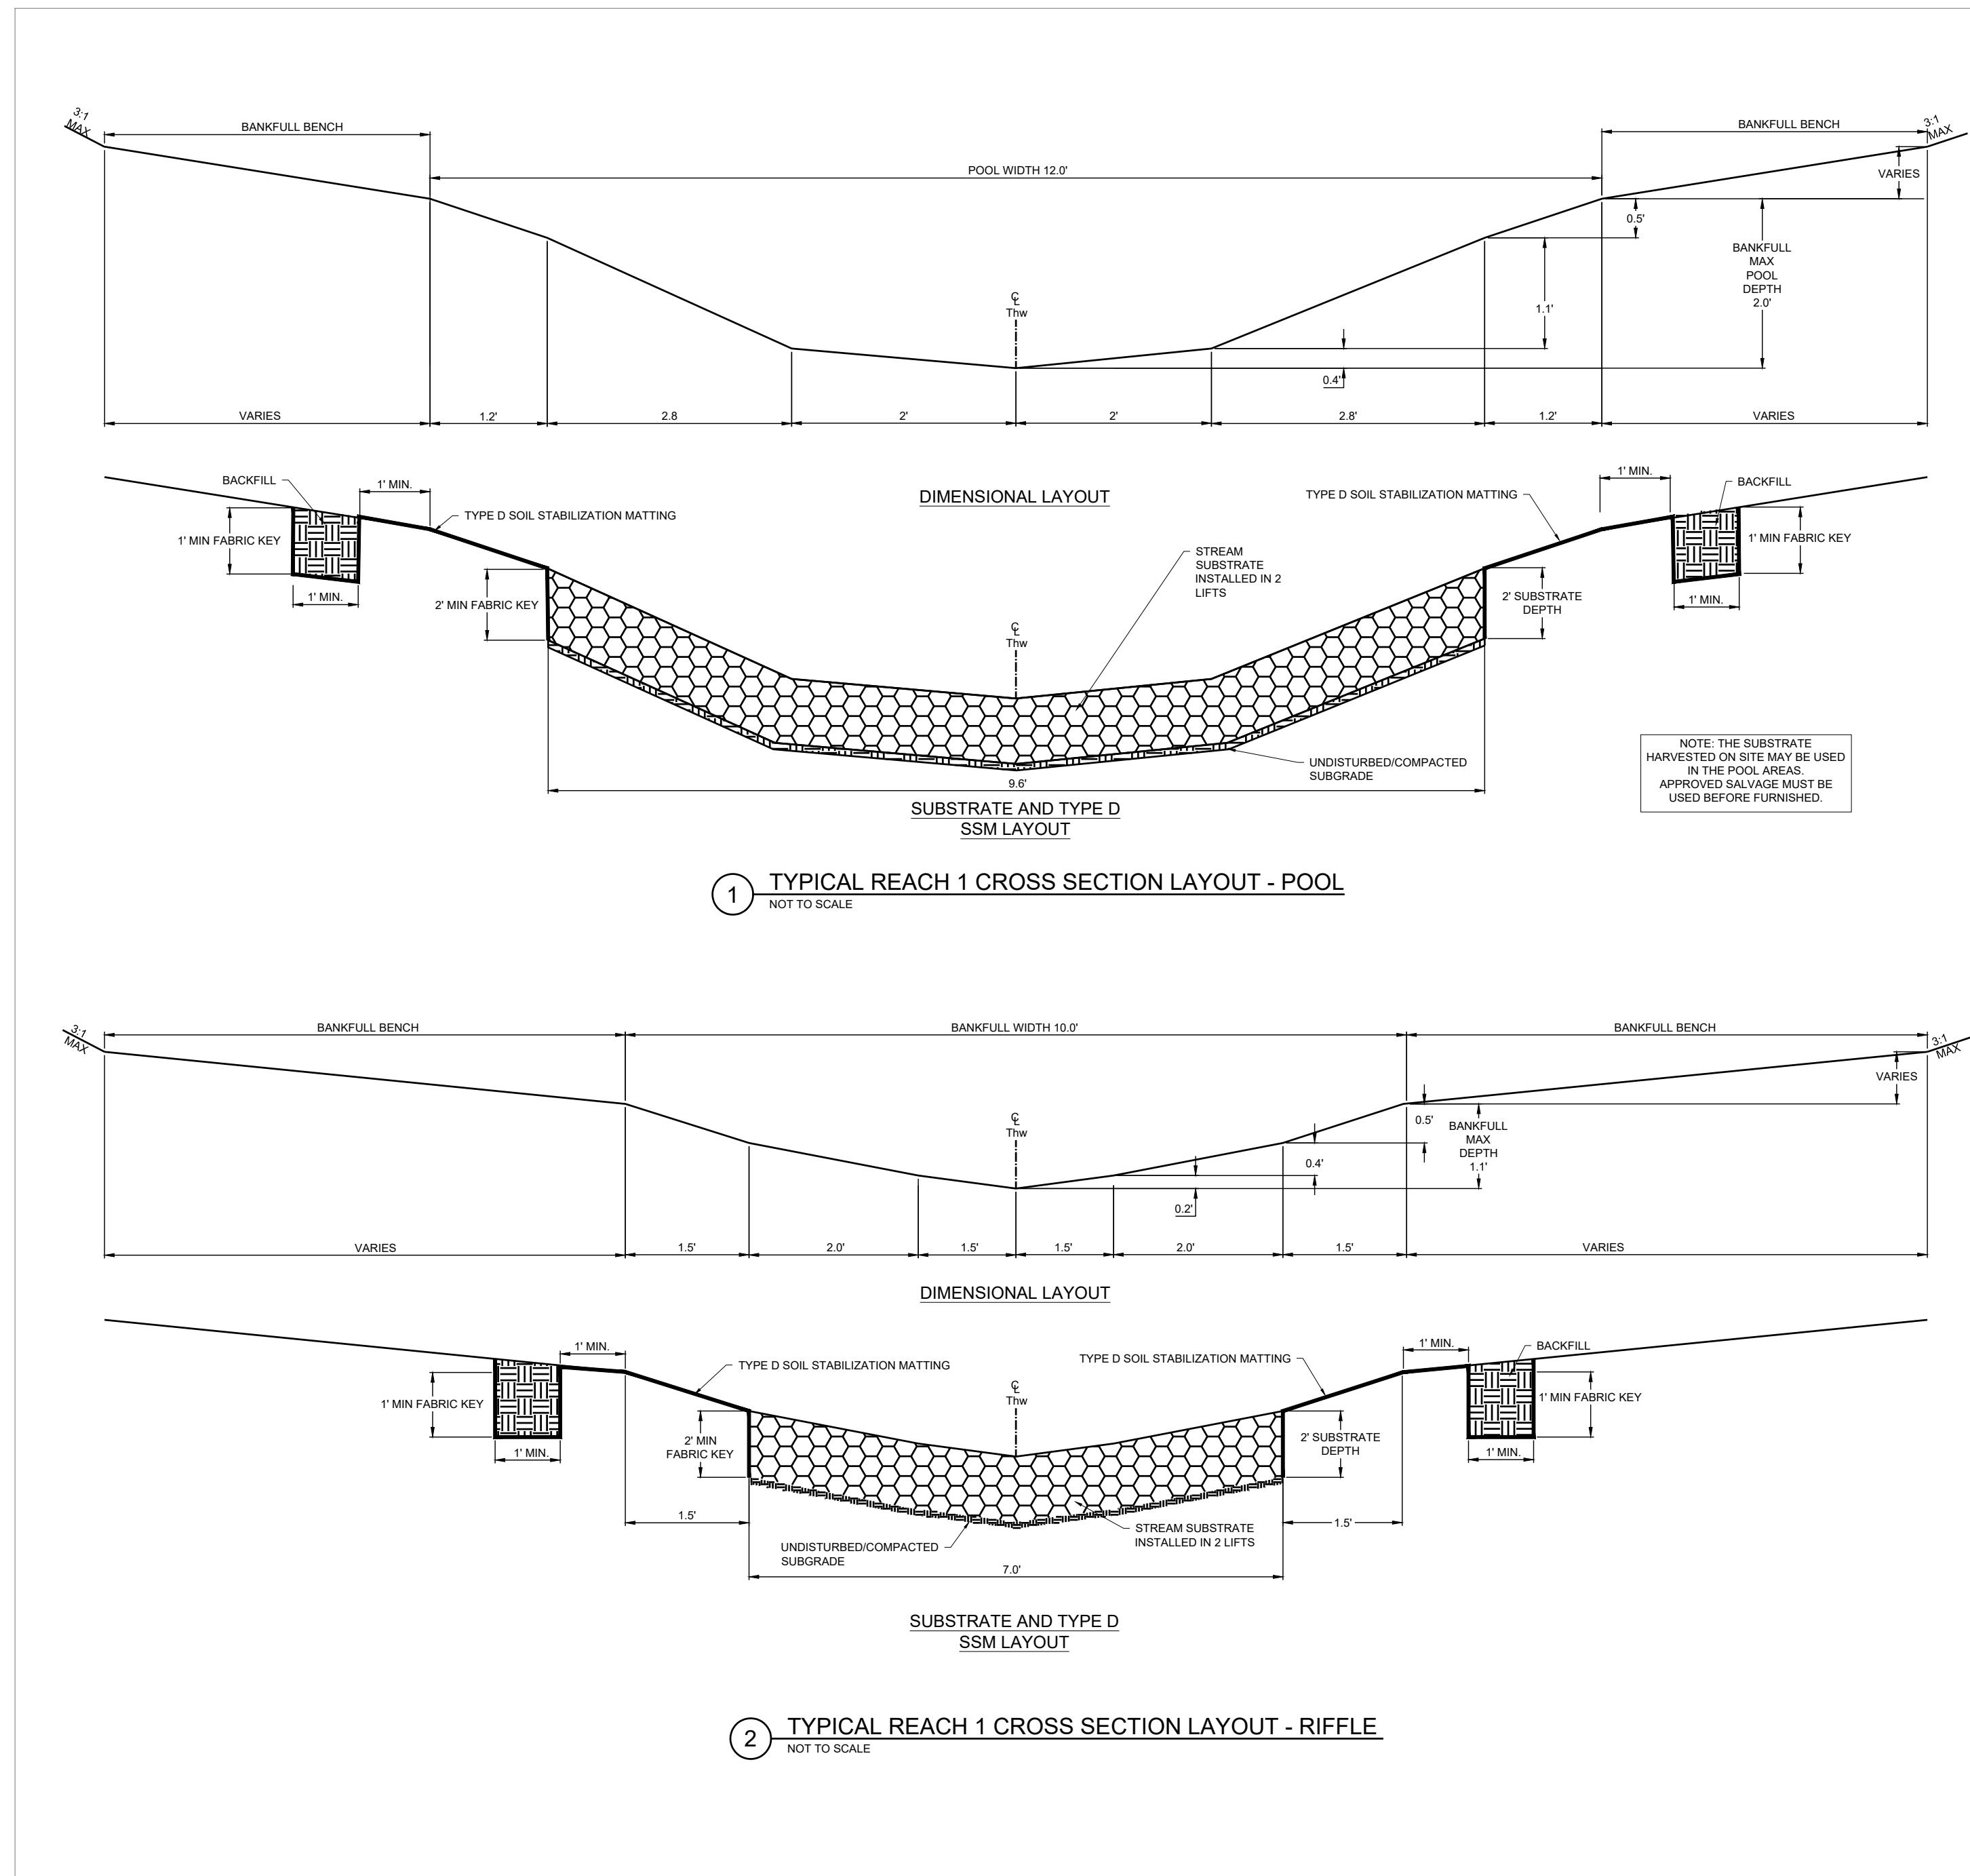

BID No.:



SCALE : 1 inch HCG DWG ID No.:

HARFORD COUNTY, MARYLAND

EDgewater VILLAGE PARK STREAM RESTORATION STREAM CROSS SECTIONS

S/C PLAN # 59914		Revisions		EDGEMARSH VILLAGE PARK STREAM RESTORATION STREAM CROSS SECTIONS			
GRA-004622-2025							
SIGN AND SEAL				Drawn By : CA		Scale : AS NOTED	
				Designed By : CA		Date : SEPTEMBER 2025	
				Reviewed By : BWA			
				Drawing No.	XS-01	of	XS-03

PROFESSIONAL CERTIFICATION

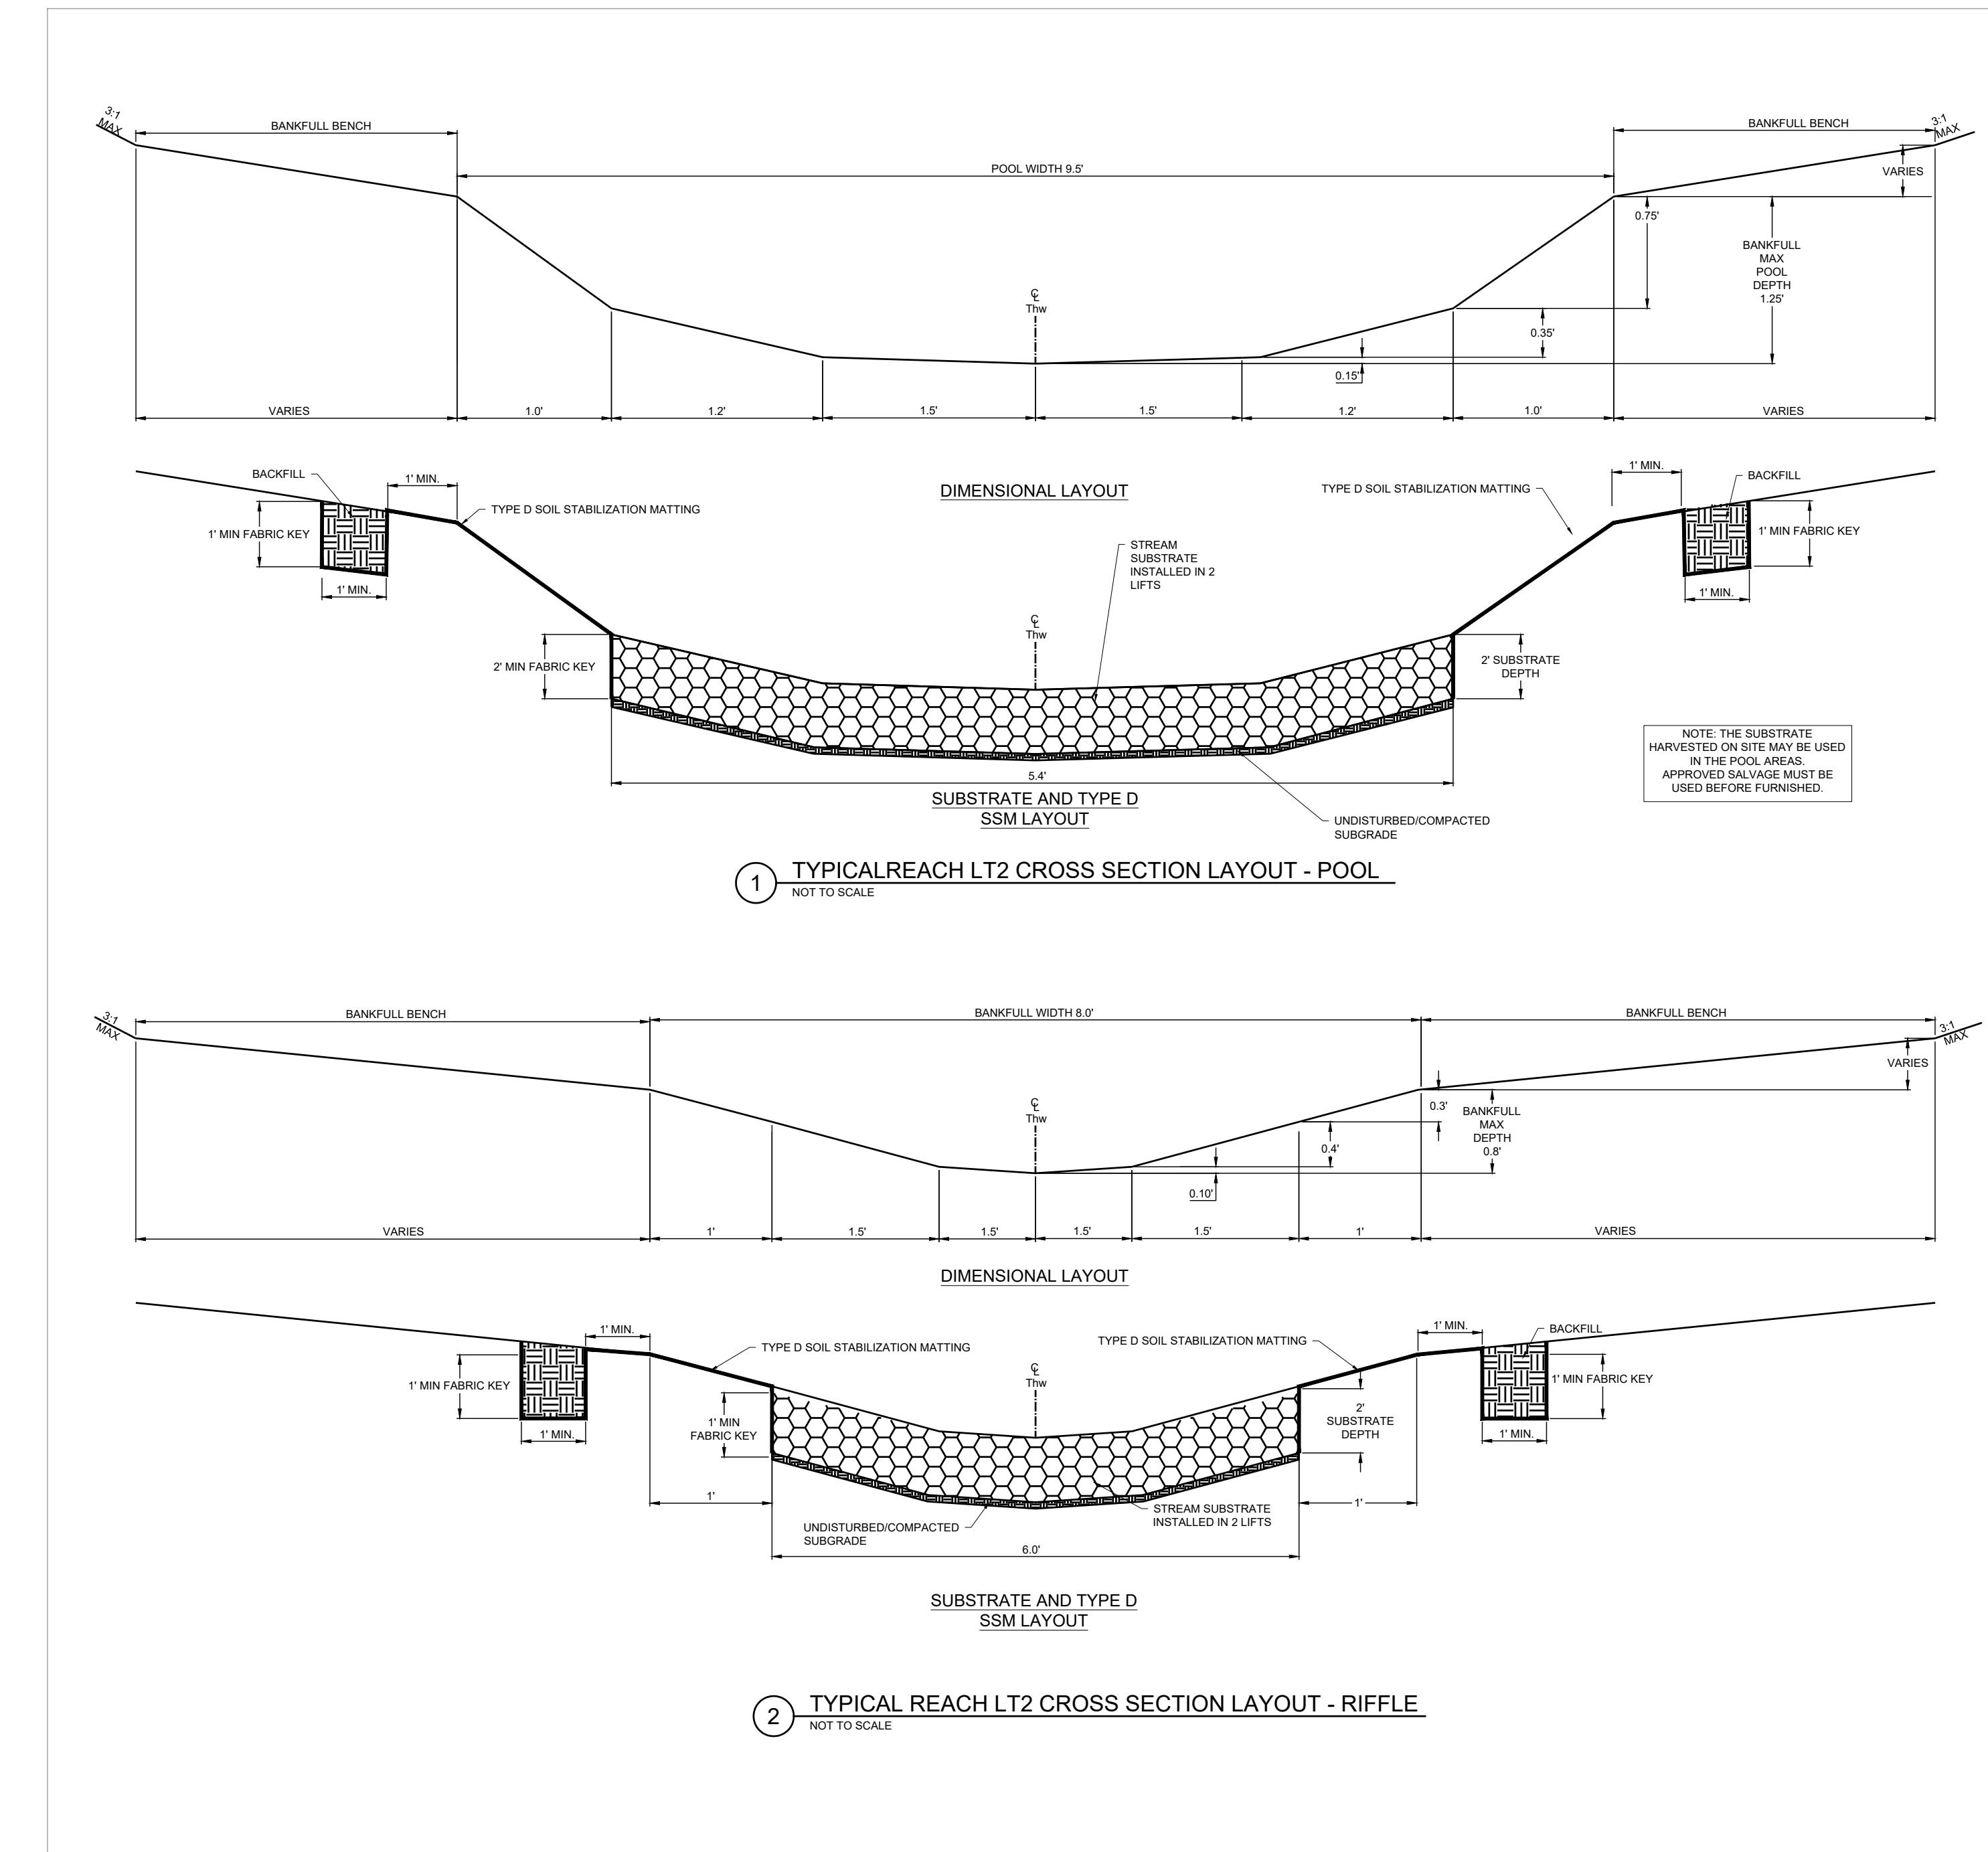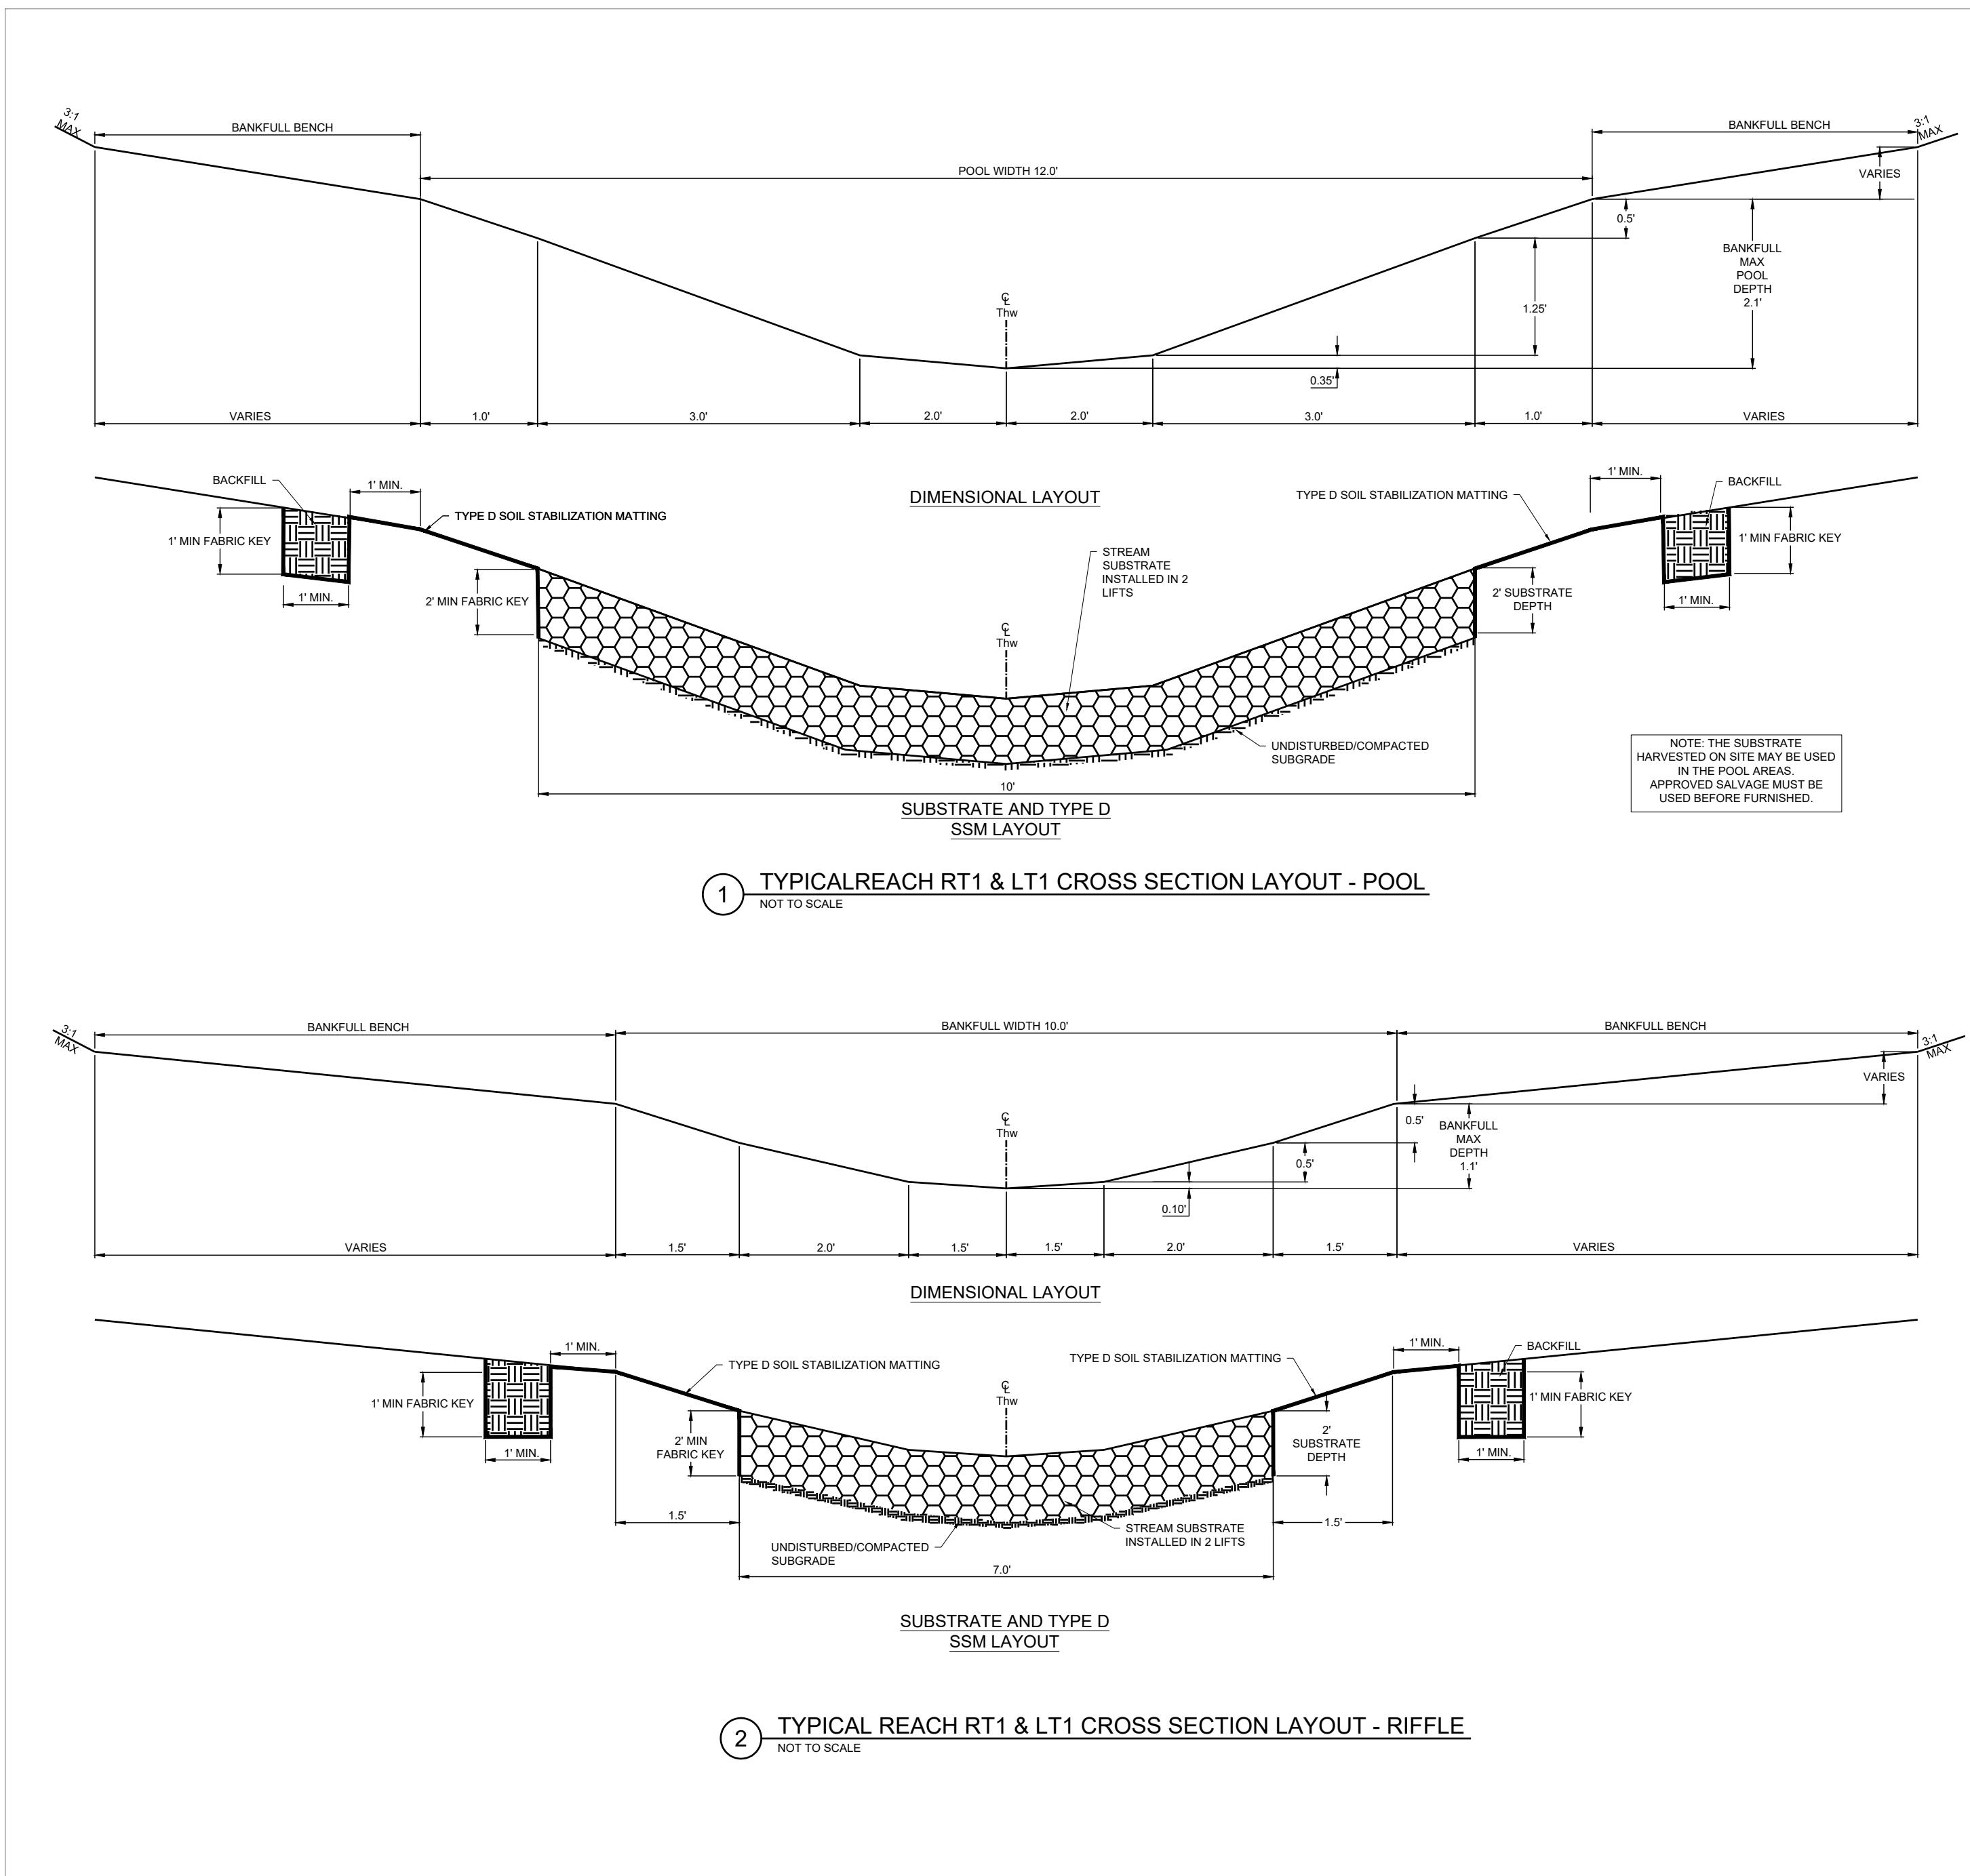



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HARFORD COUNTY, MARYLAND

EDGEWATER VILLAGE PARK STREAM RESTORATION STREAM CROSS SECTIONS

S/C PLAN # 59914	Revisions	<p>FRANKFORD COUNTY, MARYLAND</p> <p>EDGEMARSH VILLAGE PARK STREAM RESTORATION STREAM CROSS SECTIONS</p>		
GRA-004622-2025		Drawn By : CA	Scale : AS NOTED	
SIGN AND SEAL		Designed By : CA	Date : SEPTEMBER 2025	
		Reviewed By : BWA		
		Drawing No. XS-02 of XS-03	Sheet No.	23 of 65

PROFESSIONAL CERTIFICATION

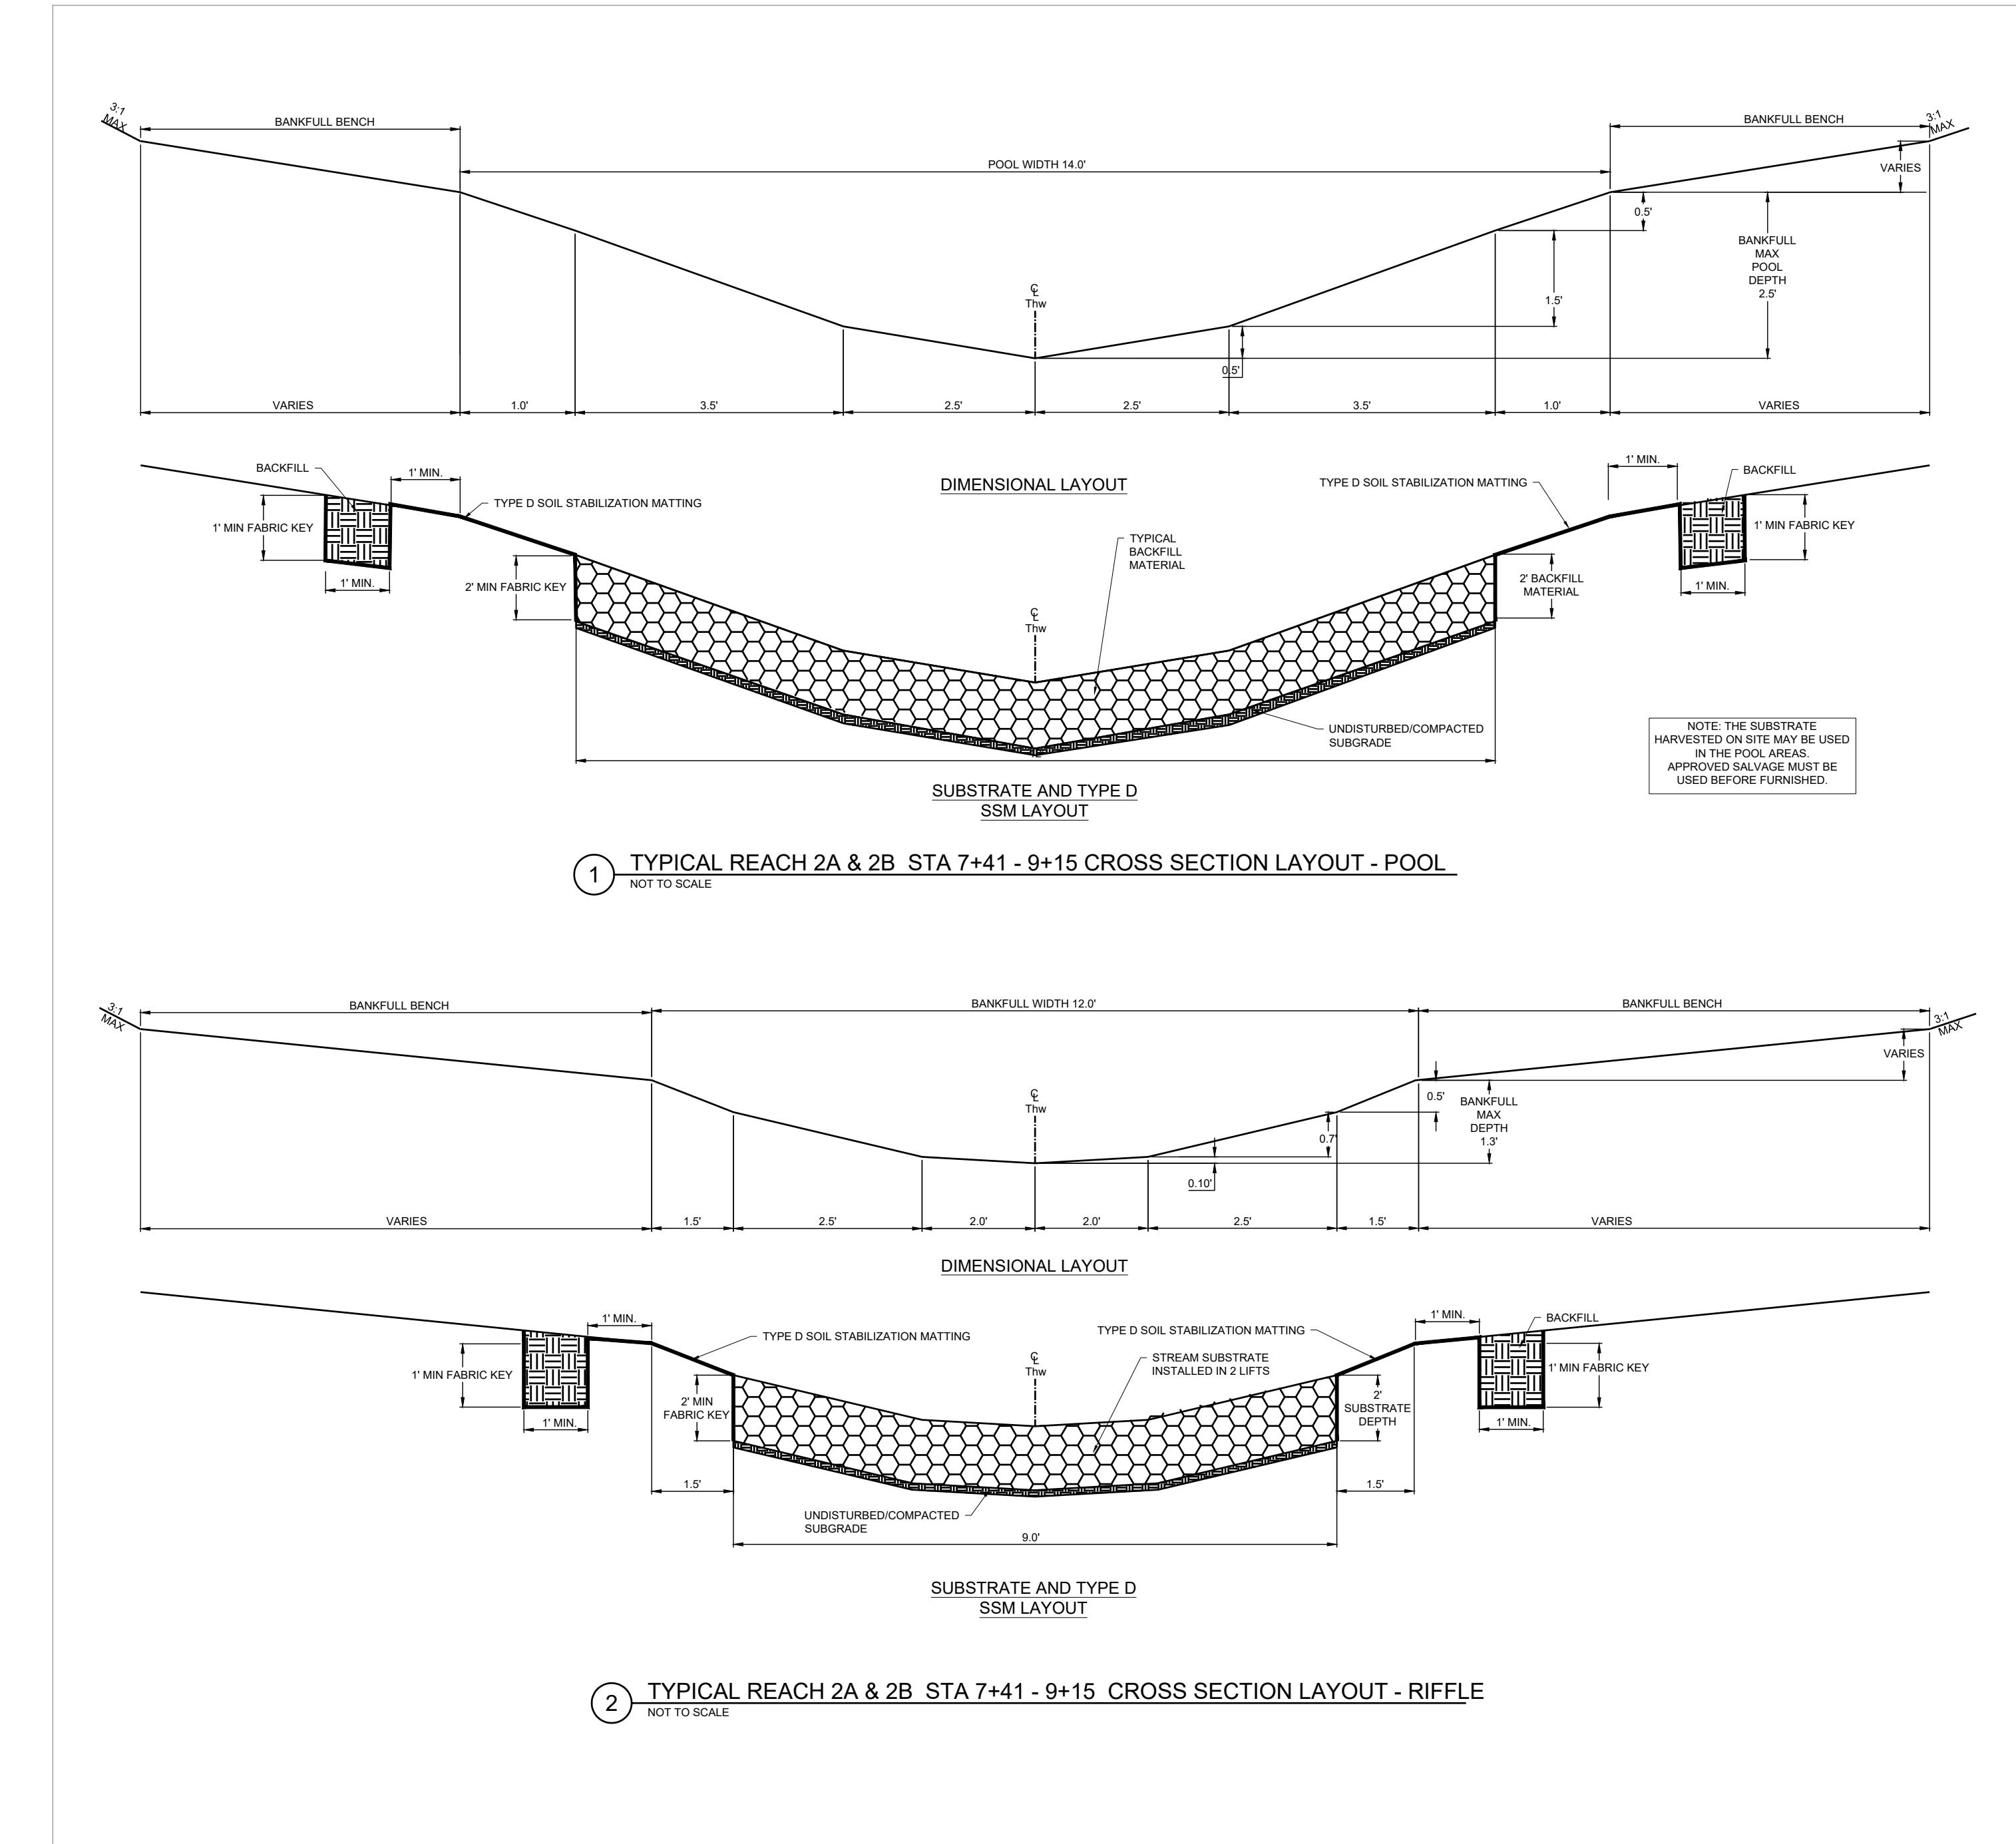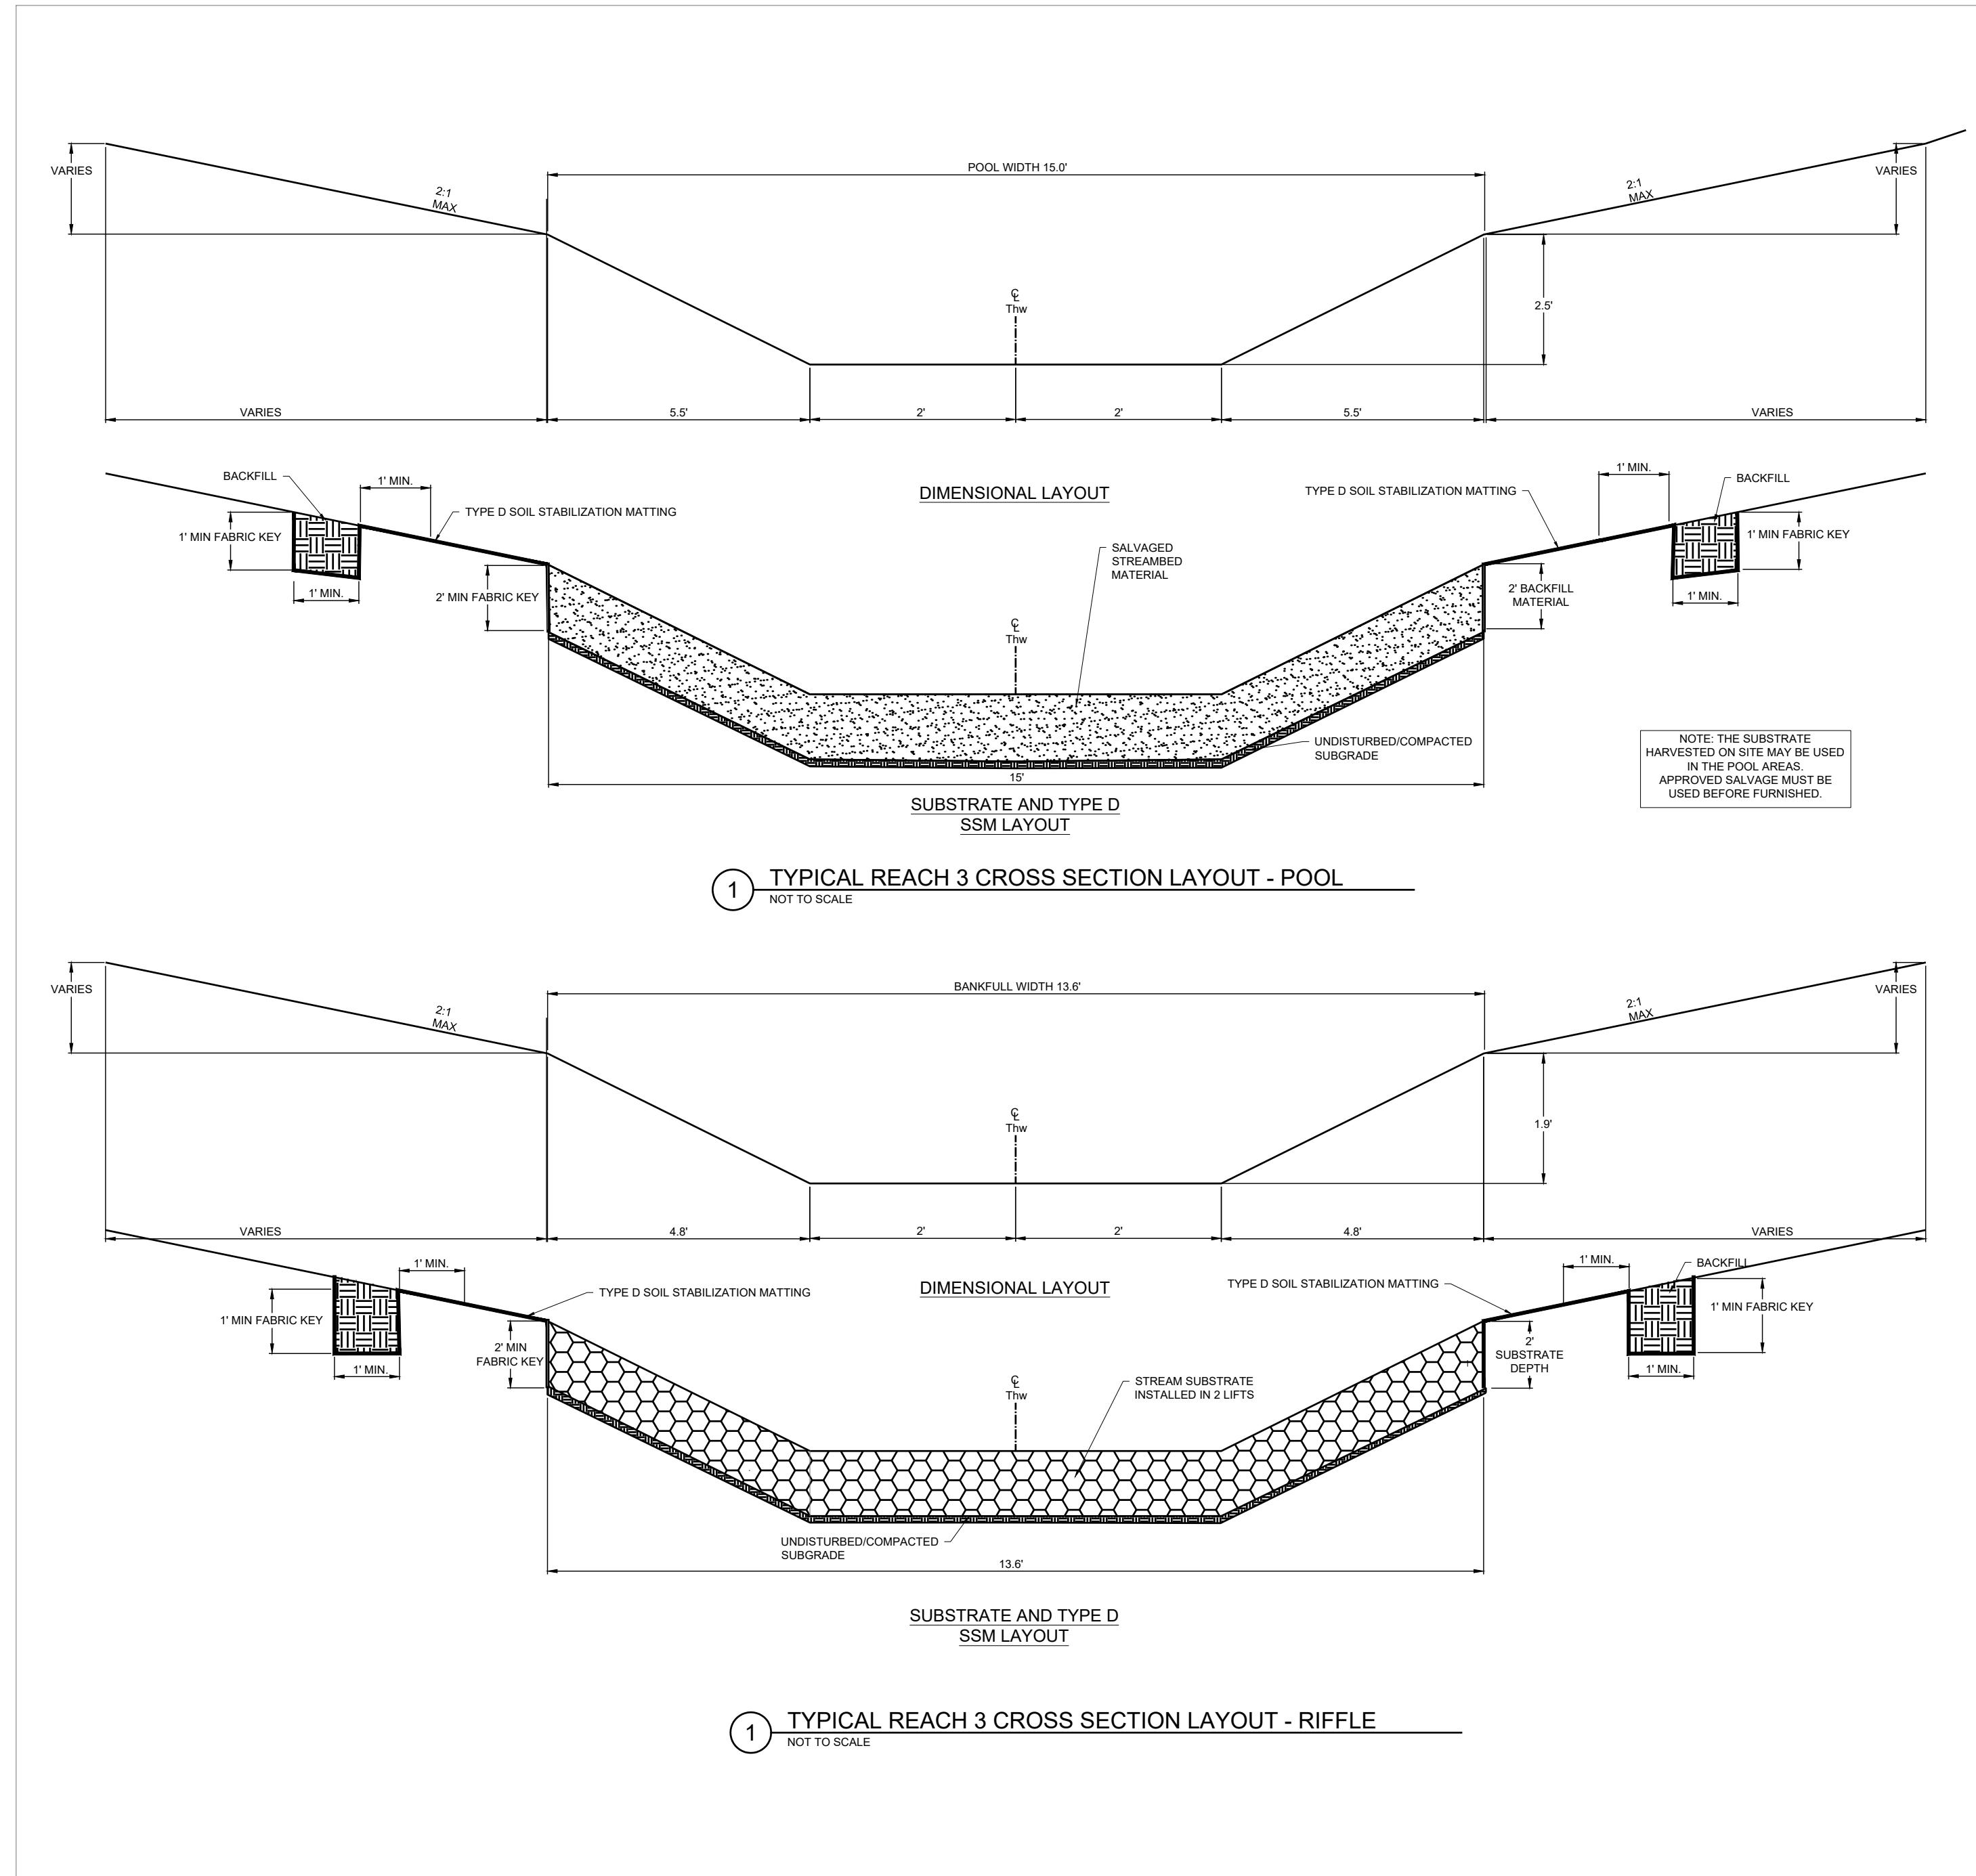

BID No.:





HARFORD COUNTY, MARYLAND

EDGEWATER VILLAGE PARK STREAM RESTORATION STREAM CROSS SECTIONS

Drawn By : <u>CA</u>	Scale : <u>AS NOTED</u>
Designed By : <u>CA</u>	Date : <u>SEPTEMBER 2025</u>
Reviewed By : <u>BWA</u>	
Drawing No. <u>XS-03</u>	Sheet No. <u>24</u> of <u>6</u>

S/C PLAN # 59914	Revisions	EDGEMORE, DELAWARE COUNTY, PENNSYLVANIA EDGEWATER VILLAGE PARK STREAM RESTORATION STREAM CROSS SECTIONS		
GRA-004622-2025		Drawn By : CA	Scale : AS NOTED	
SIGN AND SEAL		Designed By : CA	Date : SEPTEMBER 2025	
		Reviewed By : BWA		
		Drawing No. XS-03 of XS-03	Sheet No.	24 of 65

I HEREBY CERTIFY THAT THESE DOCUMENTS WERE PREPARED OR APPROVED BY ME,
AND THAT I AM A DULY LICENSED PROFESSIONAL ENGINEER UNDER THE LAWS OF
THE STATE OF MARYLAND. LICENSE NO. XXXXX, EXPIRATION DATE: XX/XX/XXXX.

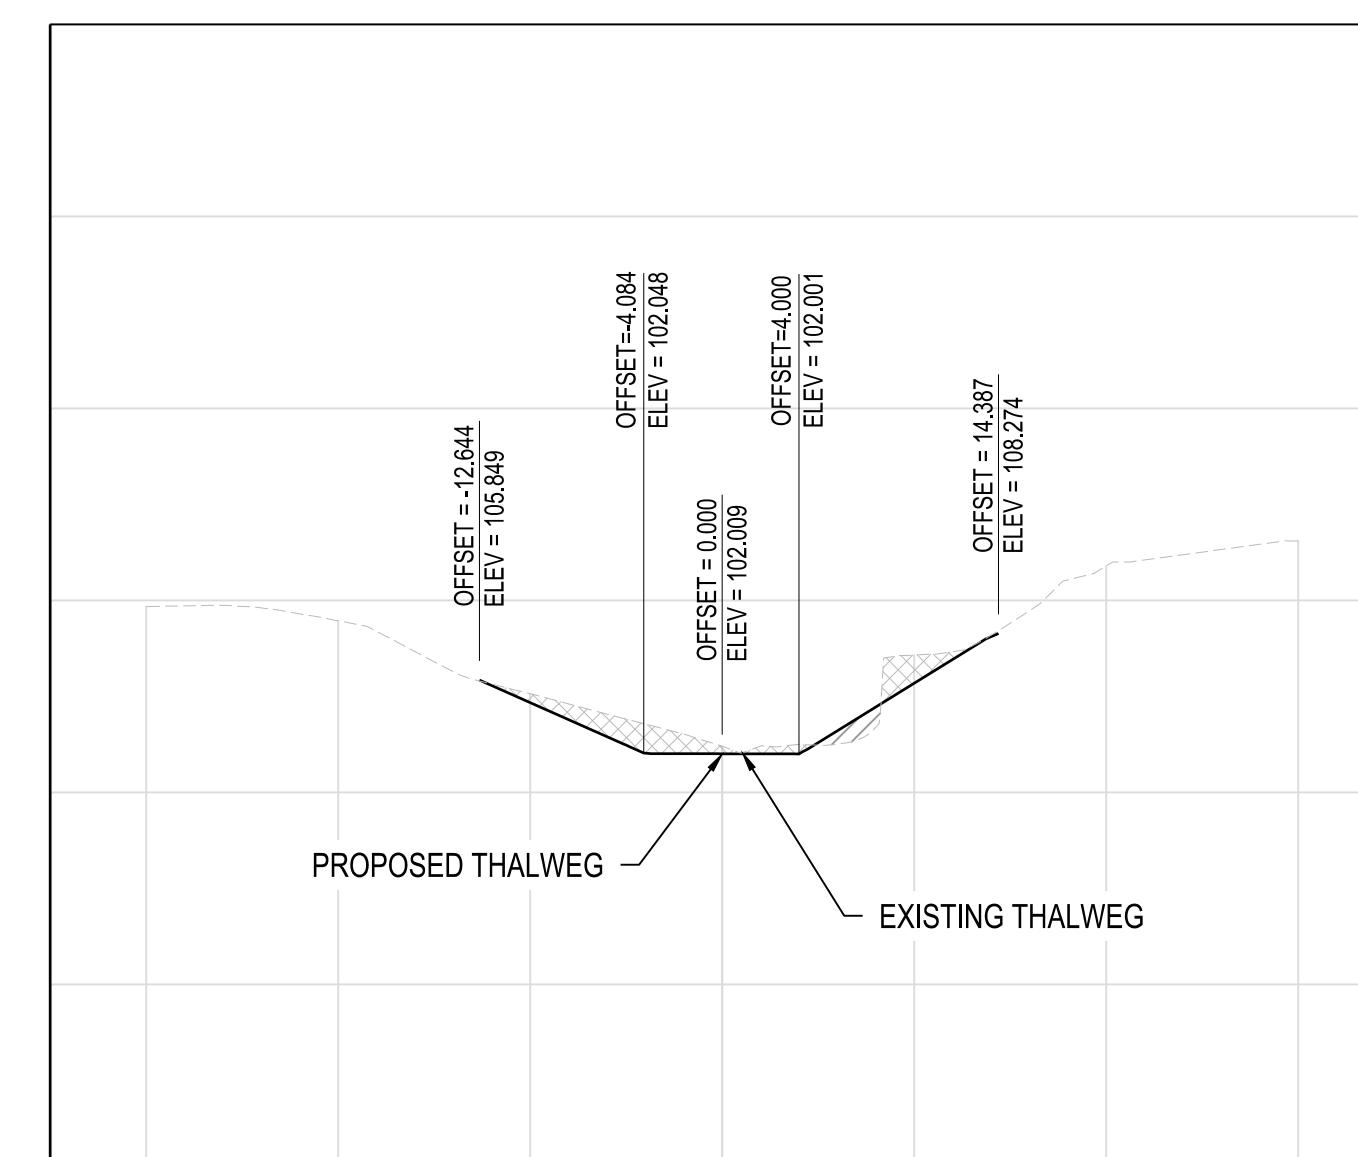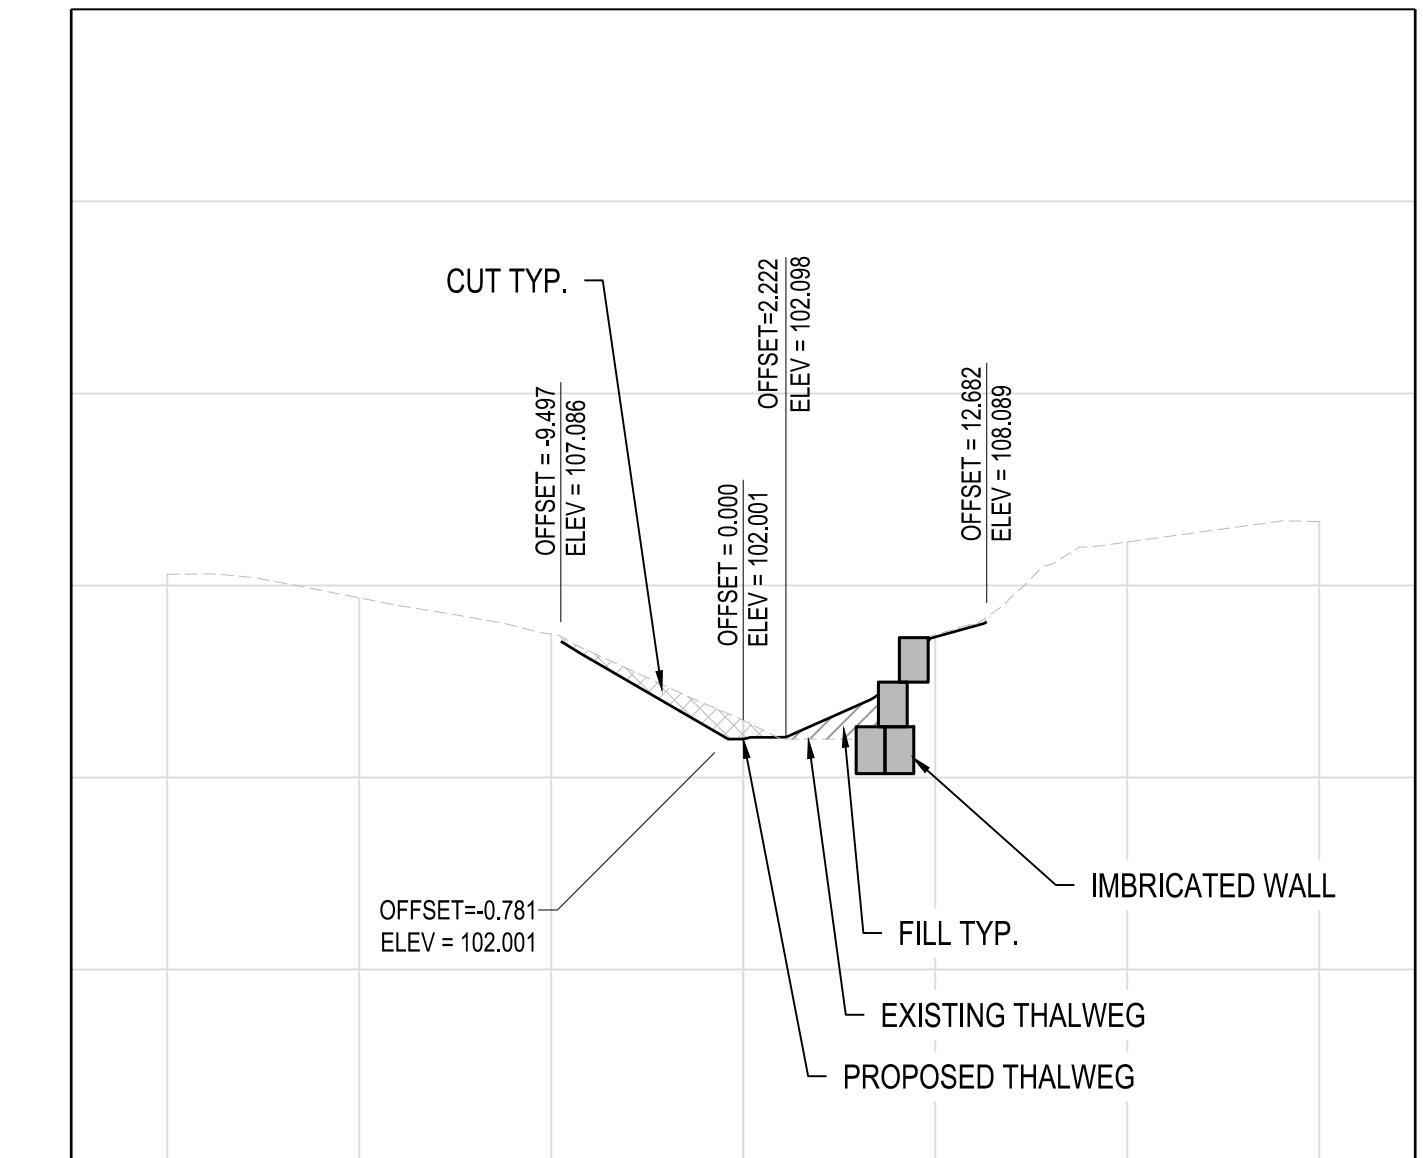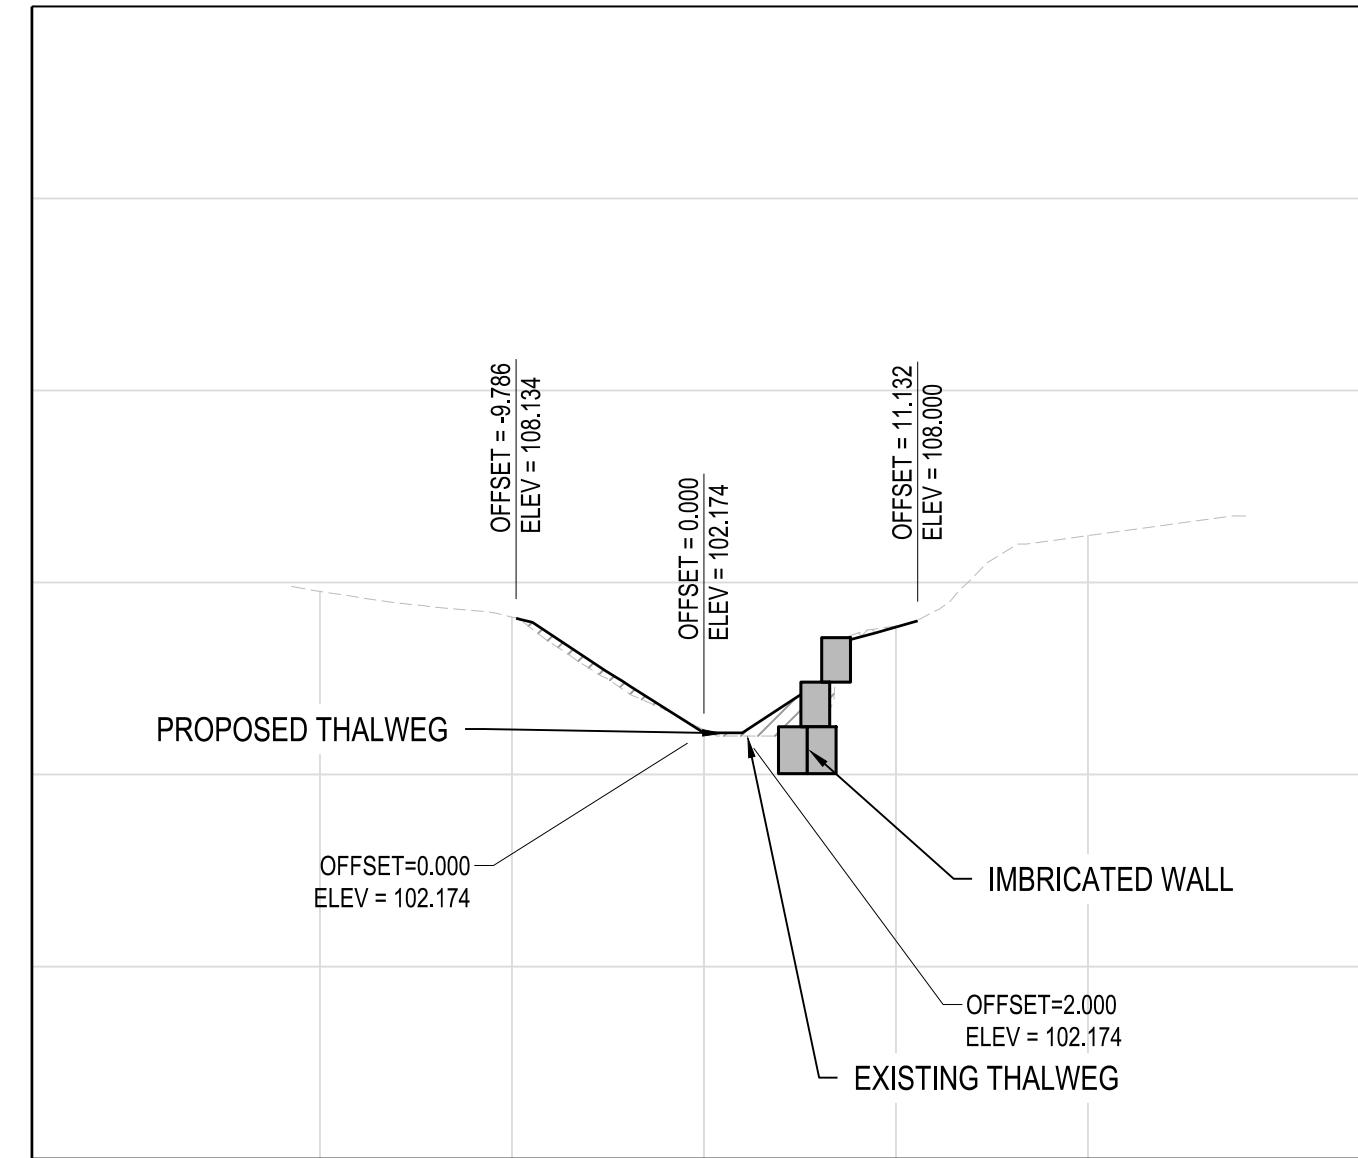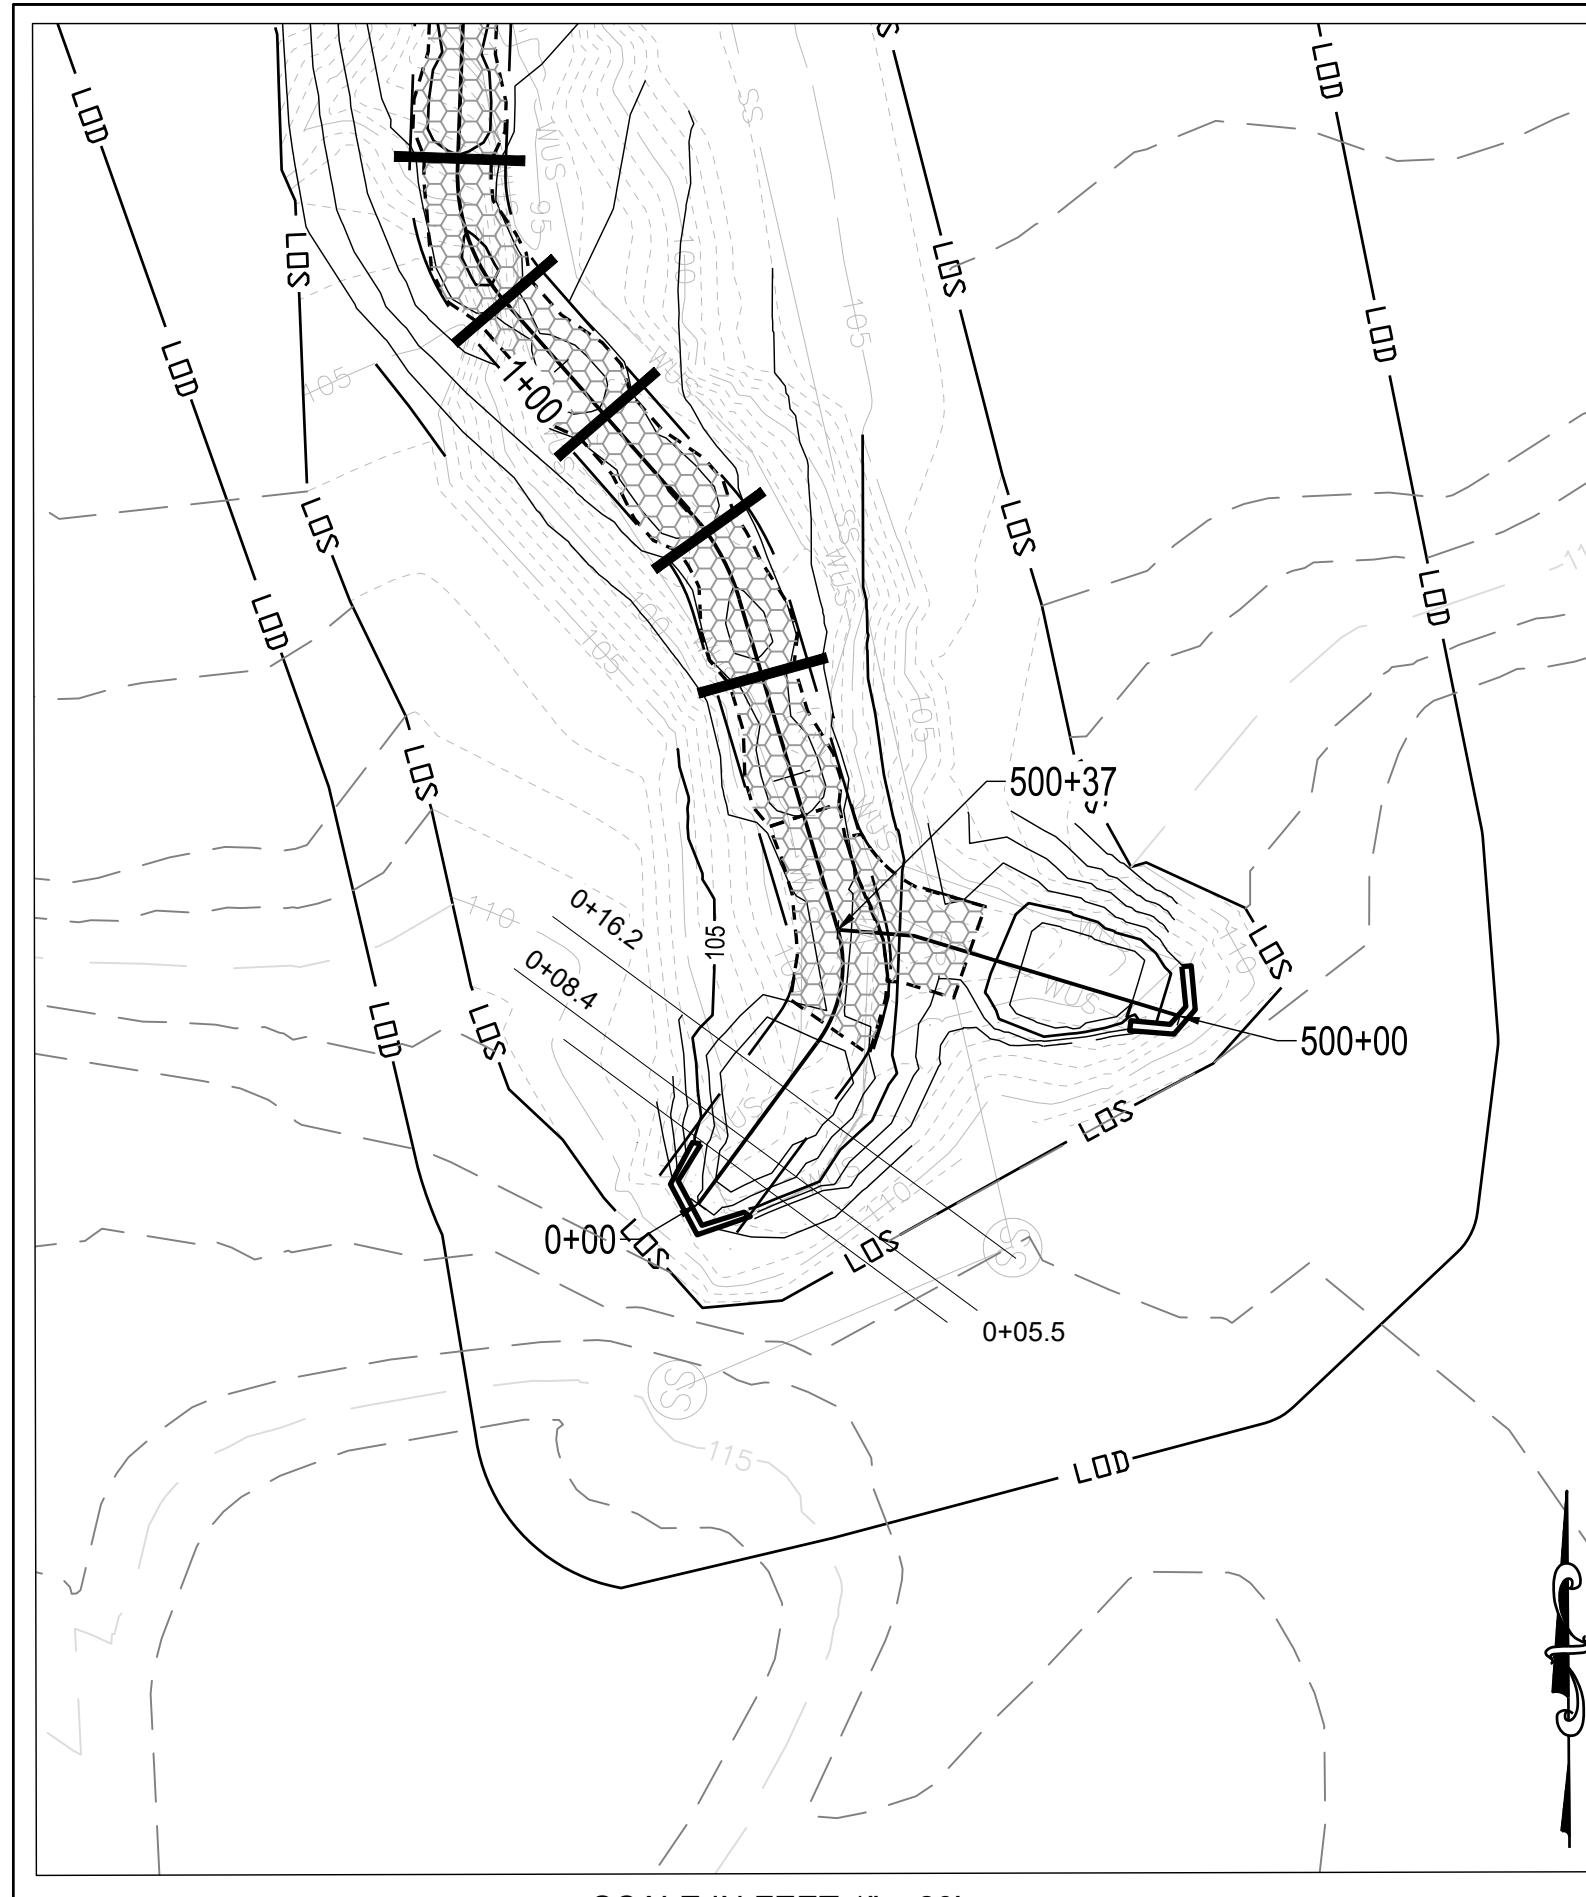

1 REACH 1 SECTION VIEWS



SCALE: 1" = 10'
10 0 10 20
SCALE IN FEET 1" = 10'

PROFESSIONAL CERTIFICATION
I HEREBY CERTIFY THAT THESE DOCUMENTS WERE PREPARED OR APPROVED BY ME,
AND THAT I AM A DULY LICENSED PROFESSIONAL ENGINEER UNDER THE LAWS OF
THE STATE OF MARYLAND LICENSE NO. XXXXX, EXPIRATION DATE: XX/XX/XXXX.

HARFORD COUNTY, MARYLAND
EDGEWATER VILLAGE PARK
STREAM RESTORATION
SECTION VIEW

HCG DWG ID No.: BID No.:
Scale : AS SHOWN
Date : SEPTEMBER 2025

S/C PLAN # 59914	Revisions
GRA-004622-2025	
SIGN AND SEAL	
Drawn By : CA	
Designed By : CA	
Reviewed By : BWA	
Drawing No. SE-01	of SE-12
Sheet No.	

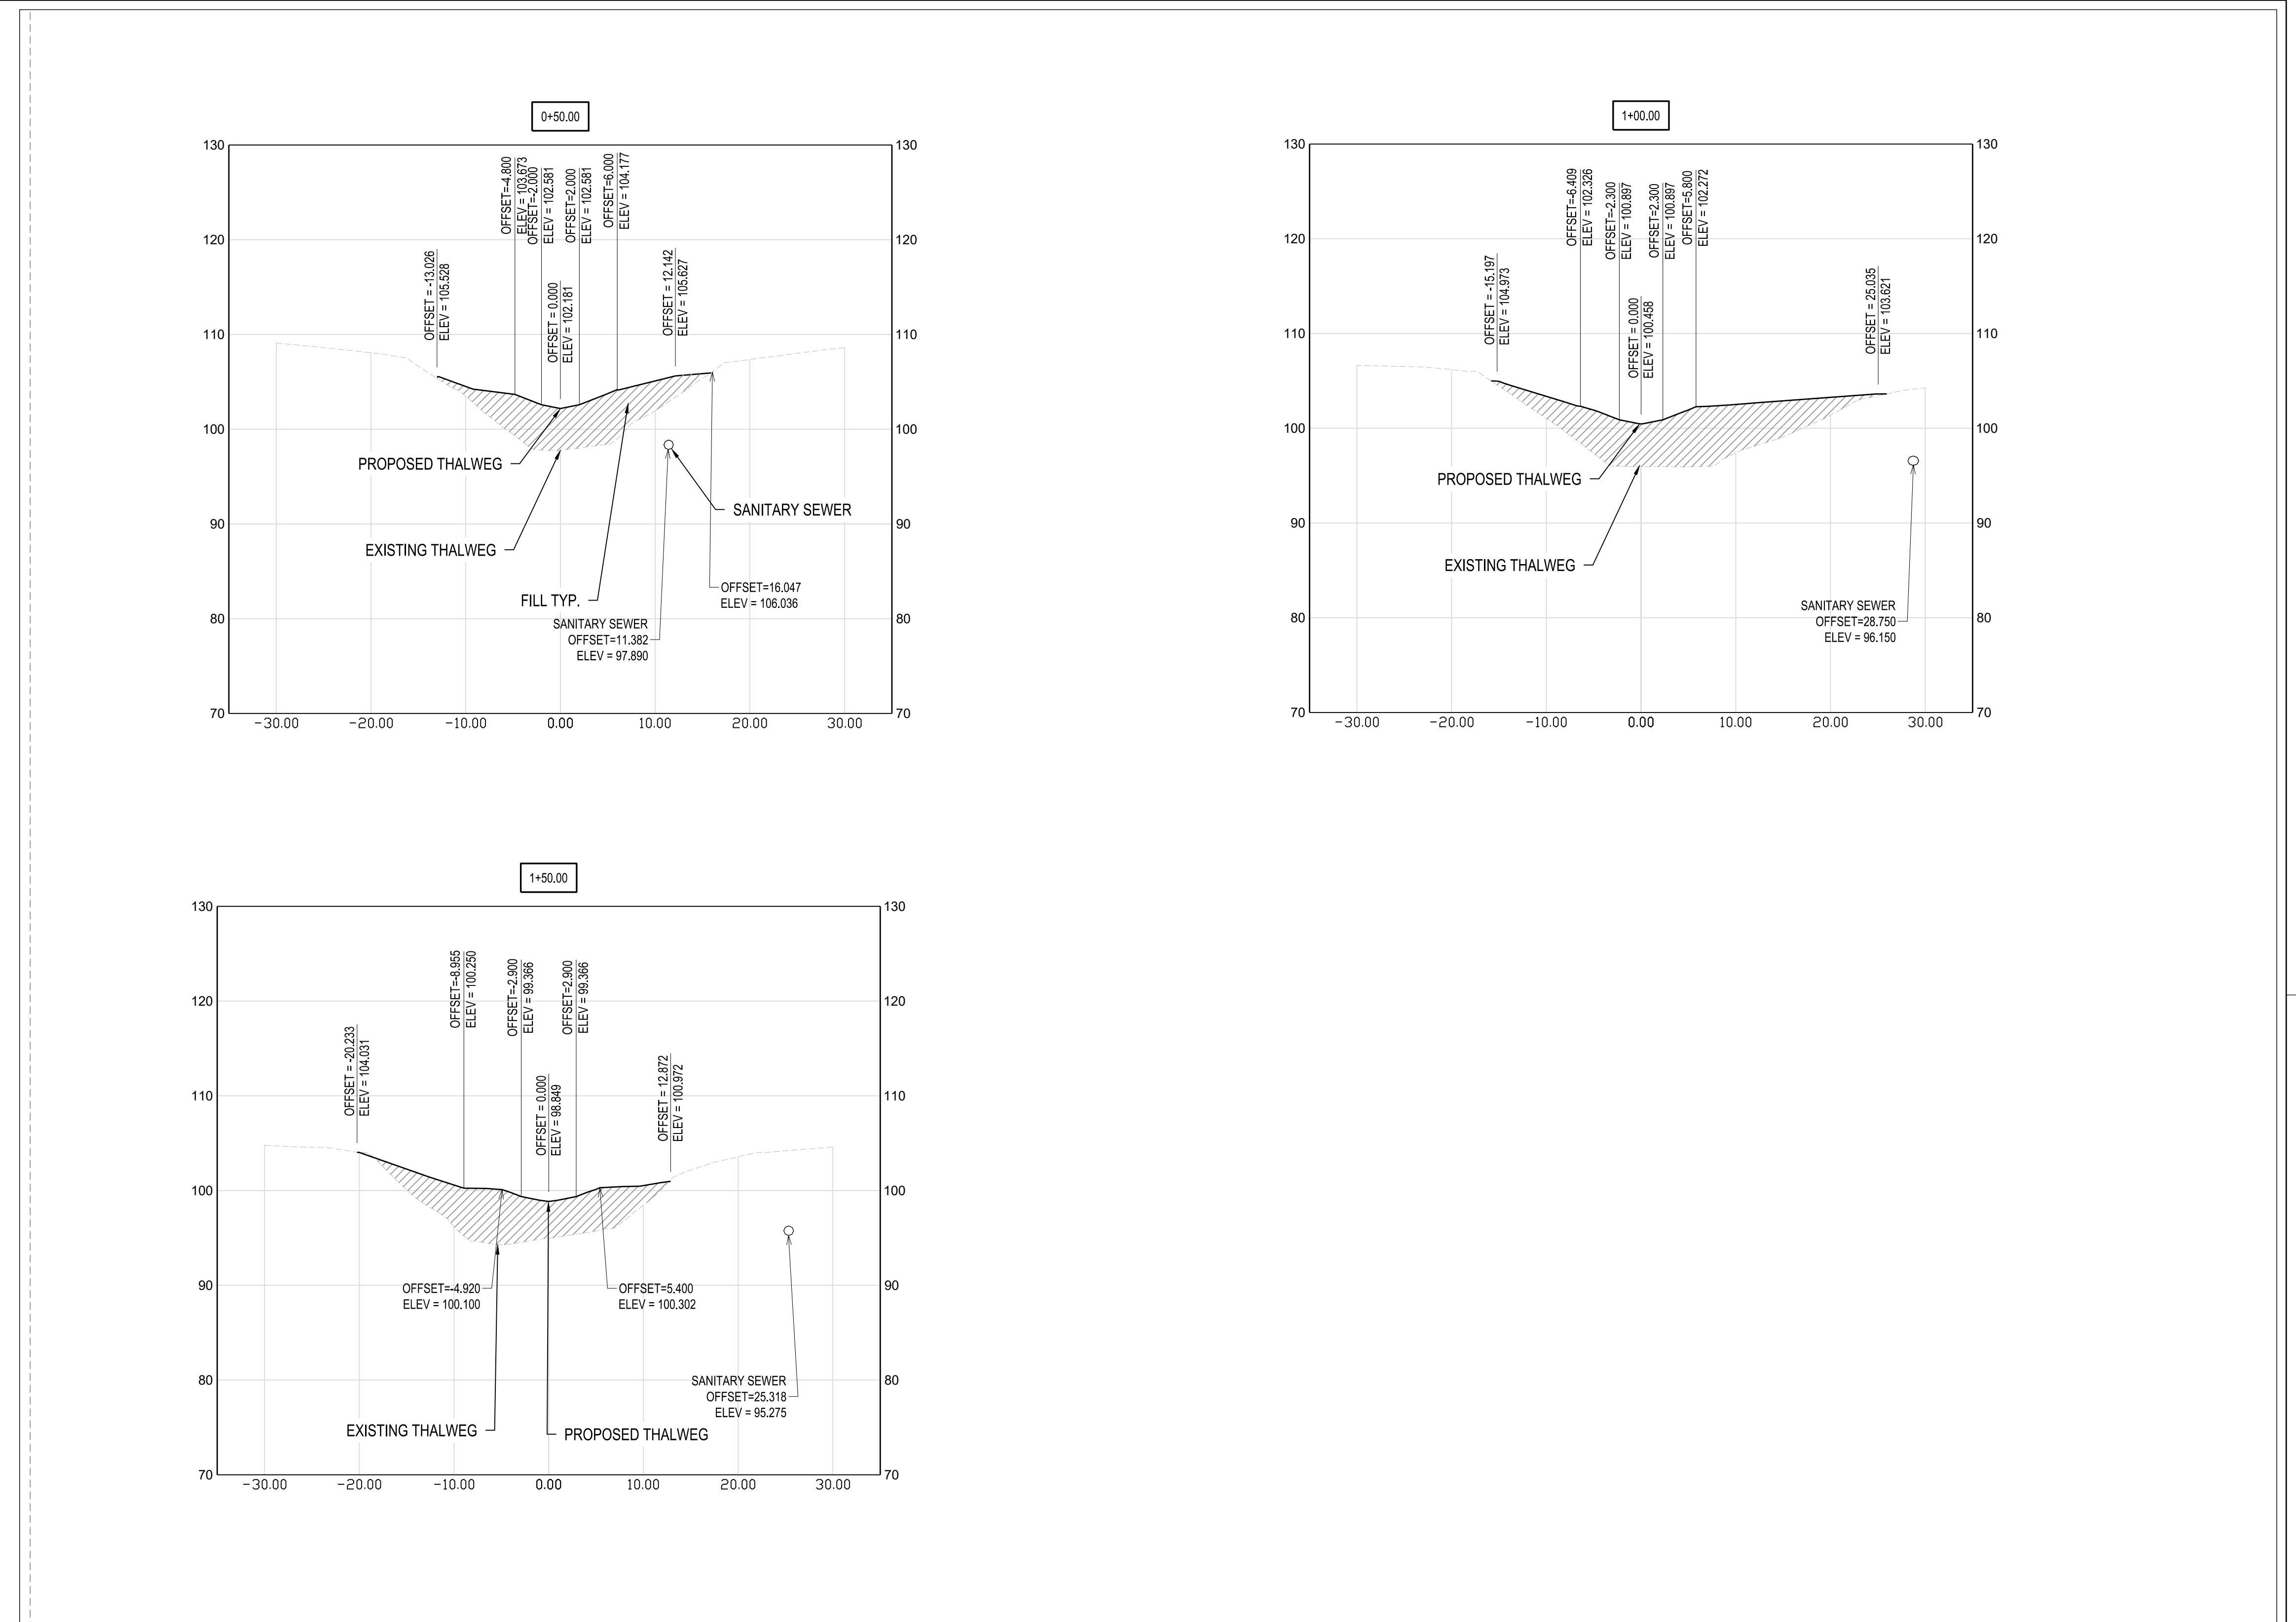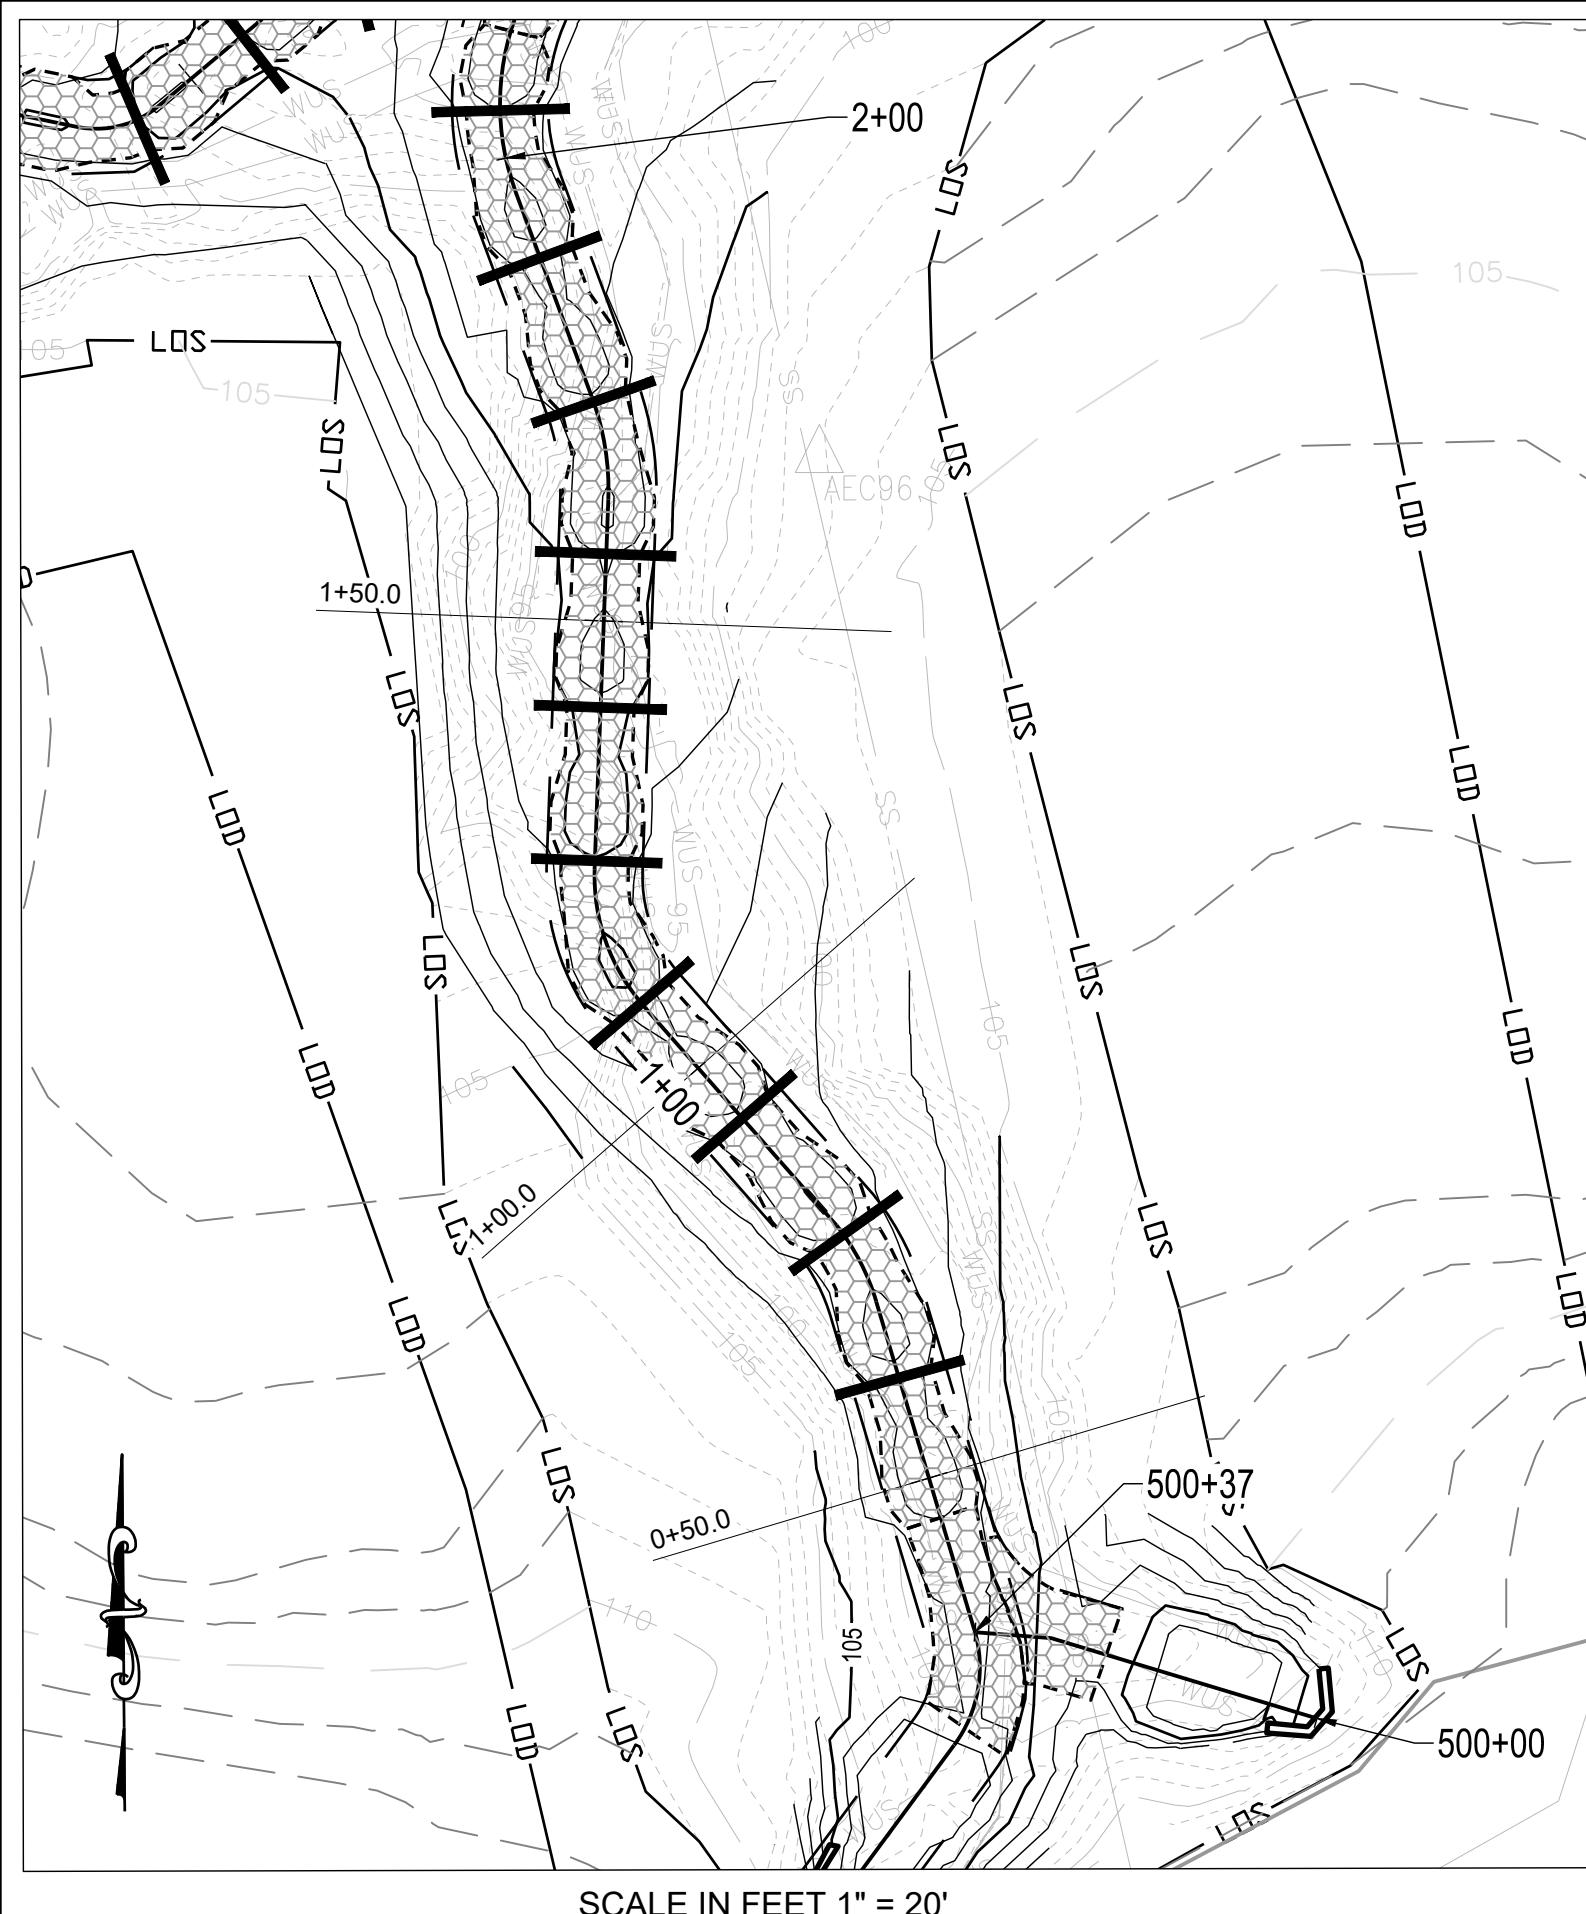

1 REACH 1 SECTION VIEWS

SCALE: 1" = 10'
10 0 10 20

SCALE IN FEET 1" = 10'

PROFESSIONAL CERTIFICATION

I HEREBY CERTIFY THAT THESE DOCUMENTS WERE PREPARED OR APPROVED BY ME,
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THE STATE OF MARYLAND LICENSE NO. XXXXX, EXPIRATION DATE: XX/XX/XXXX.

S/C PLAN # 59914


Revisions

GRA-004622-2025


SIGN AND SEAL

HARFORD COUNTY, MARYLAND
EDGEWATER VILLAGE PARK
STREAM RESTORATION
SECTION VIEW

AS SHOWN
Scale : SEPTEMBER 2025
Date :
Drawing No. SE-02 of SE-12
Sheet No. 26 of 65

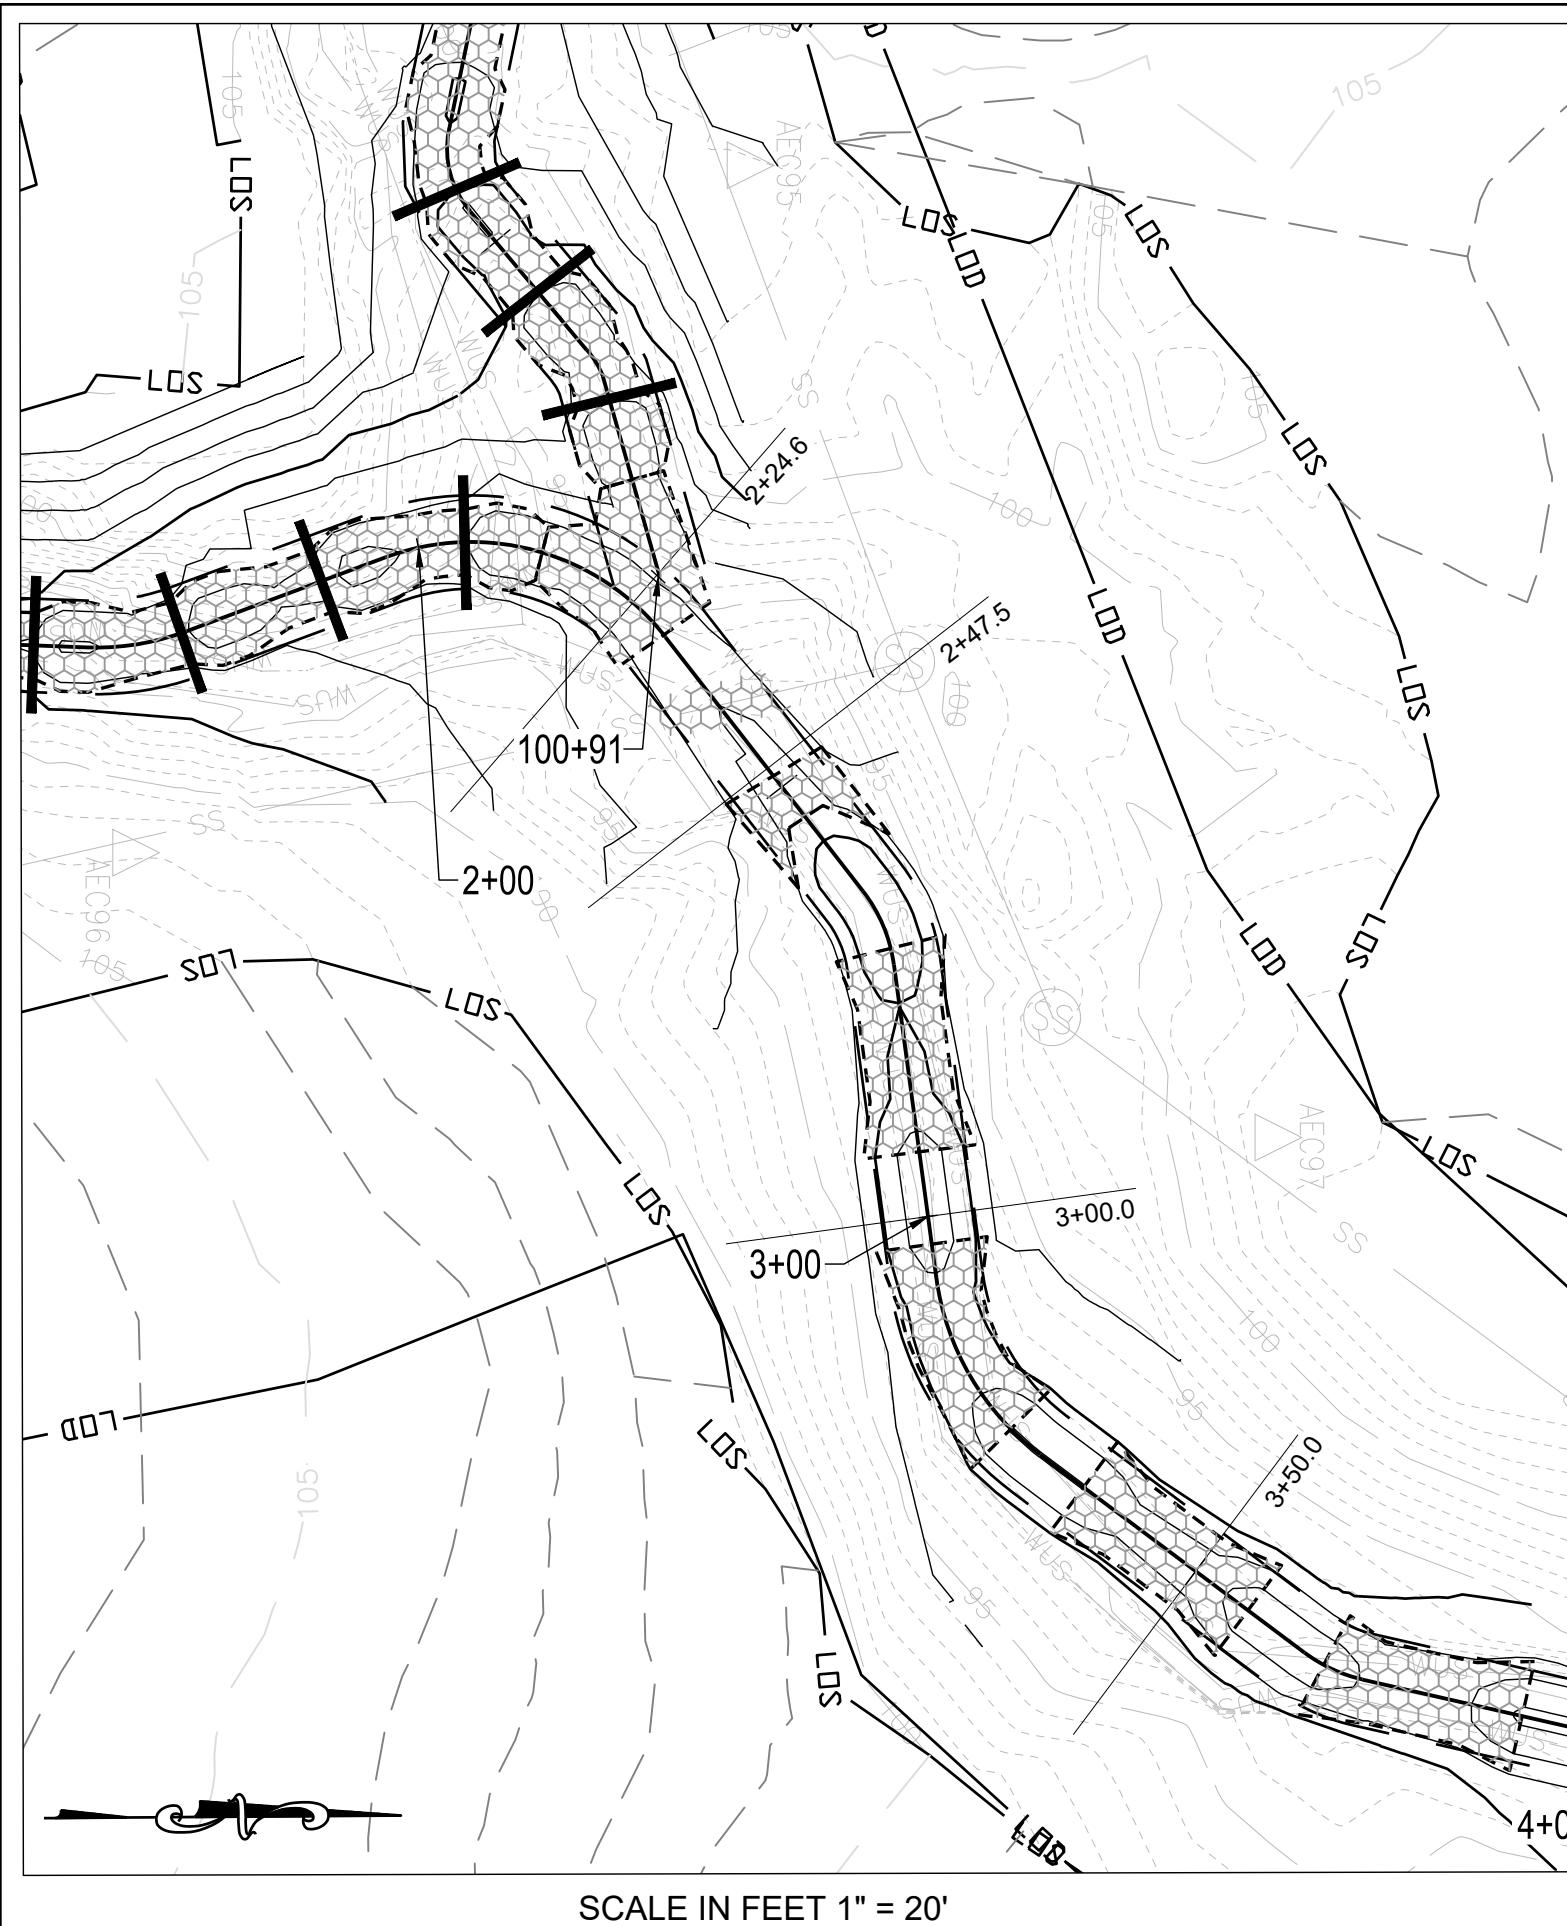


SCALE IN FEET 1" = 200'

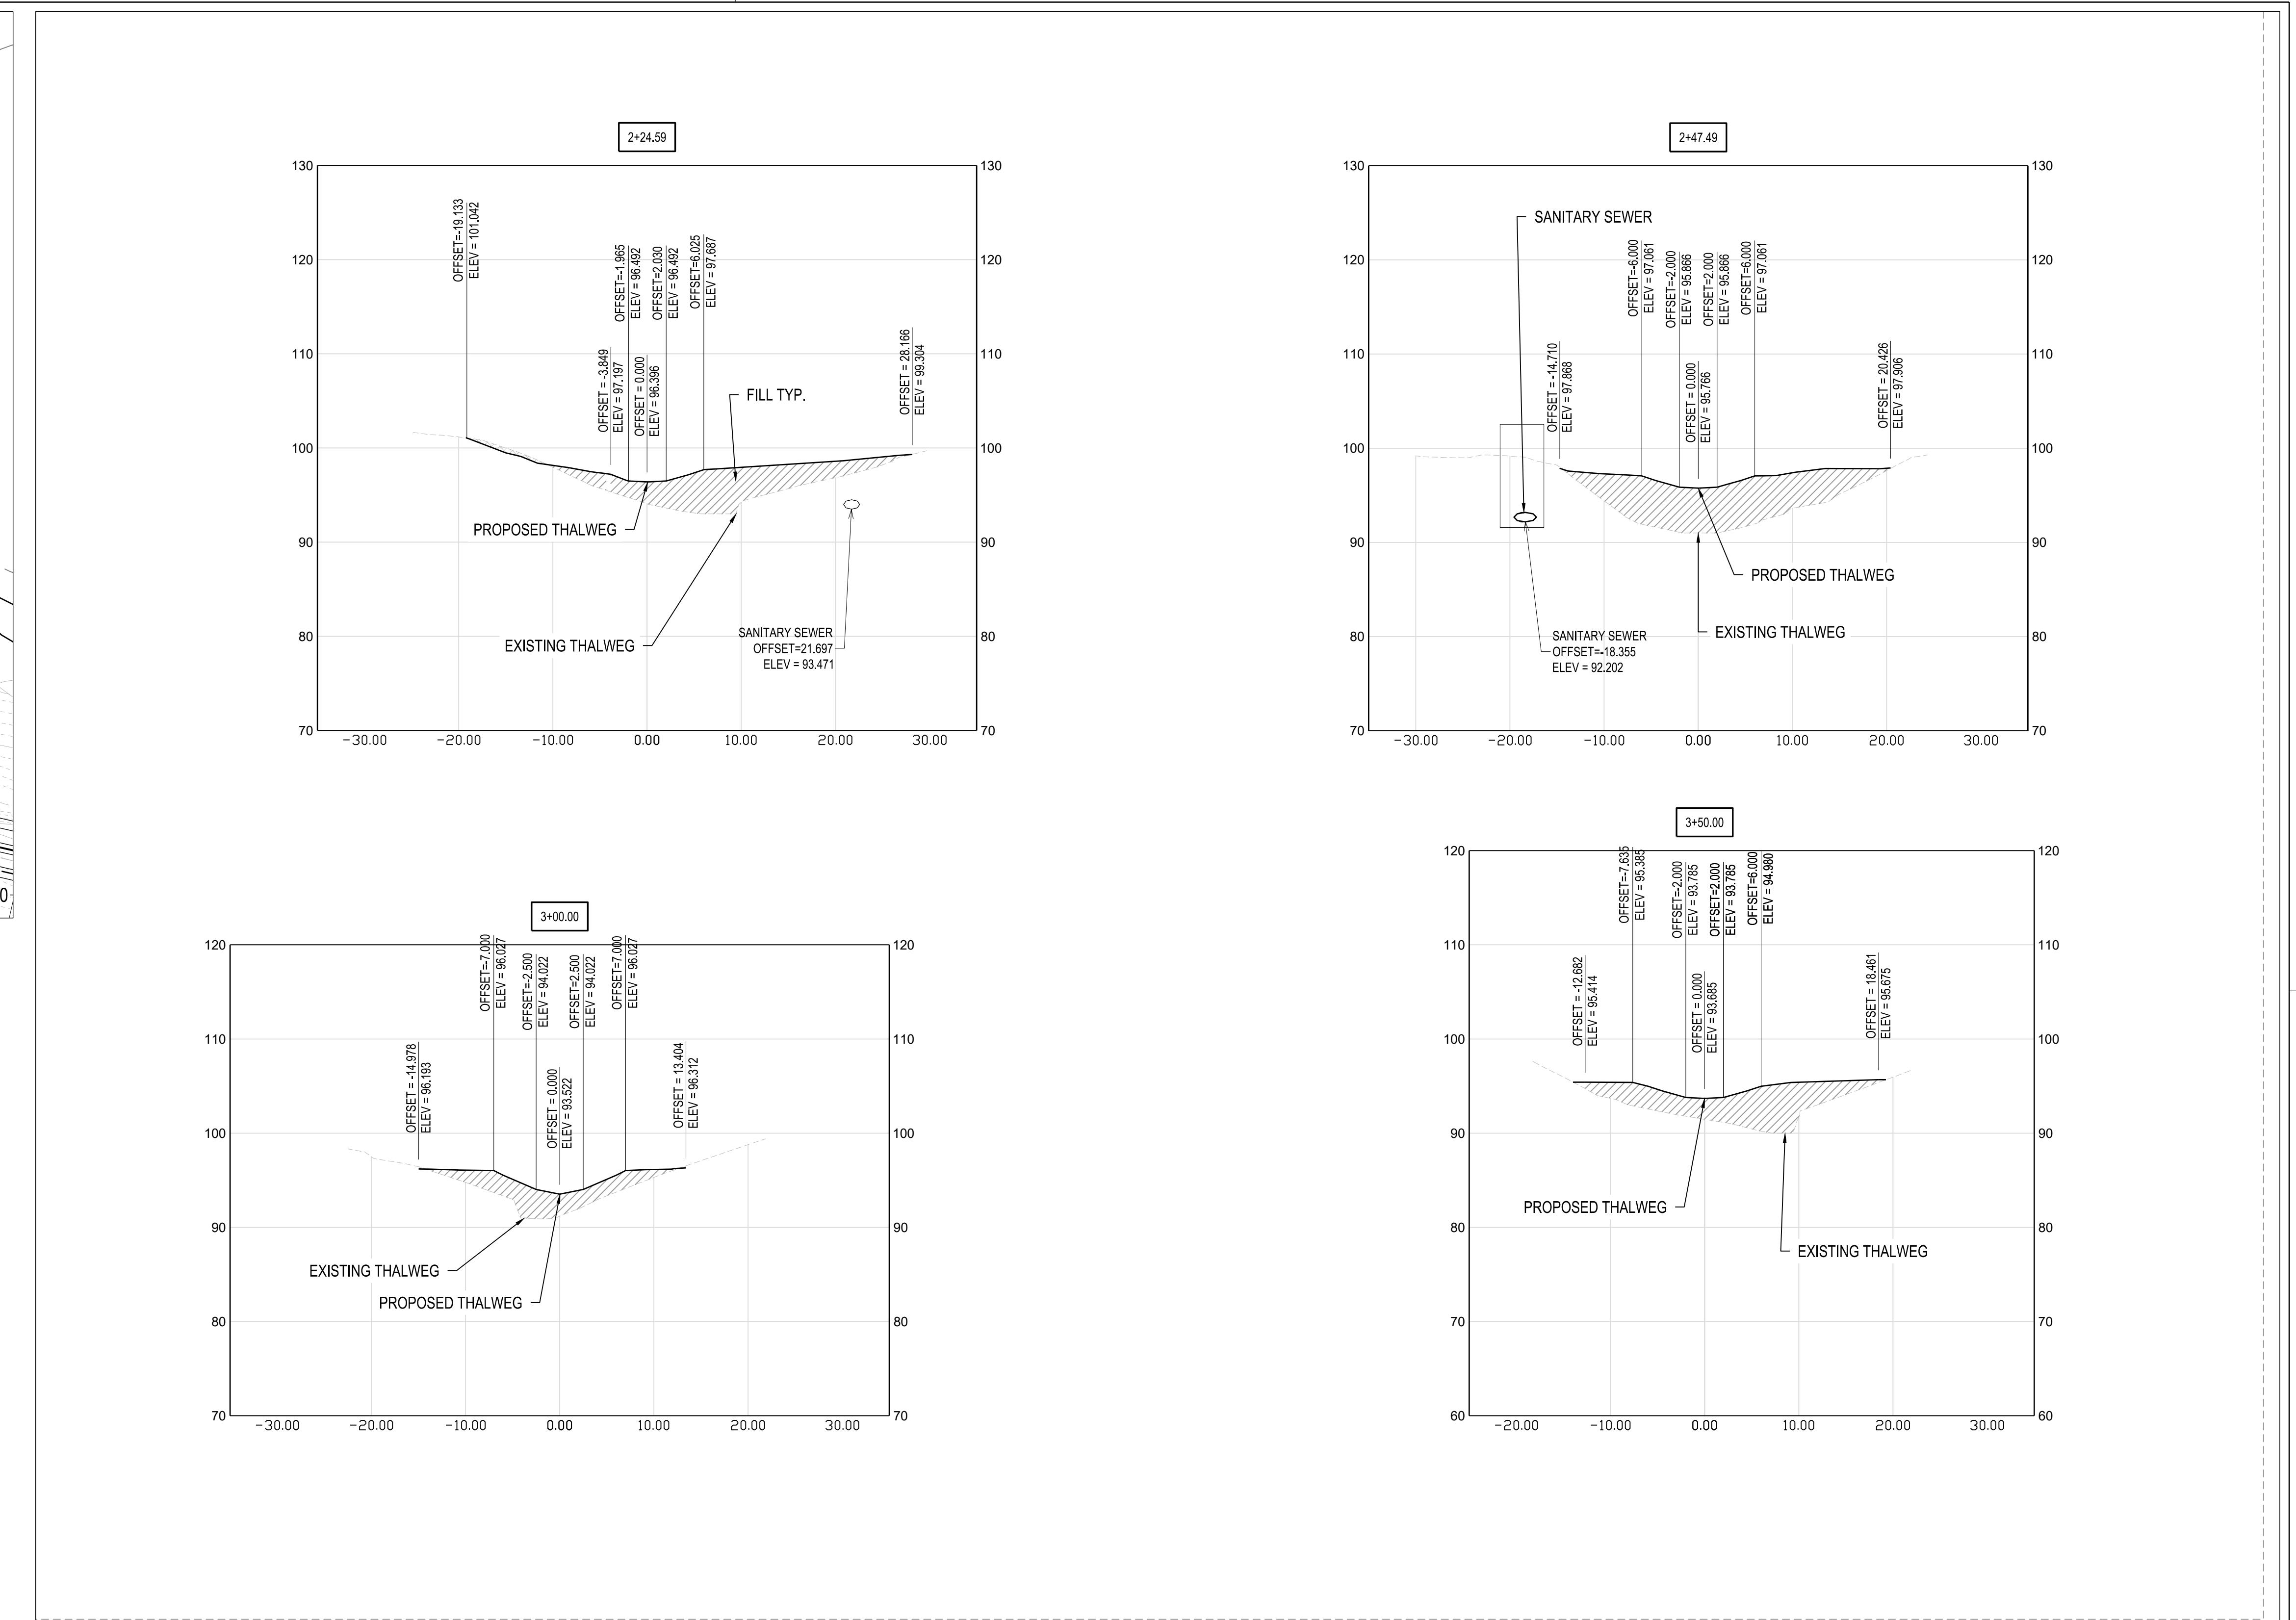

1 REACH 1 AND REACH 2A SECTION VIEWS

SCALE: 1" = 10'

10 0 10

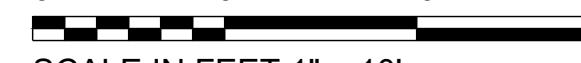

SCALE IN FEET 1" =

S/C PLAN

GRA-0046

Re

SIGN AND


HARFORD COUNTY, MARYLAND

EDGEWATER VILLAGE PARK STREAM RESTORATION SECTION VIEW

AS SHOWN

SEPTEMBER 2025

PROFESSIONAL CERTIFICATION




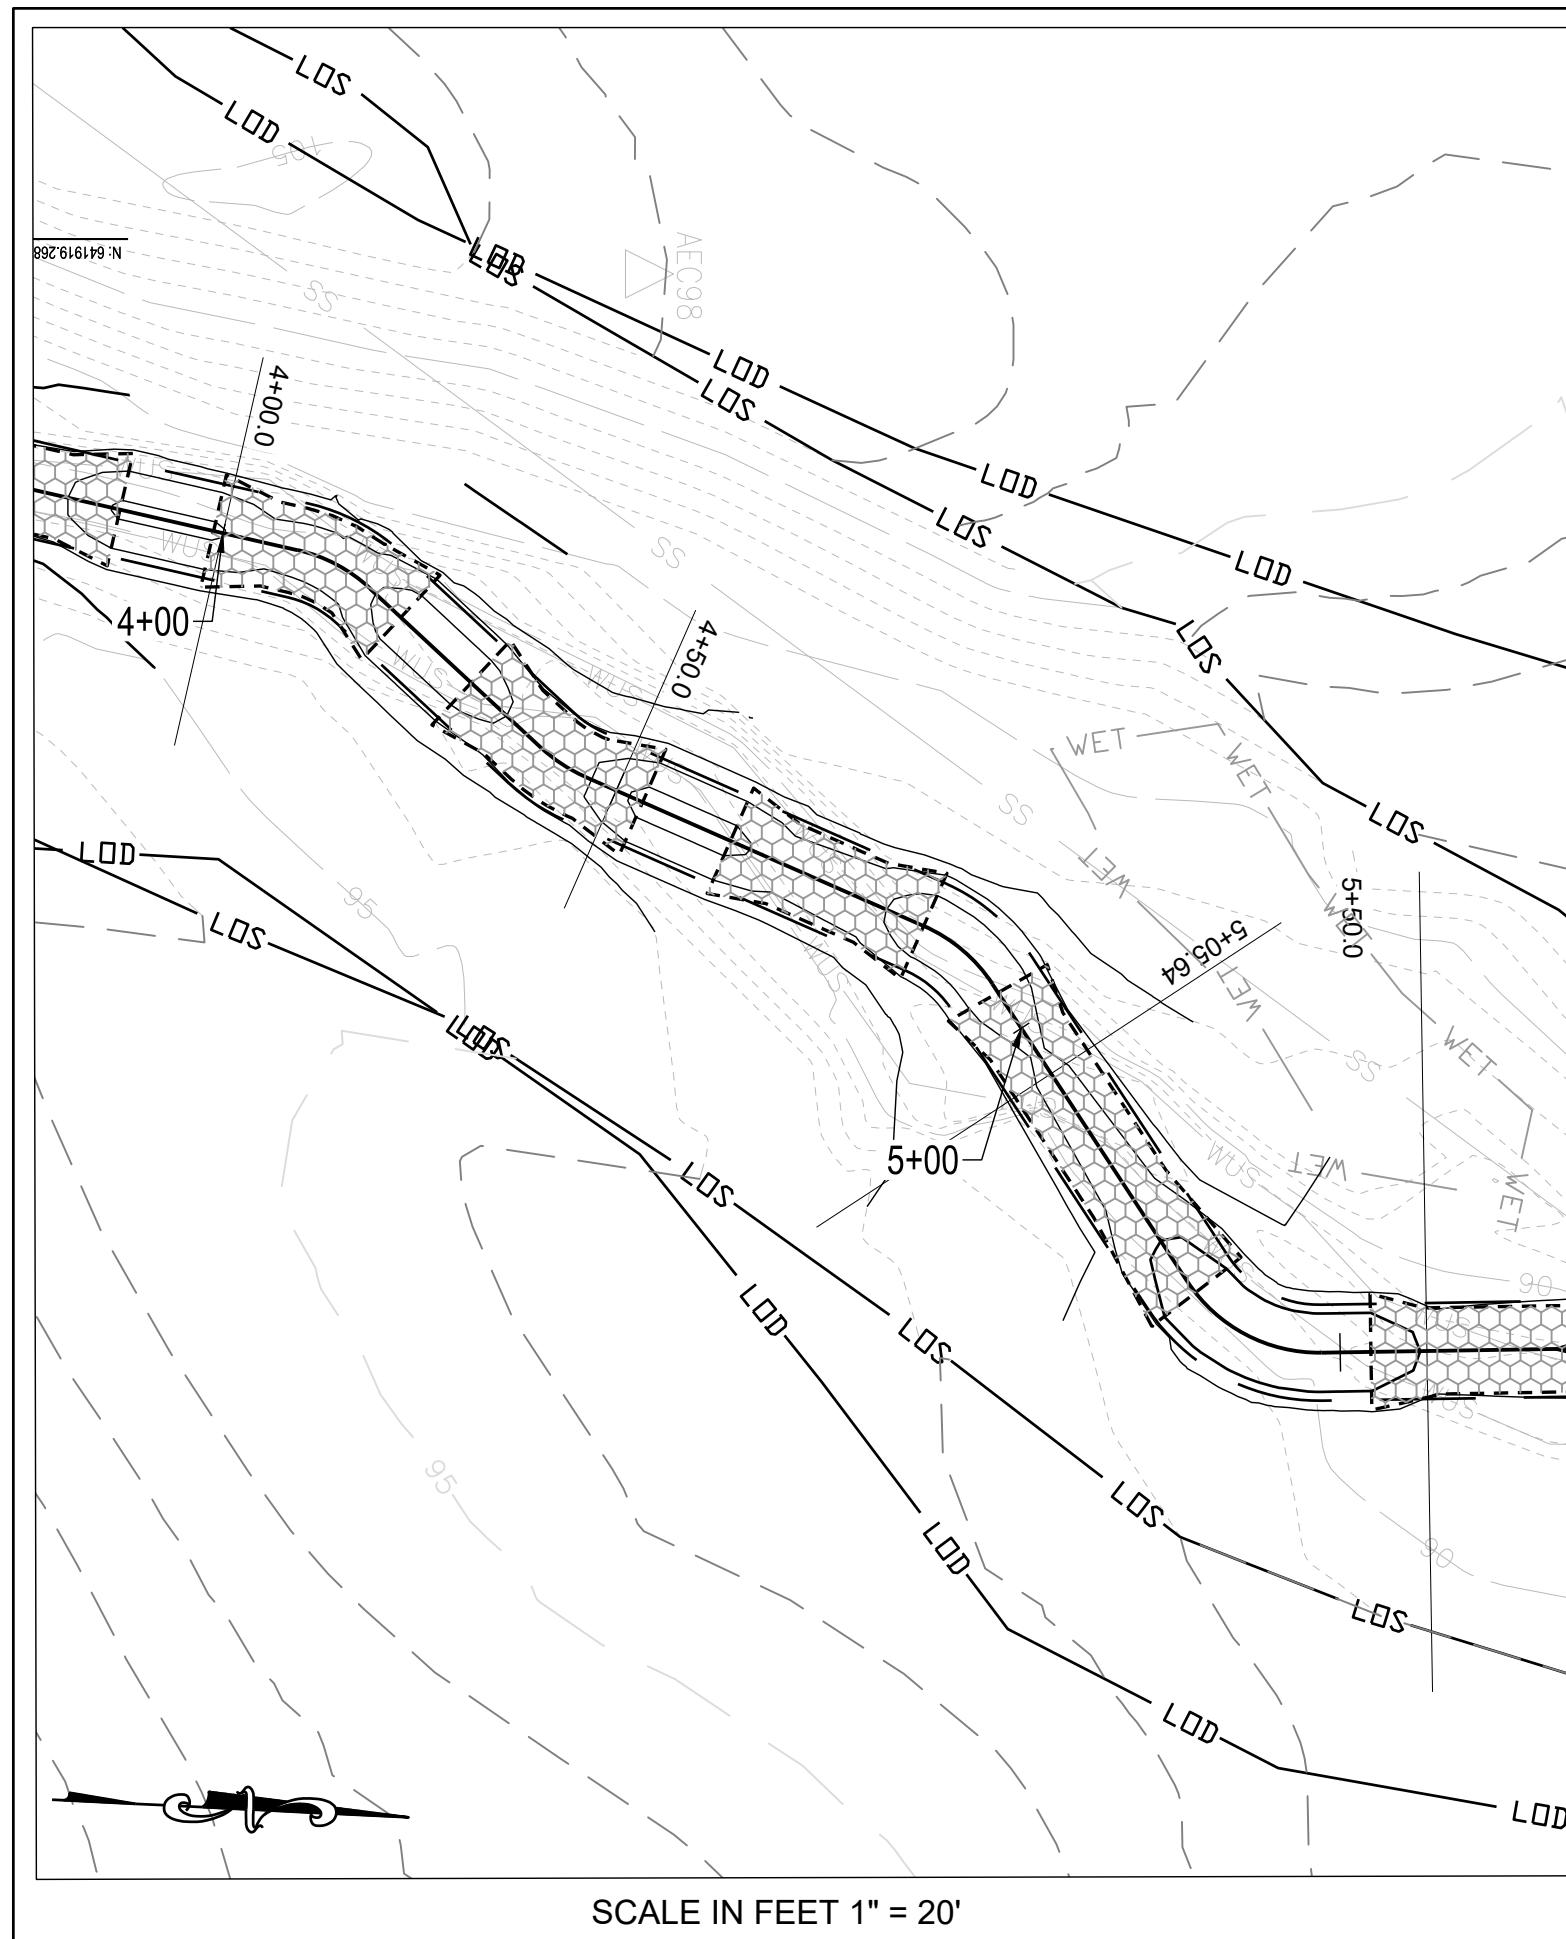


1 REACH 2A SECTION VIEWS

SCALE: 1" = 10'



SCALE IN FEET 1" = 10'

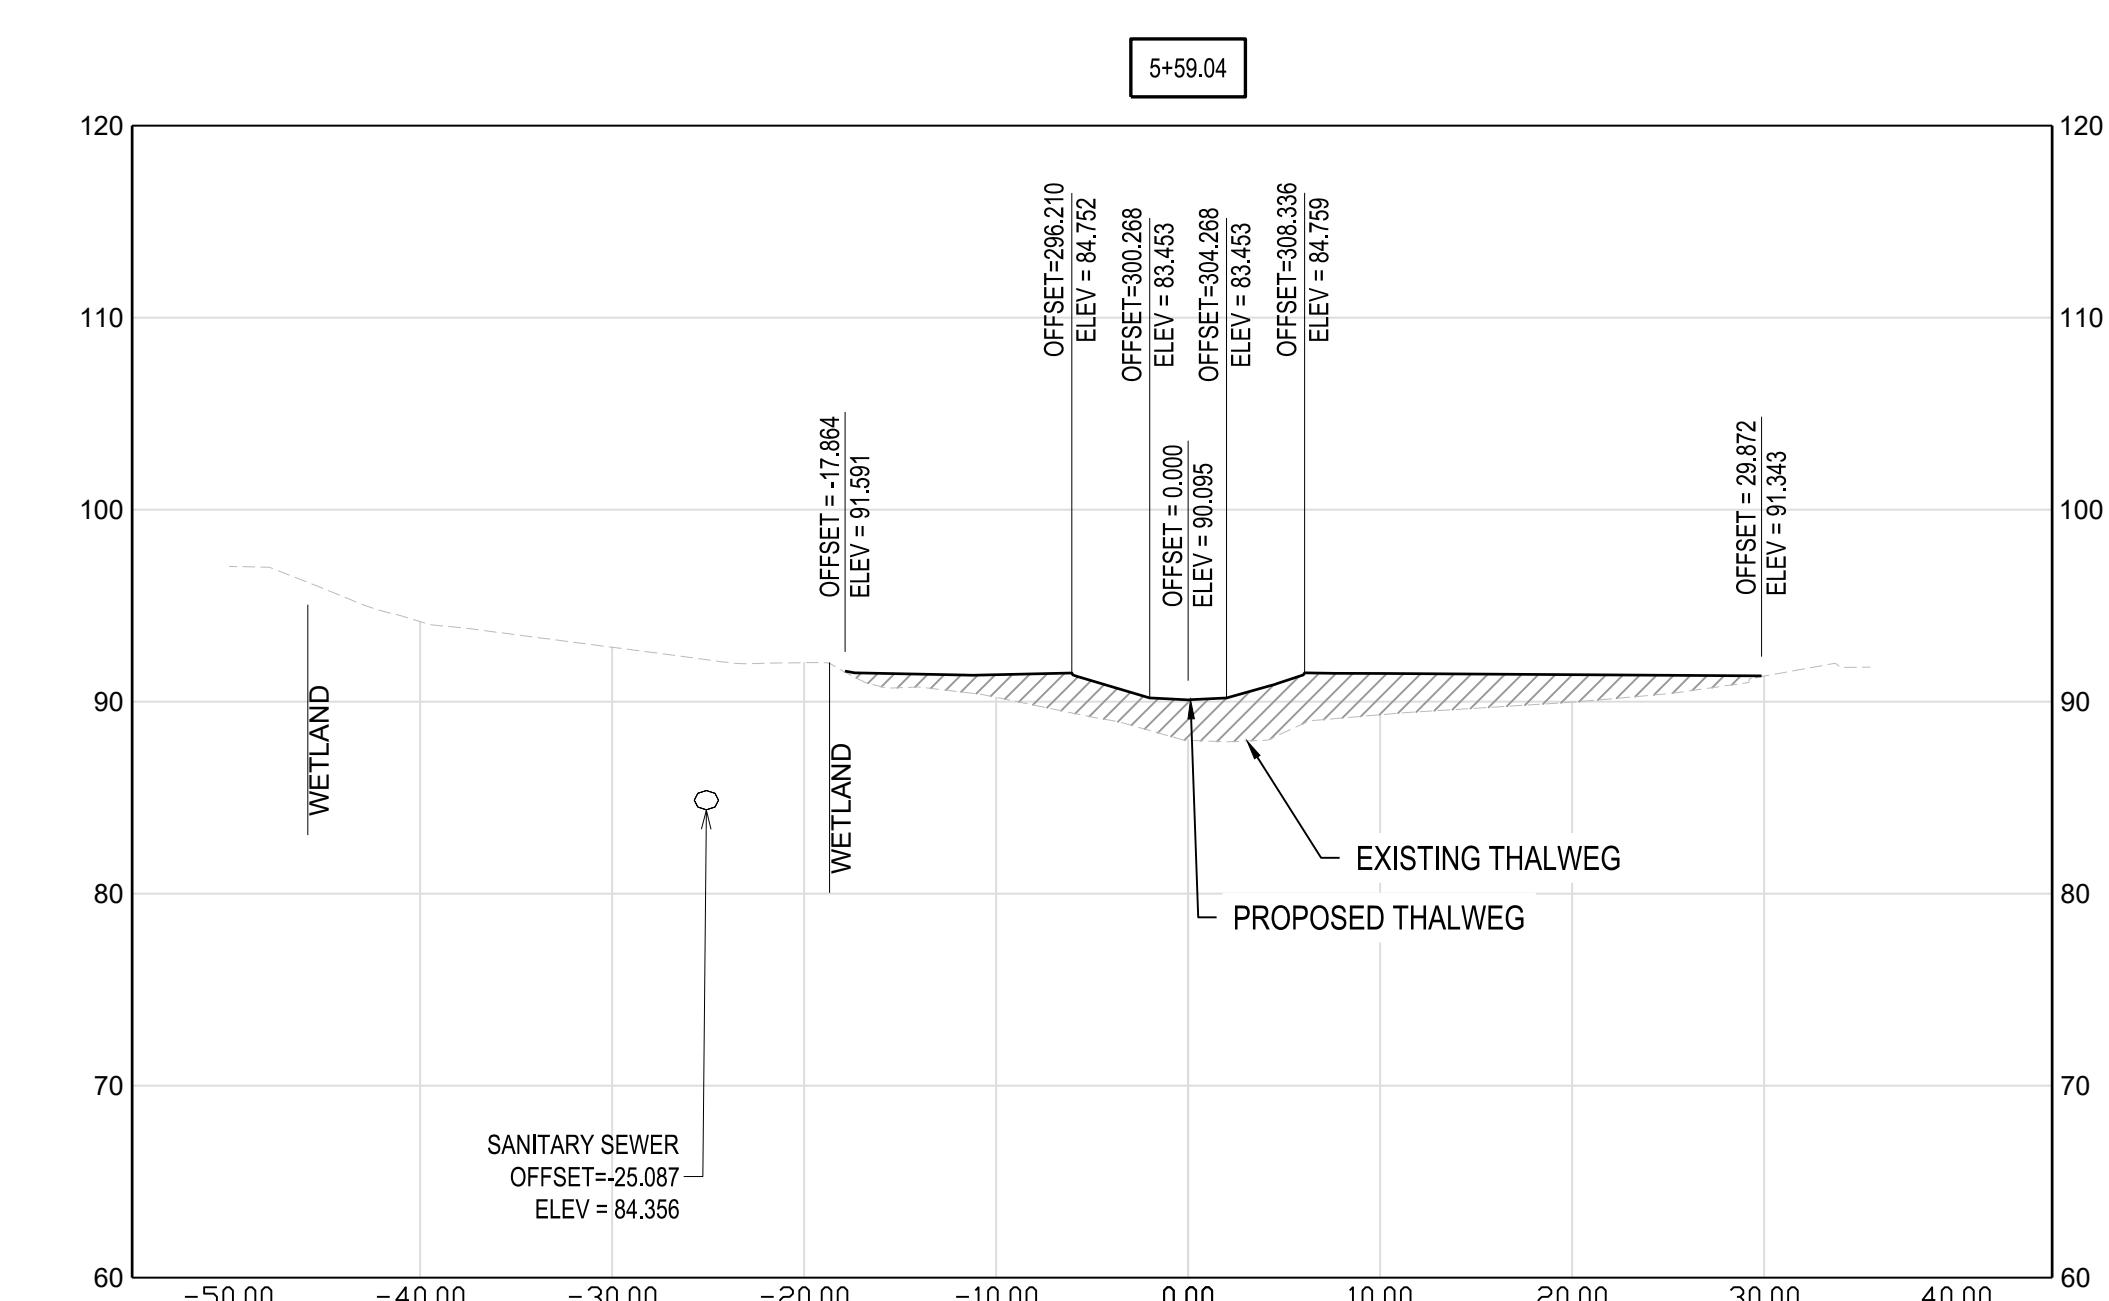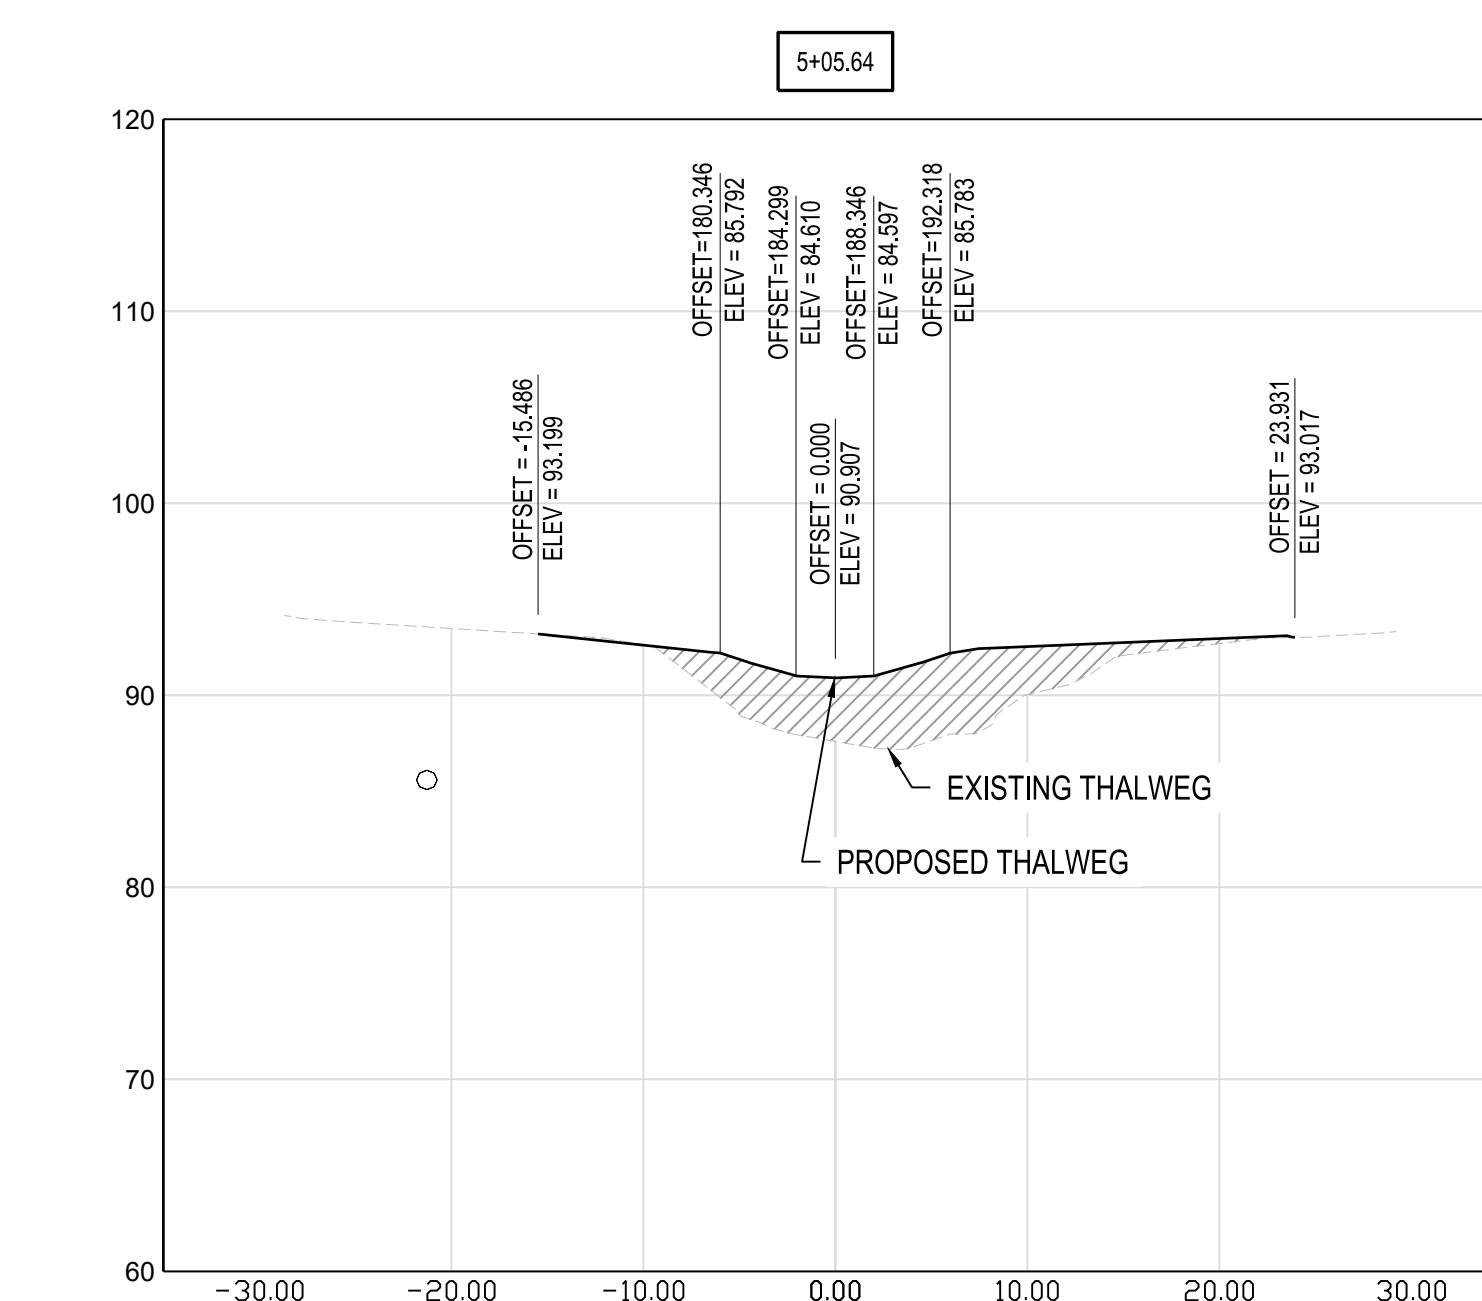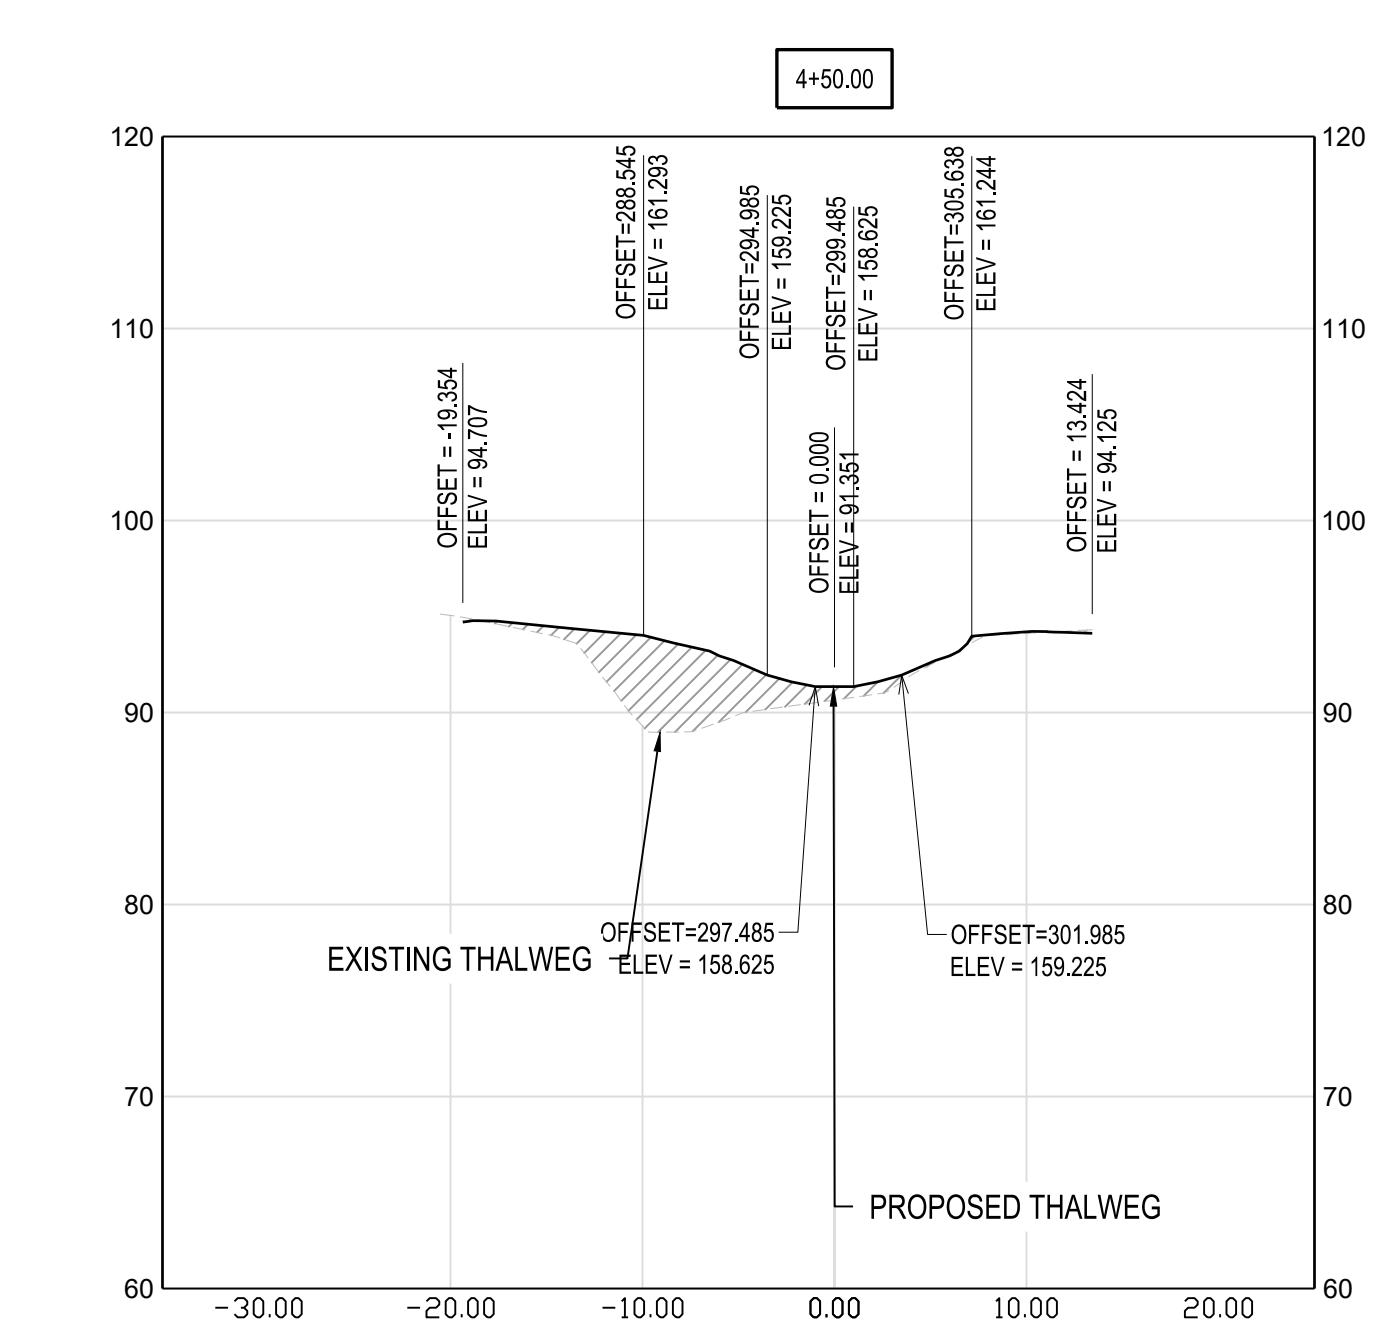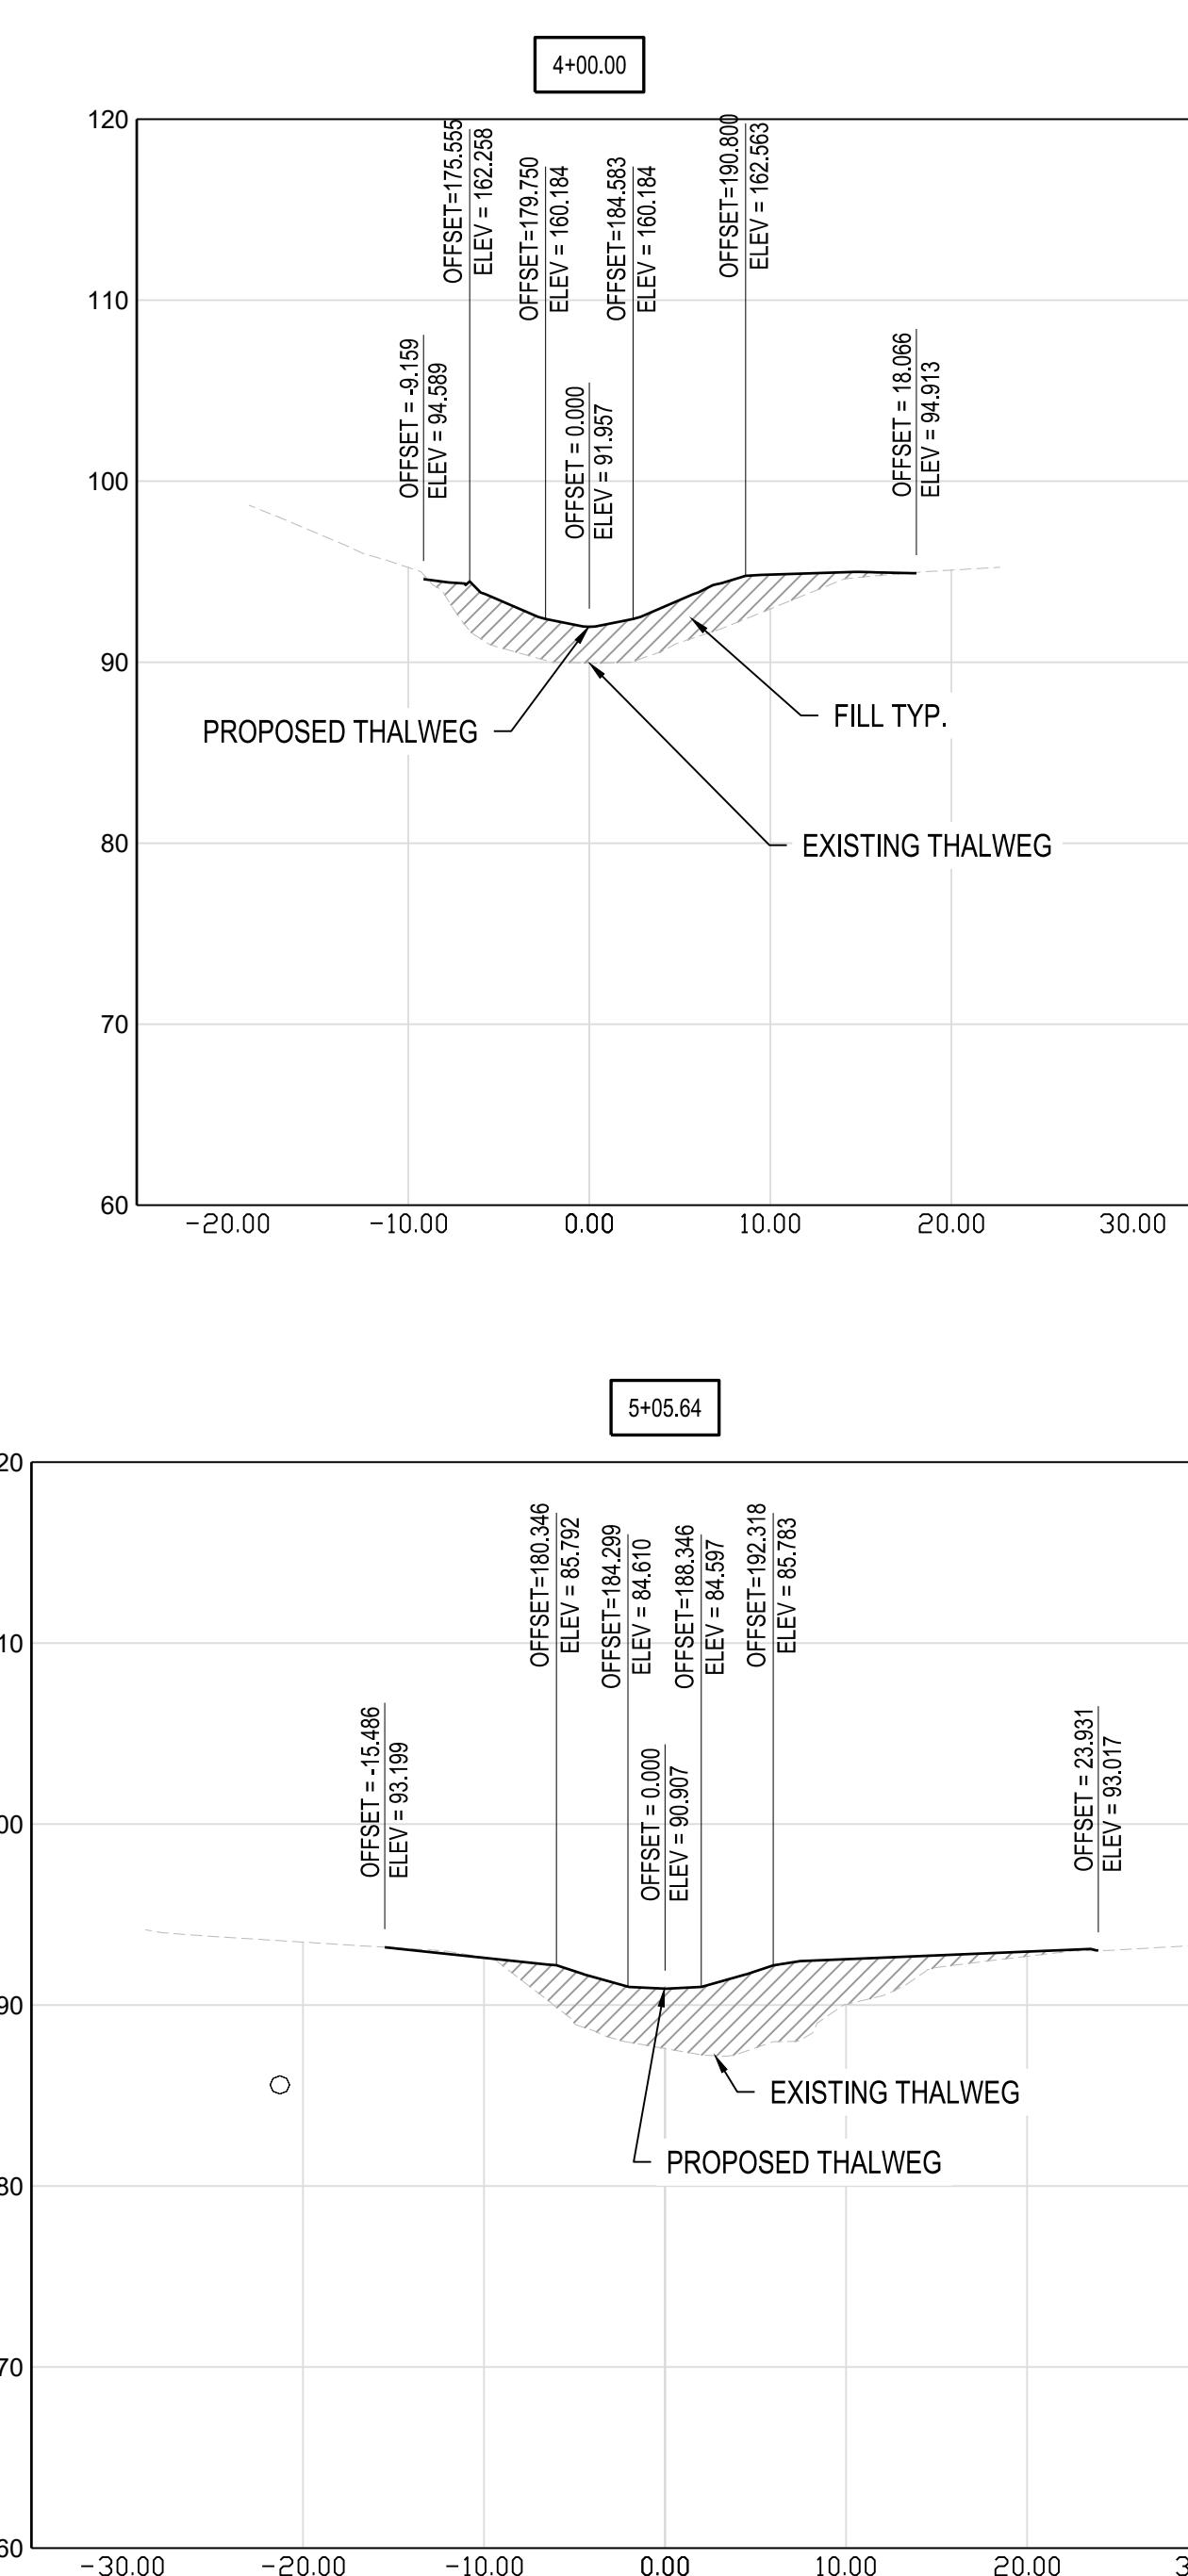

HARFORD COUNTY, MARYLAND

EDGEWATER VILLAGE PARK
STREAM RESTORATION
SECTION VIEW

S/C PLAN # 59914

Revisions

GRA-004622-2025

SIGN AND SEAL

Drawn By : CA

Designed By : CA

Reviewed By : BWA

AS SHOWN

Scale : SEPTEMBER 2025



Date :

PROFESSIONAL CERTIFICATION

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AND THAT I AM A DULY LICENSED PROFESSIONAL ENGINEER UNDER THE LAWS OF
THE STATE OF MARYLAND LICENSE NO. XXXXX, EXPIRATION DATE: XX/XX/XXXX.

Drawing No. SE-04 of SE-12

Sheet No.

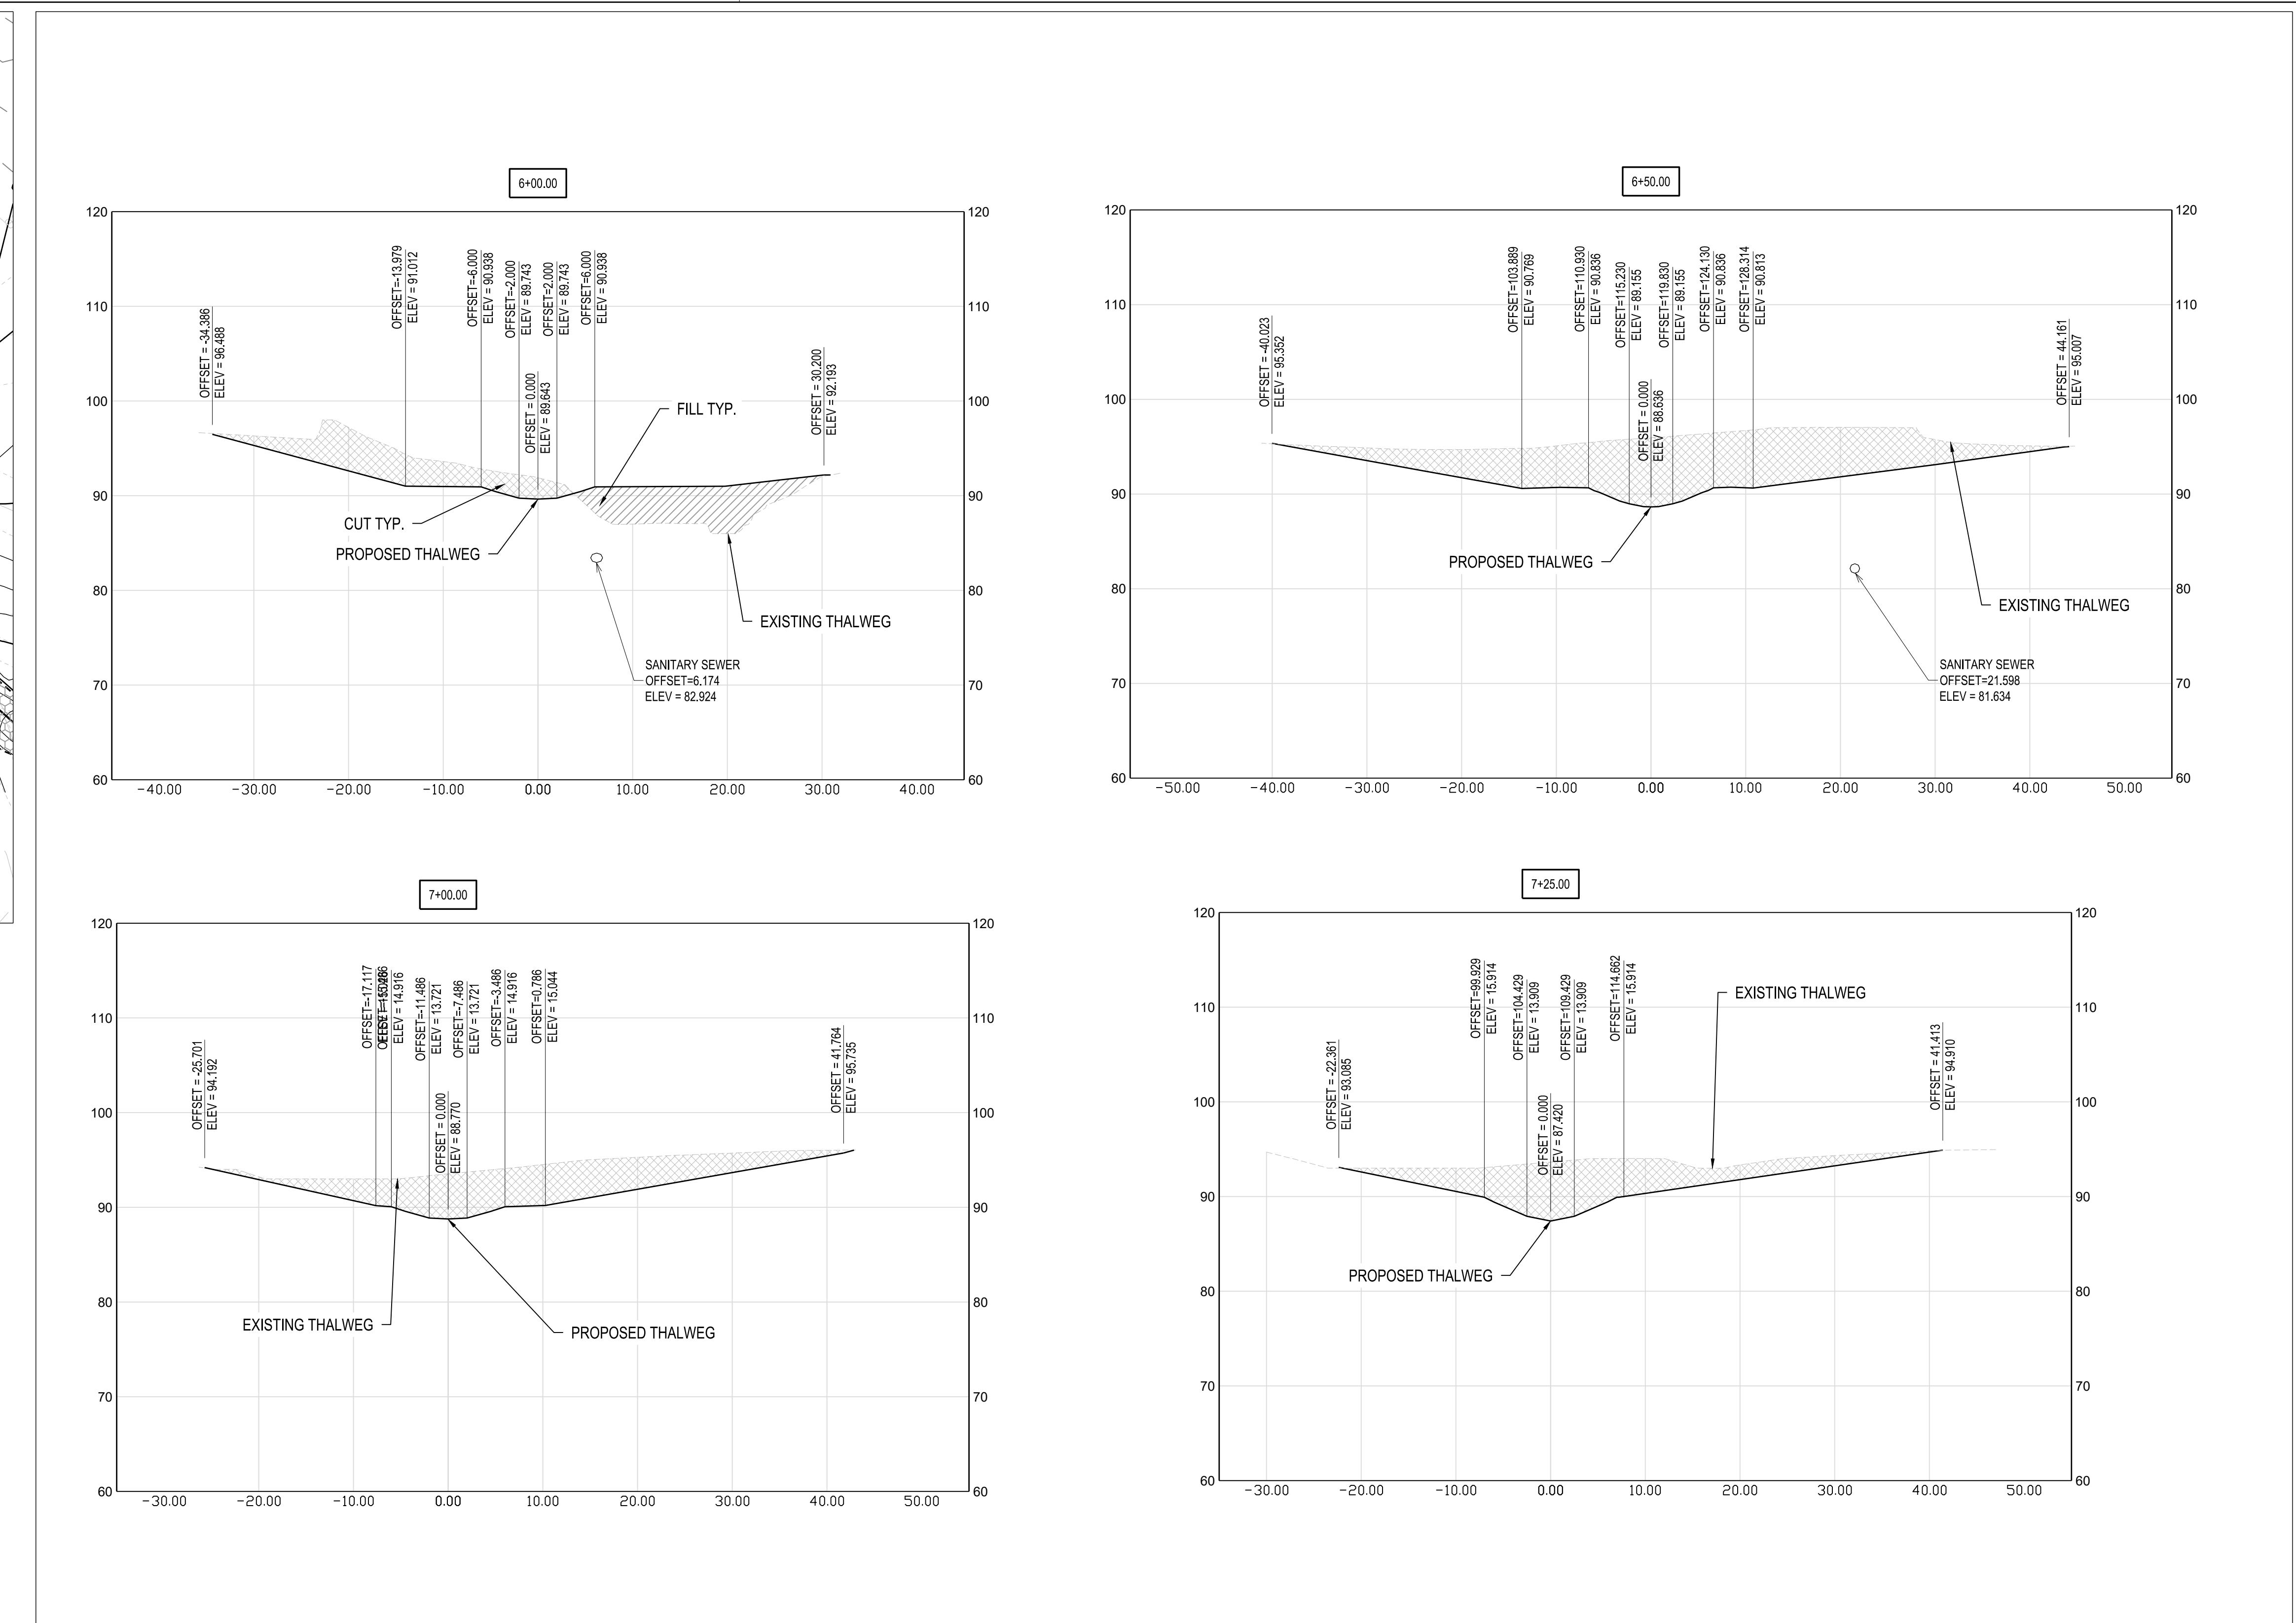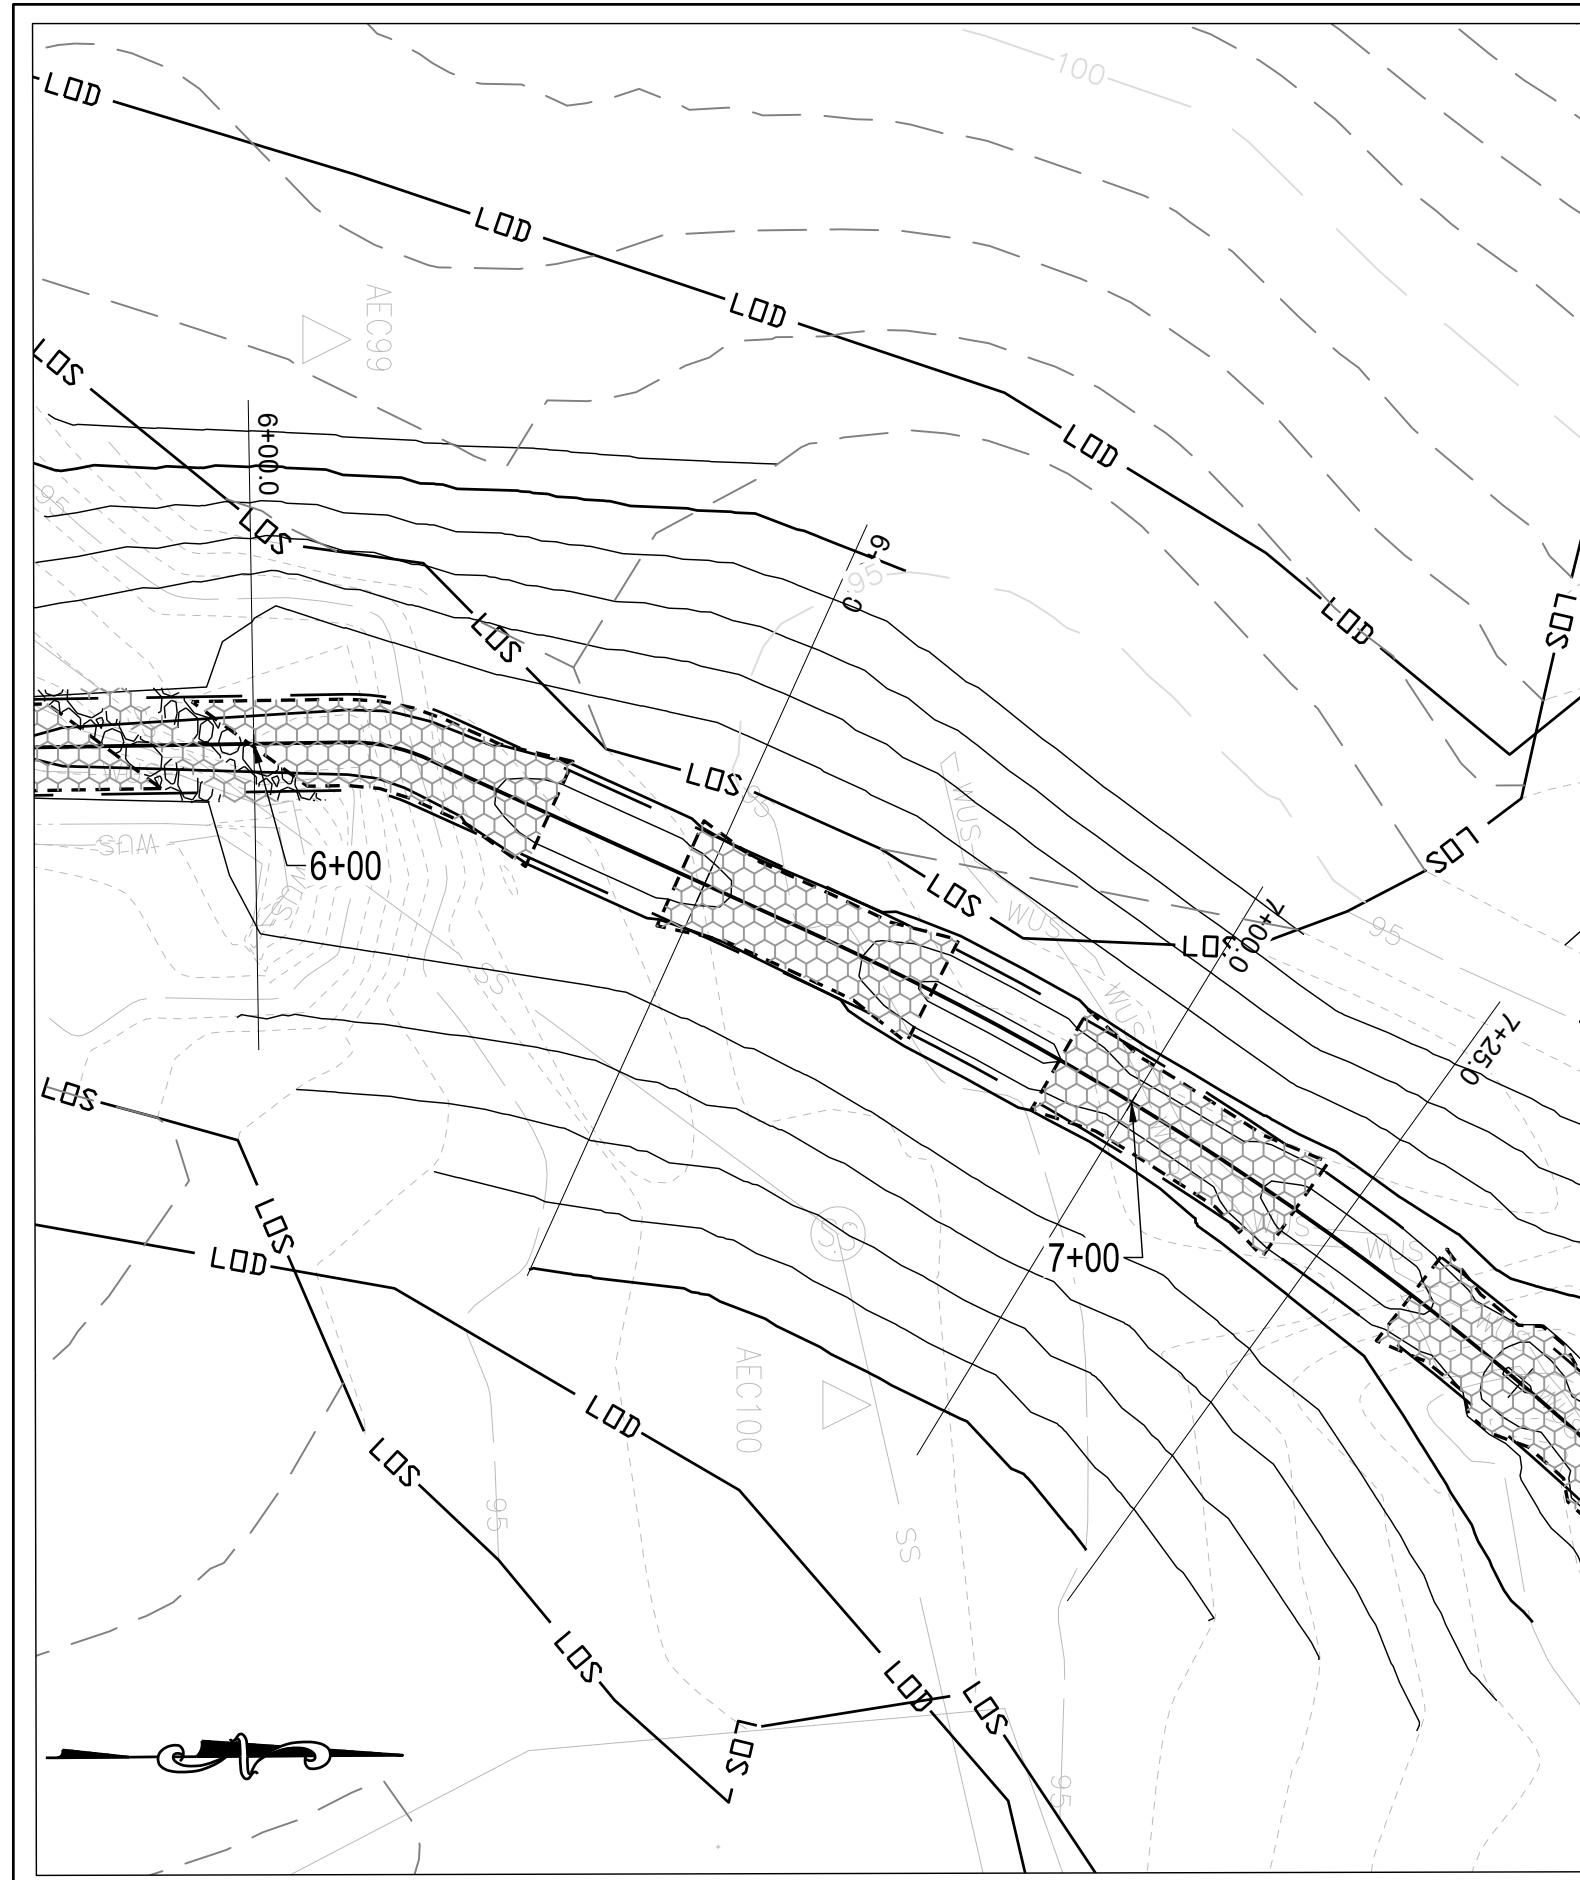

1 REACH 2B SECTION VIEWS

SCALE: 1" = 10'



SCALE IN FEET 1" = 10'

S/C PLAN # 59914

GRA-004622-2025

SIGN AND SEAL

HARFORD COUNTY, MARYLAND

EDGEWATER VILLAGE PARK
STREAM RESTORATION
SECTION VIEW



AS SHOWN
Scale :
Date : SEPTEMBER 2025

Drawn By : CA
Designed By : CA
Reviewed By : BWA

Drawing No. SE-05 of SE-12
Sheet No. 29 of 65

PROFESSIONAL CERTIFICATION

I HEREBY CERTIFY THAT THESE DOCUMENTS WERE PREPARED OR APPROVED BY ME,
AND THAT I AM A DULY LICENSED PROFESSIONAL ENGINEER UNDER THE LAWS OF
THE STATE OF MARYLAND. LICENSE NO. XXXXX, EXPIRATION DATE: XX/XX/XXXX.

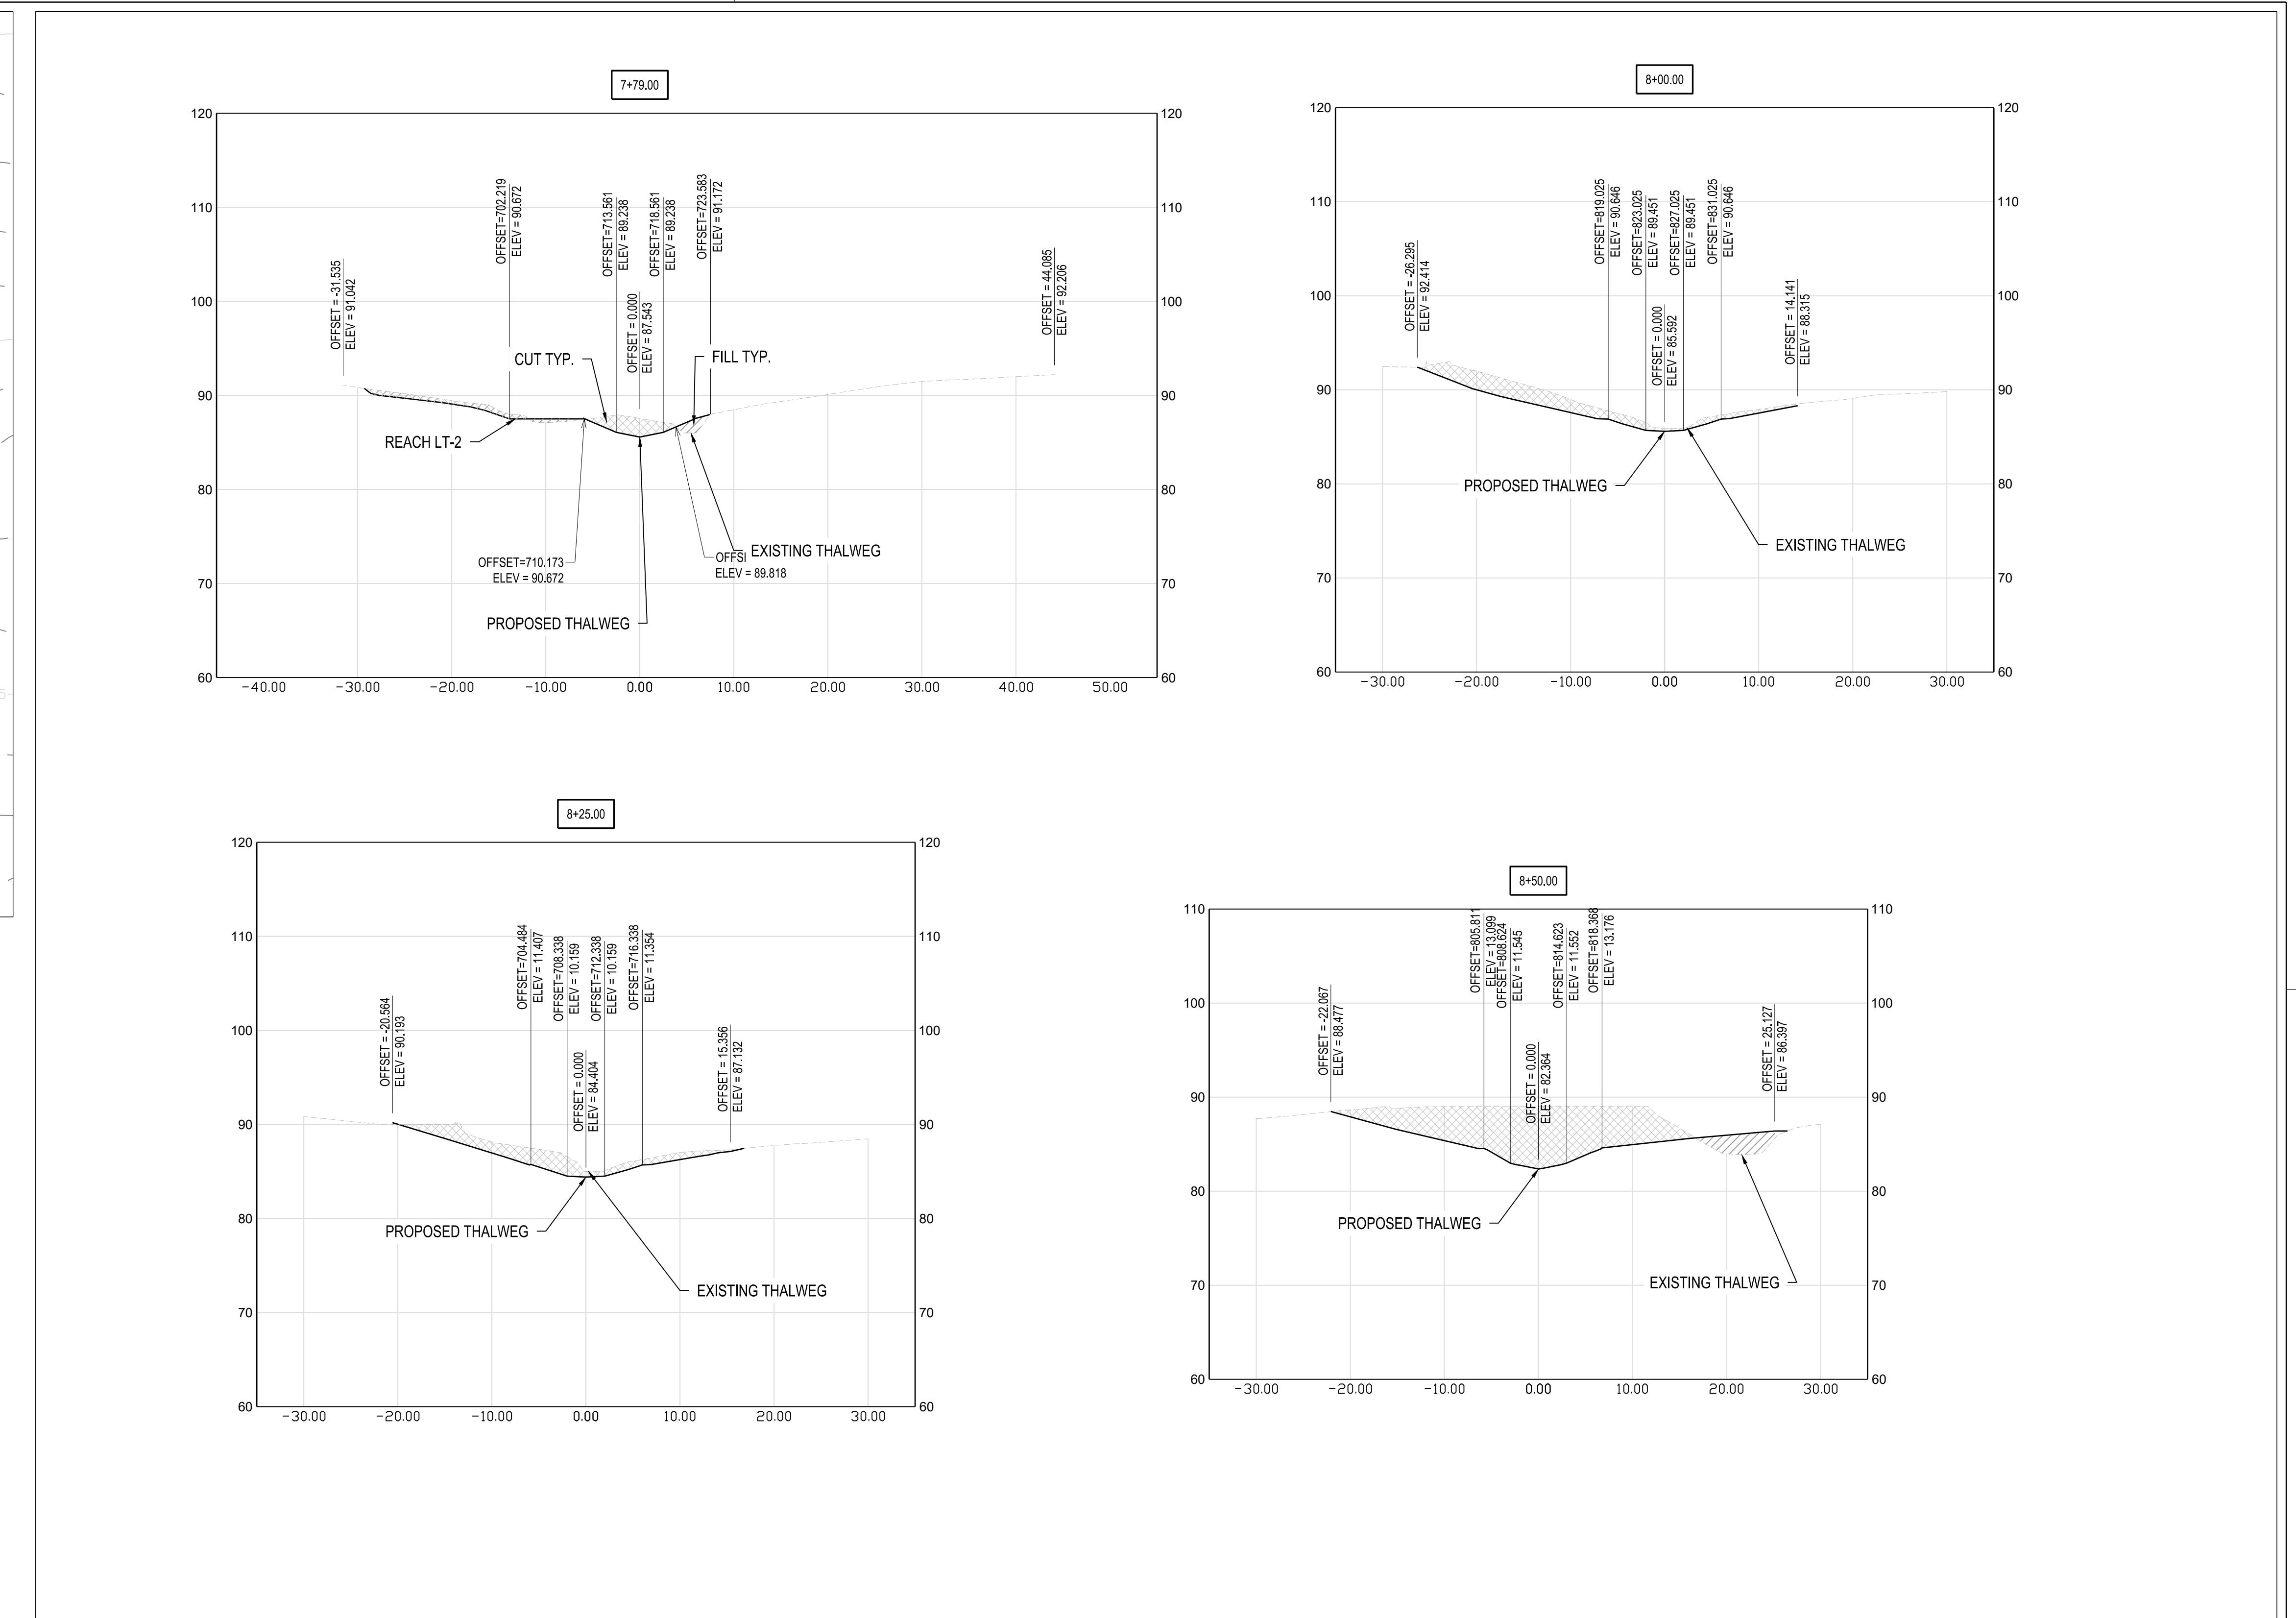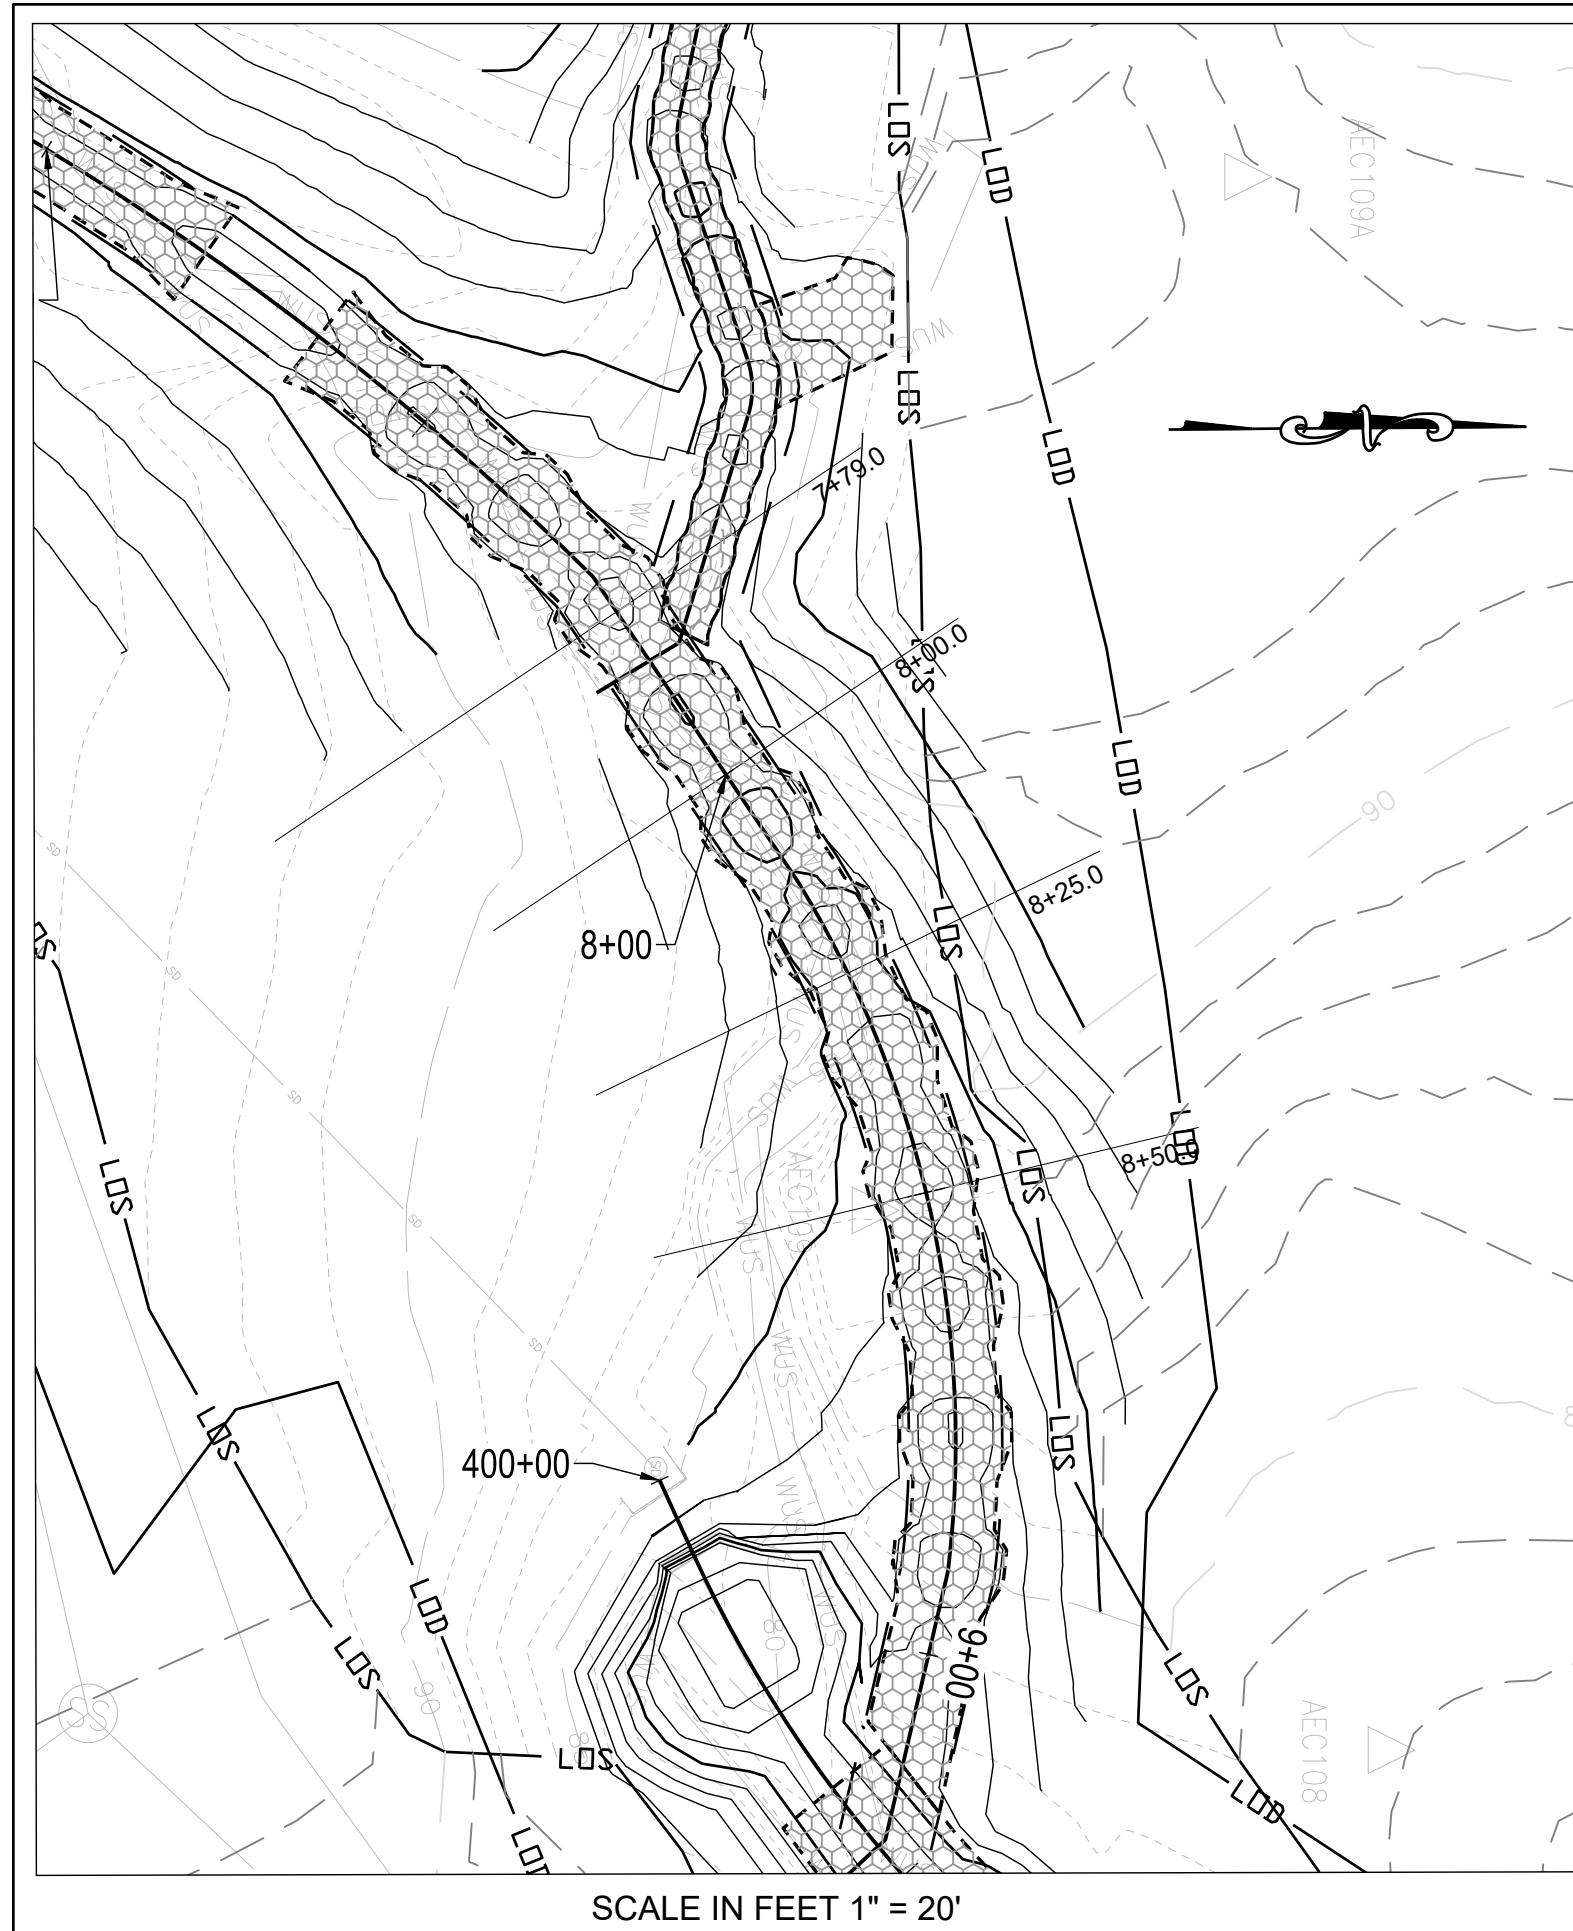

1 REACH 2B SECTION VIEWS

SCALE: 1" = 10'





SCALE IN FEET 1" = 10'

S/C PLAN # 59914
GRA-004622-2025
PROFESSIONAL CERTIFICATION
I HEREBY CERTIFY THAT THESE DOCUMENTS WERE PREPARED OR APPROVED BY ME,
AND THAT I AM A DULY LICENSED PROFESSIONAL ENGINEER UNDER THE LAWS OF
THE STATE OF MARYLAND LICENSE NO. XXXXX, EXPIRATION DATE: XX/XX/XXXX.

Revisions
SIGN AND SEAL

HARFORD COUNTY, MARYLAND
EDGEWATER VILLAGE PARK
STREAM RESTORATION
SECTION VIEW
Drown By : CA
Designed By : CA
Reviewed By : BWA
Drawing No. SE-06 of SE-12
Scale : AS SHOWN
Date : SEPTEMBER 2025
HGC DWG ID No.:
BID No.:
1 inch
Sheet No. 30 of 65

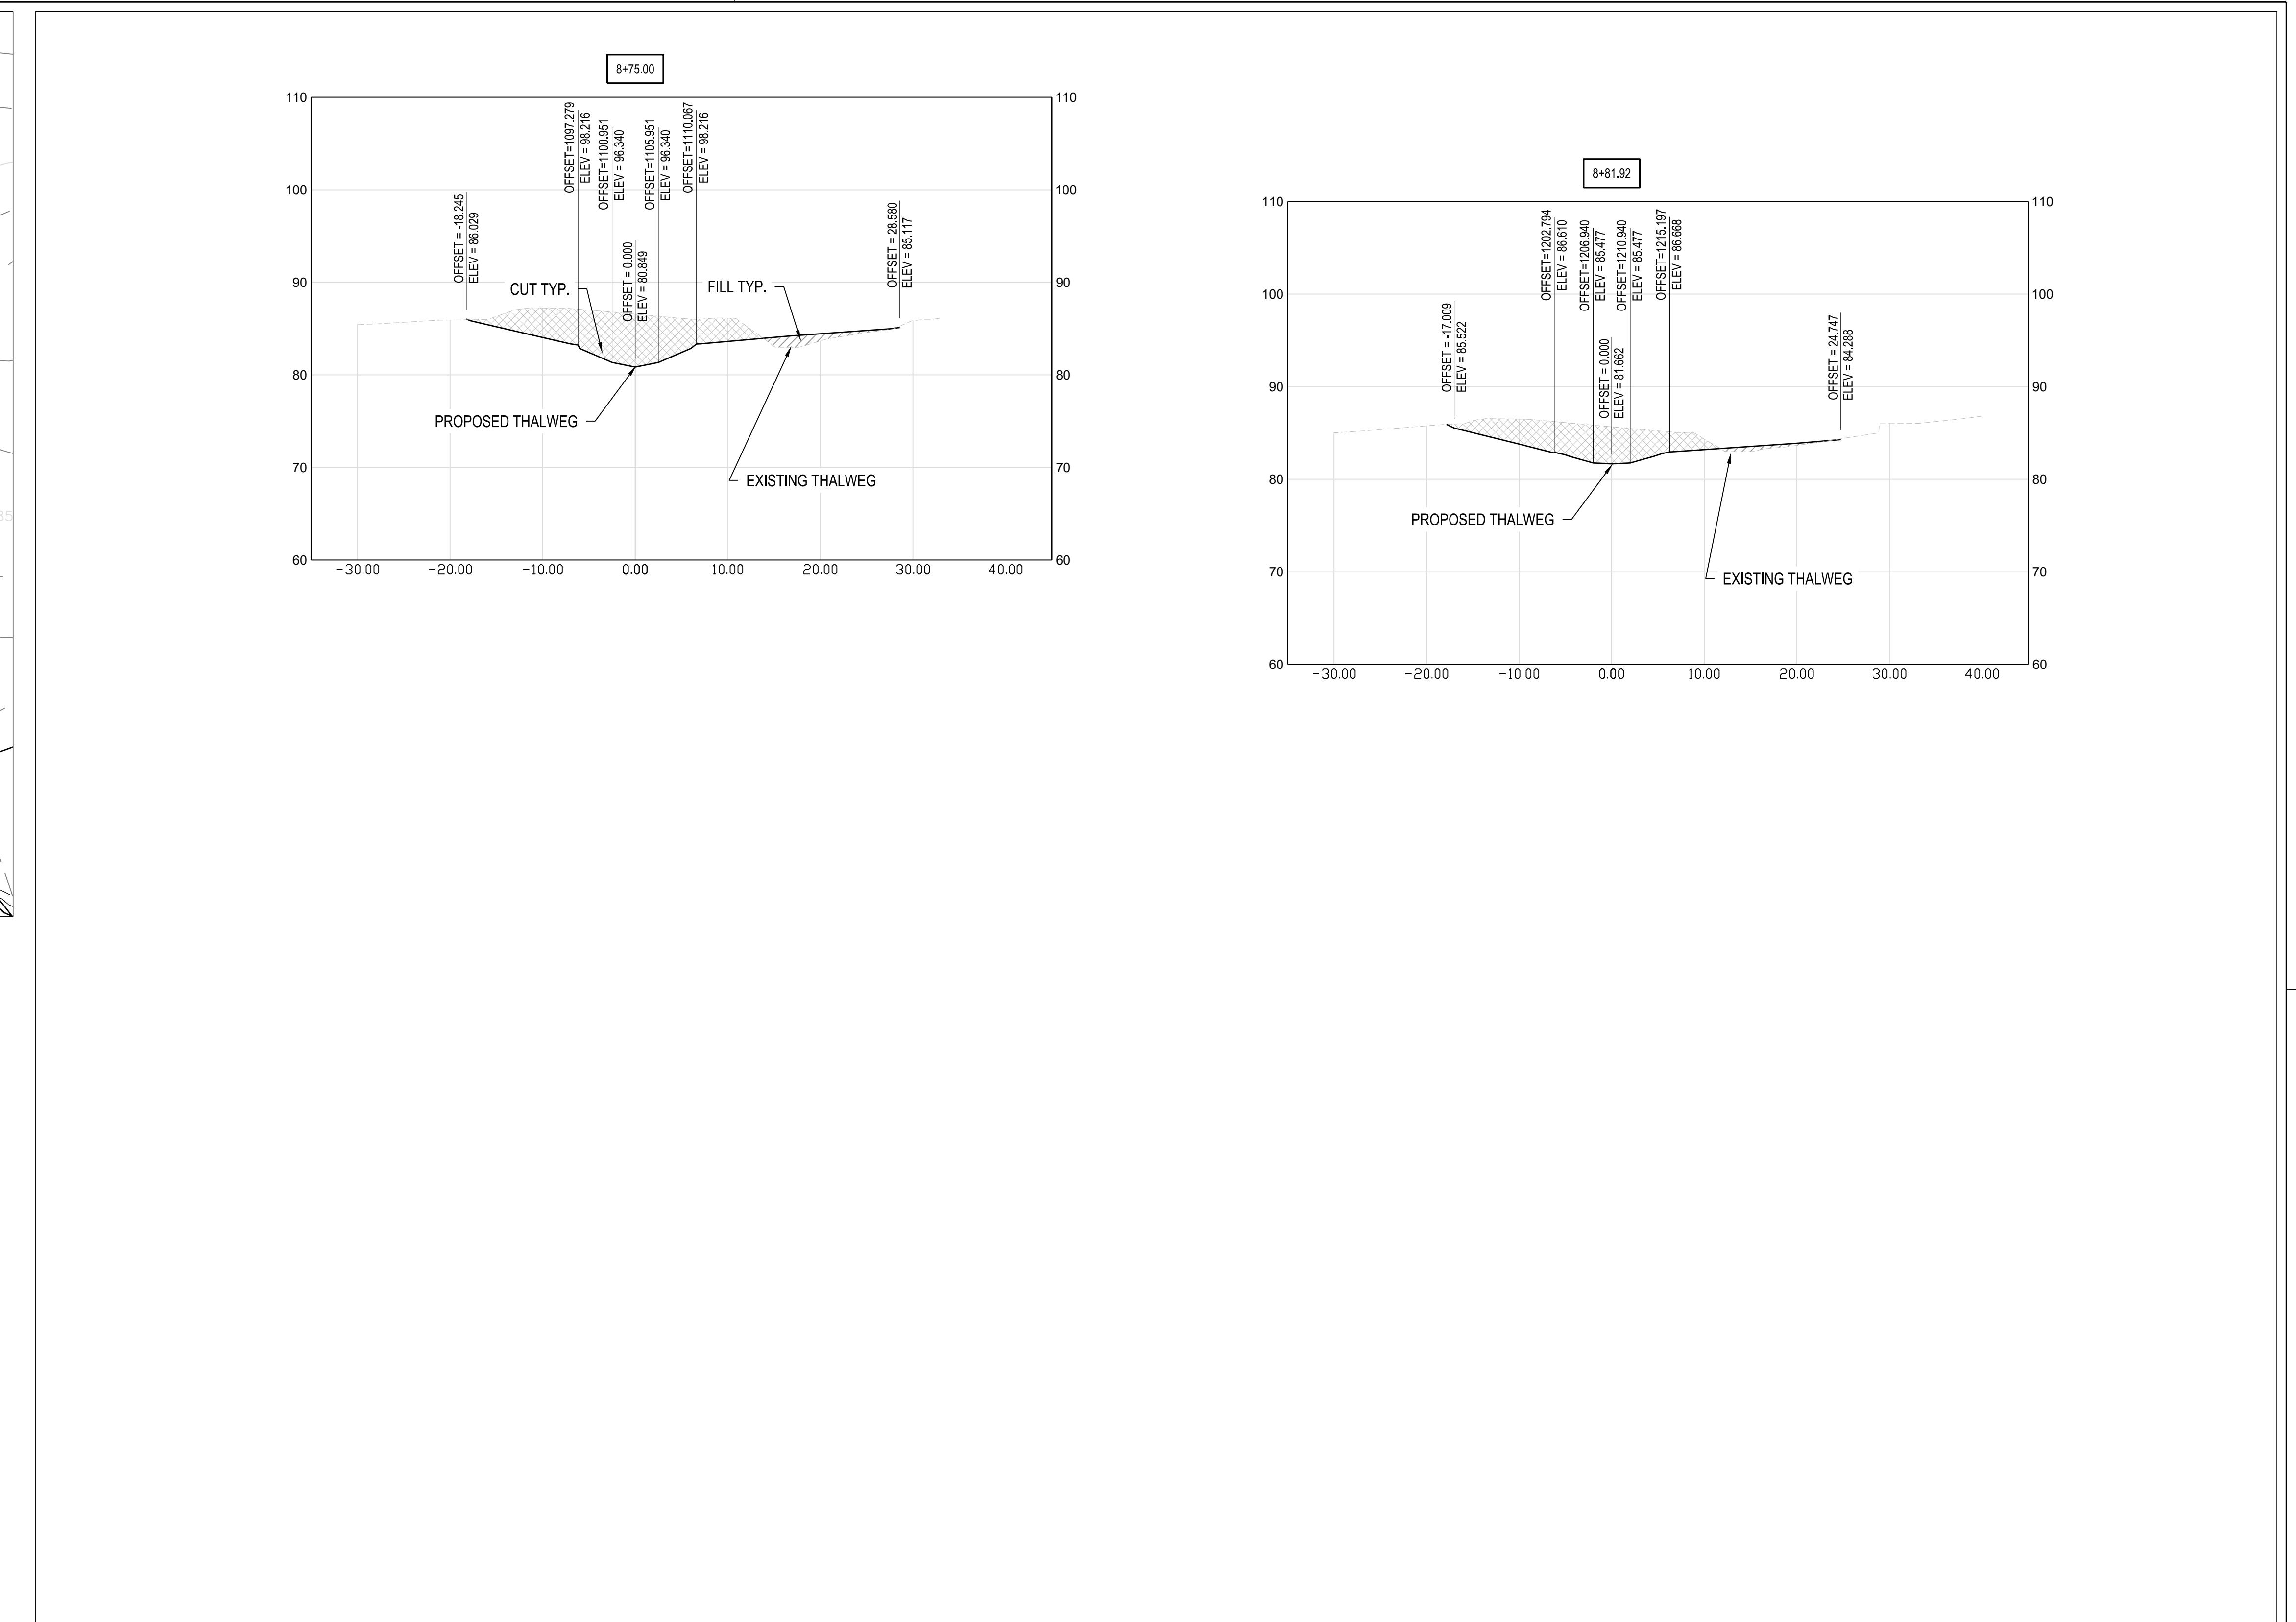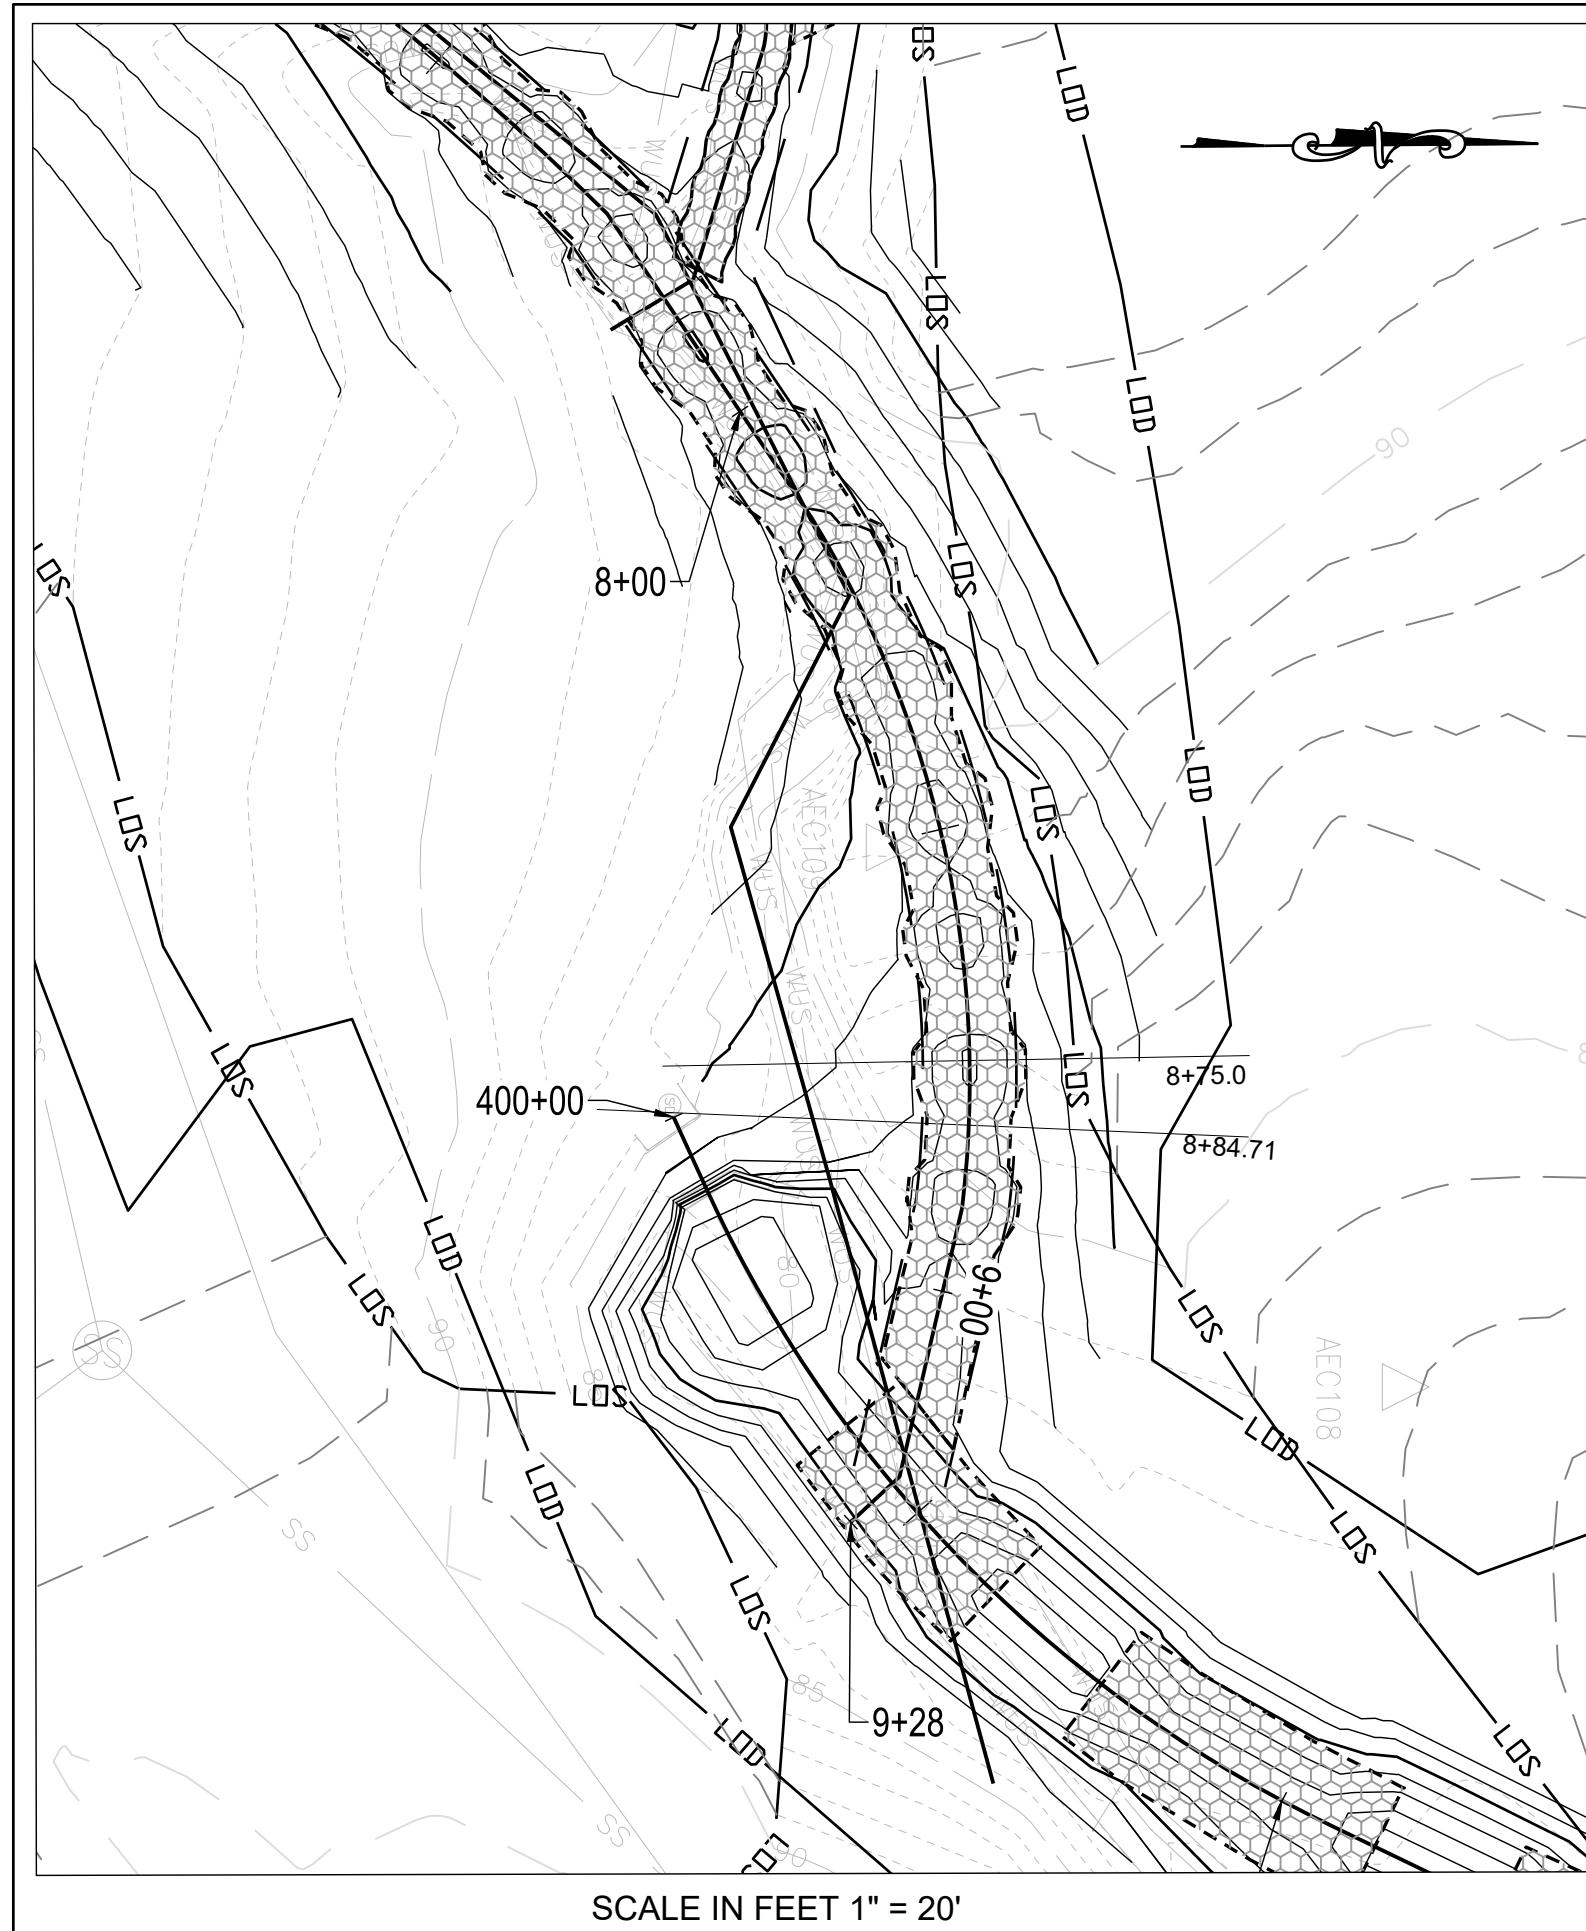

1 REACH 2B SECTION VIEWS



SCALE: 1" = 10'
10 0 10 20

SCALE IN FEET 1" = 10'

S/C PLAN # 59914	Revisions	HARFORD COUNTY, MARYLAND			
GRA-004622-2025	EDGEWATER VILLAGE PARK				
STREAM RESTORATION					
SECTION VIEW					
Drawn By : CA	AS SHOWN	Scale : AS SHOWN			
Designed By : CA		Date : SEPTEMBER 2025			
Reviewed By : BWA					
Drawing No. SE-07 of SE-12	Sheet No. 31 of 65				

PROFESSIONAL CERTIFICATION

I HEREBY CERTIFY THAT THESE DOCUMENTS WERE PREPARED OR APPROVED BY ME,
AND THAT I AM A DULY LICENSED PROFESSIONAL ENGINEER UNDER THE LAWS OF
THE STATE OF MARYLAND LICENSE NO. XXXXX, EXPIRATION DATE: XX/XX/XXXX.

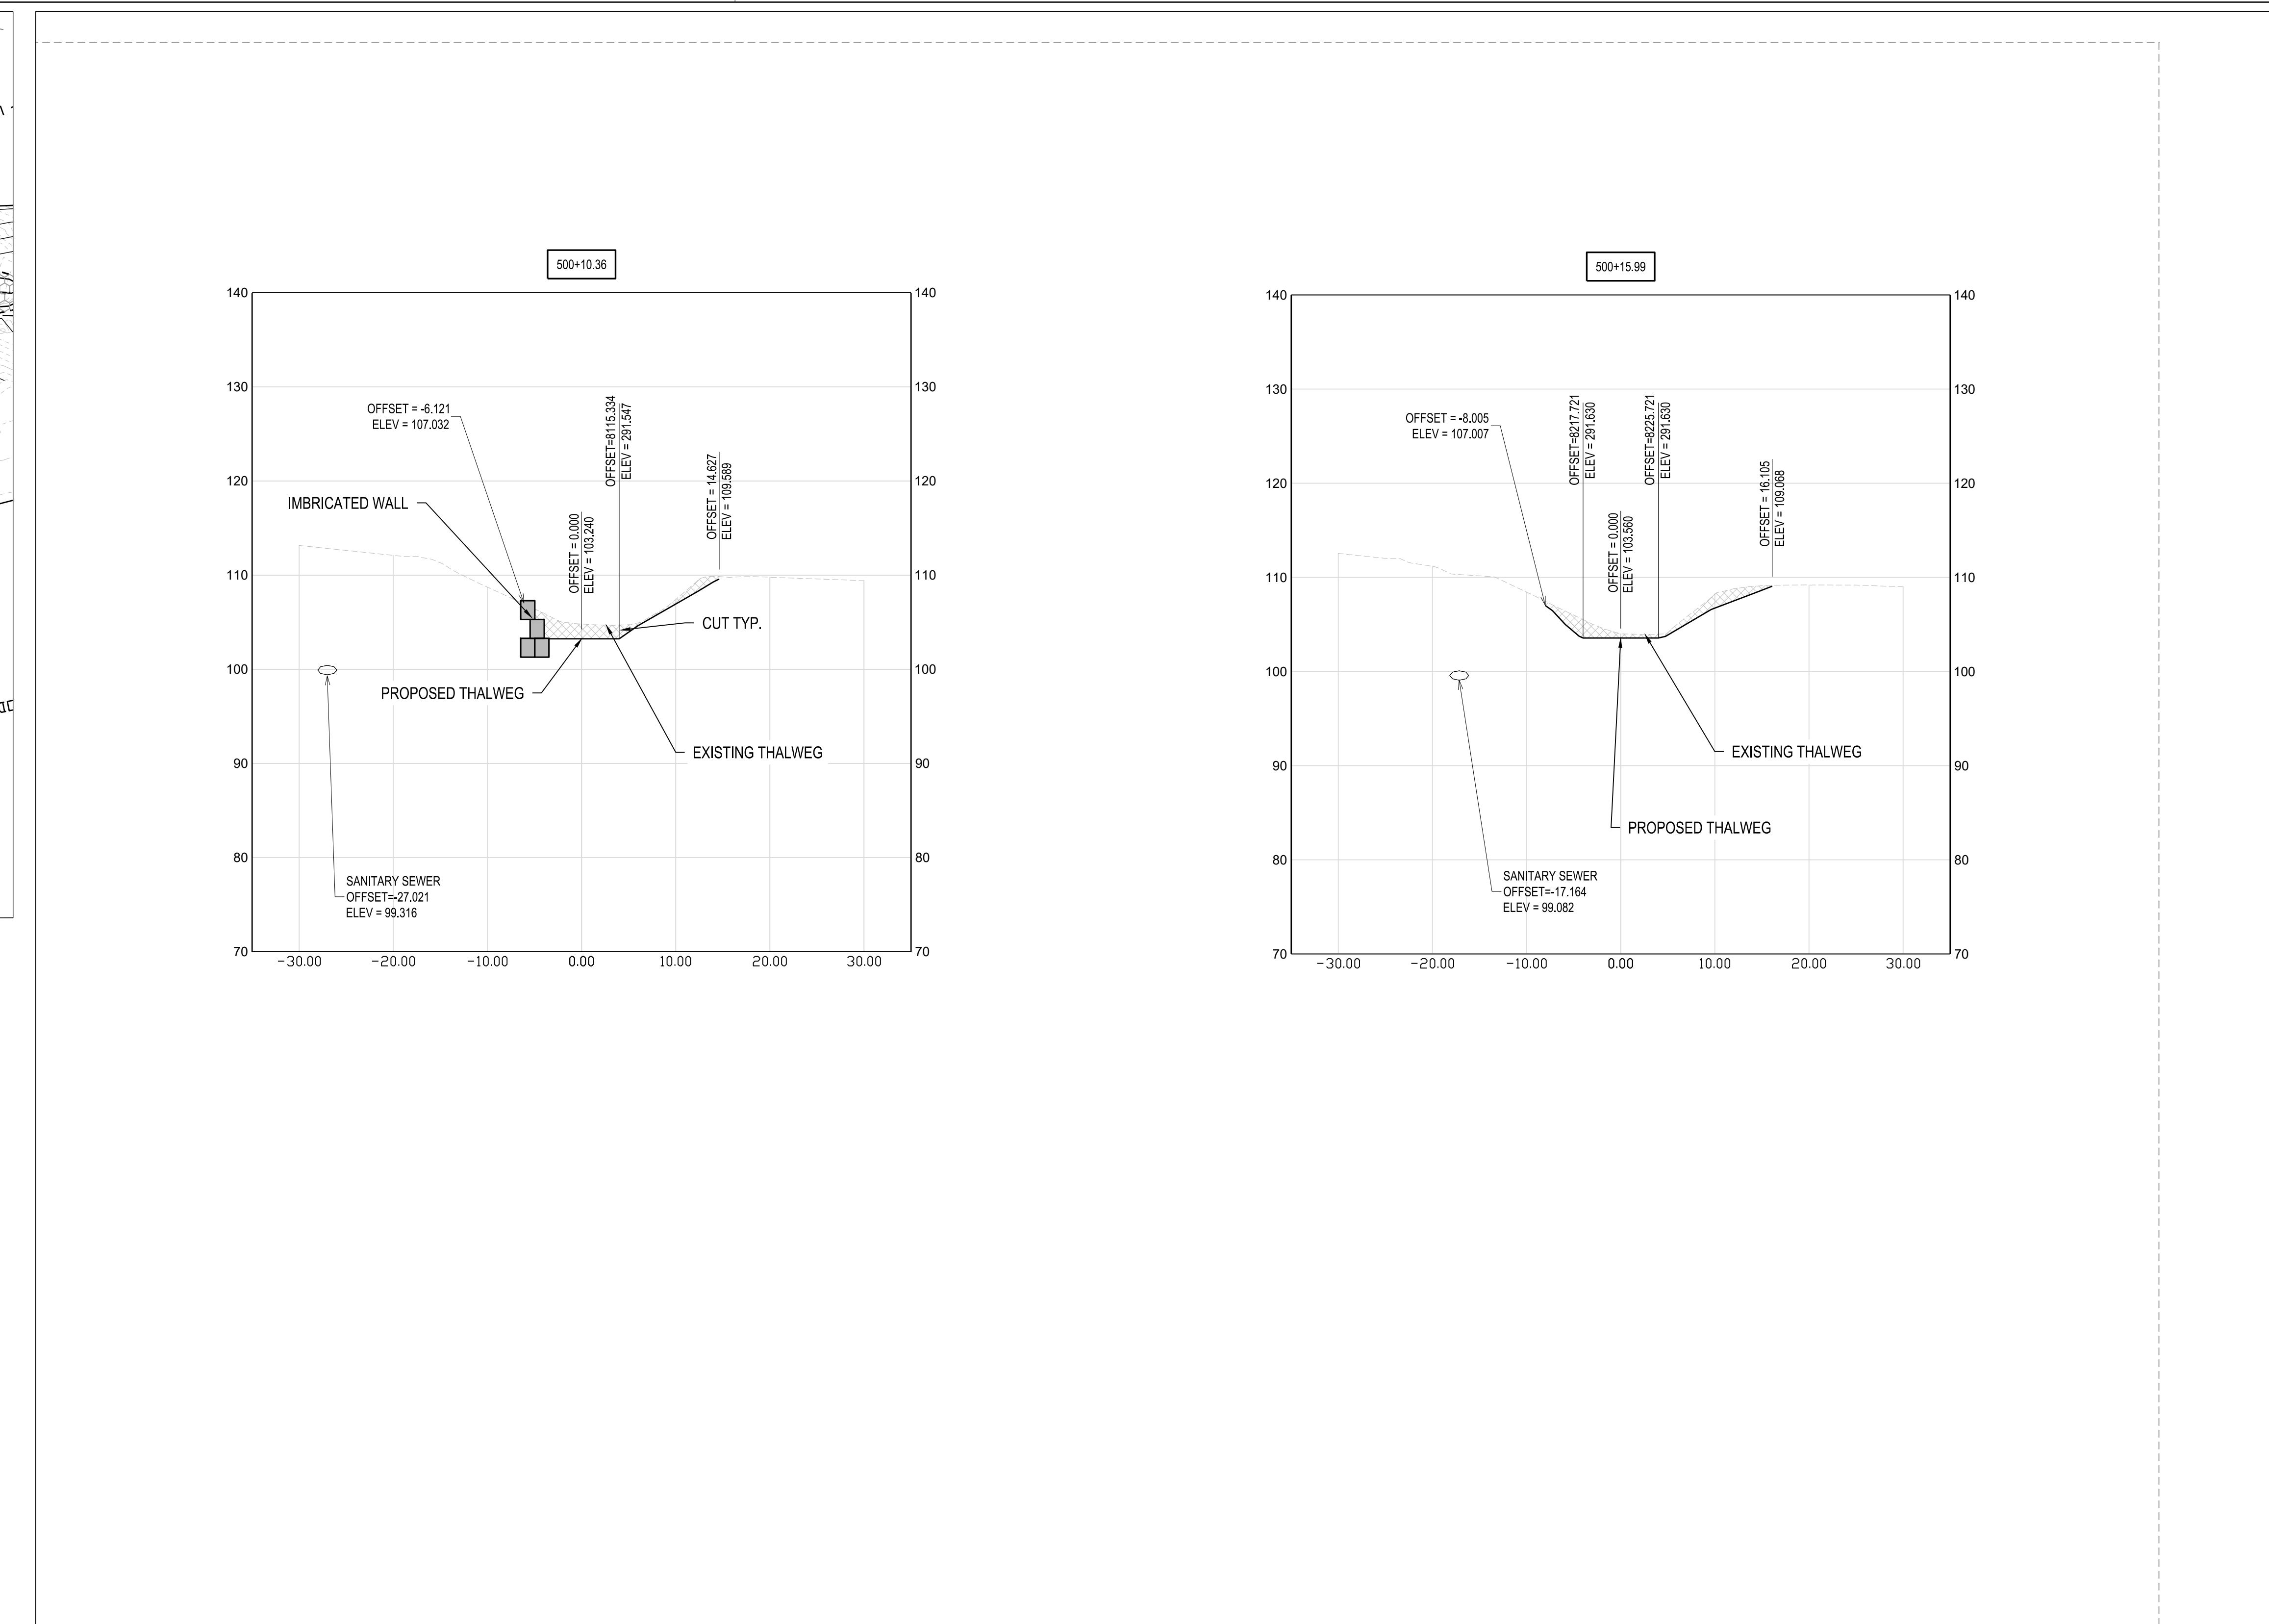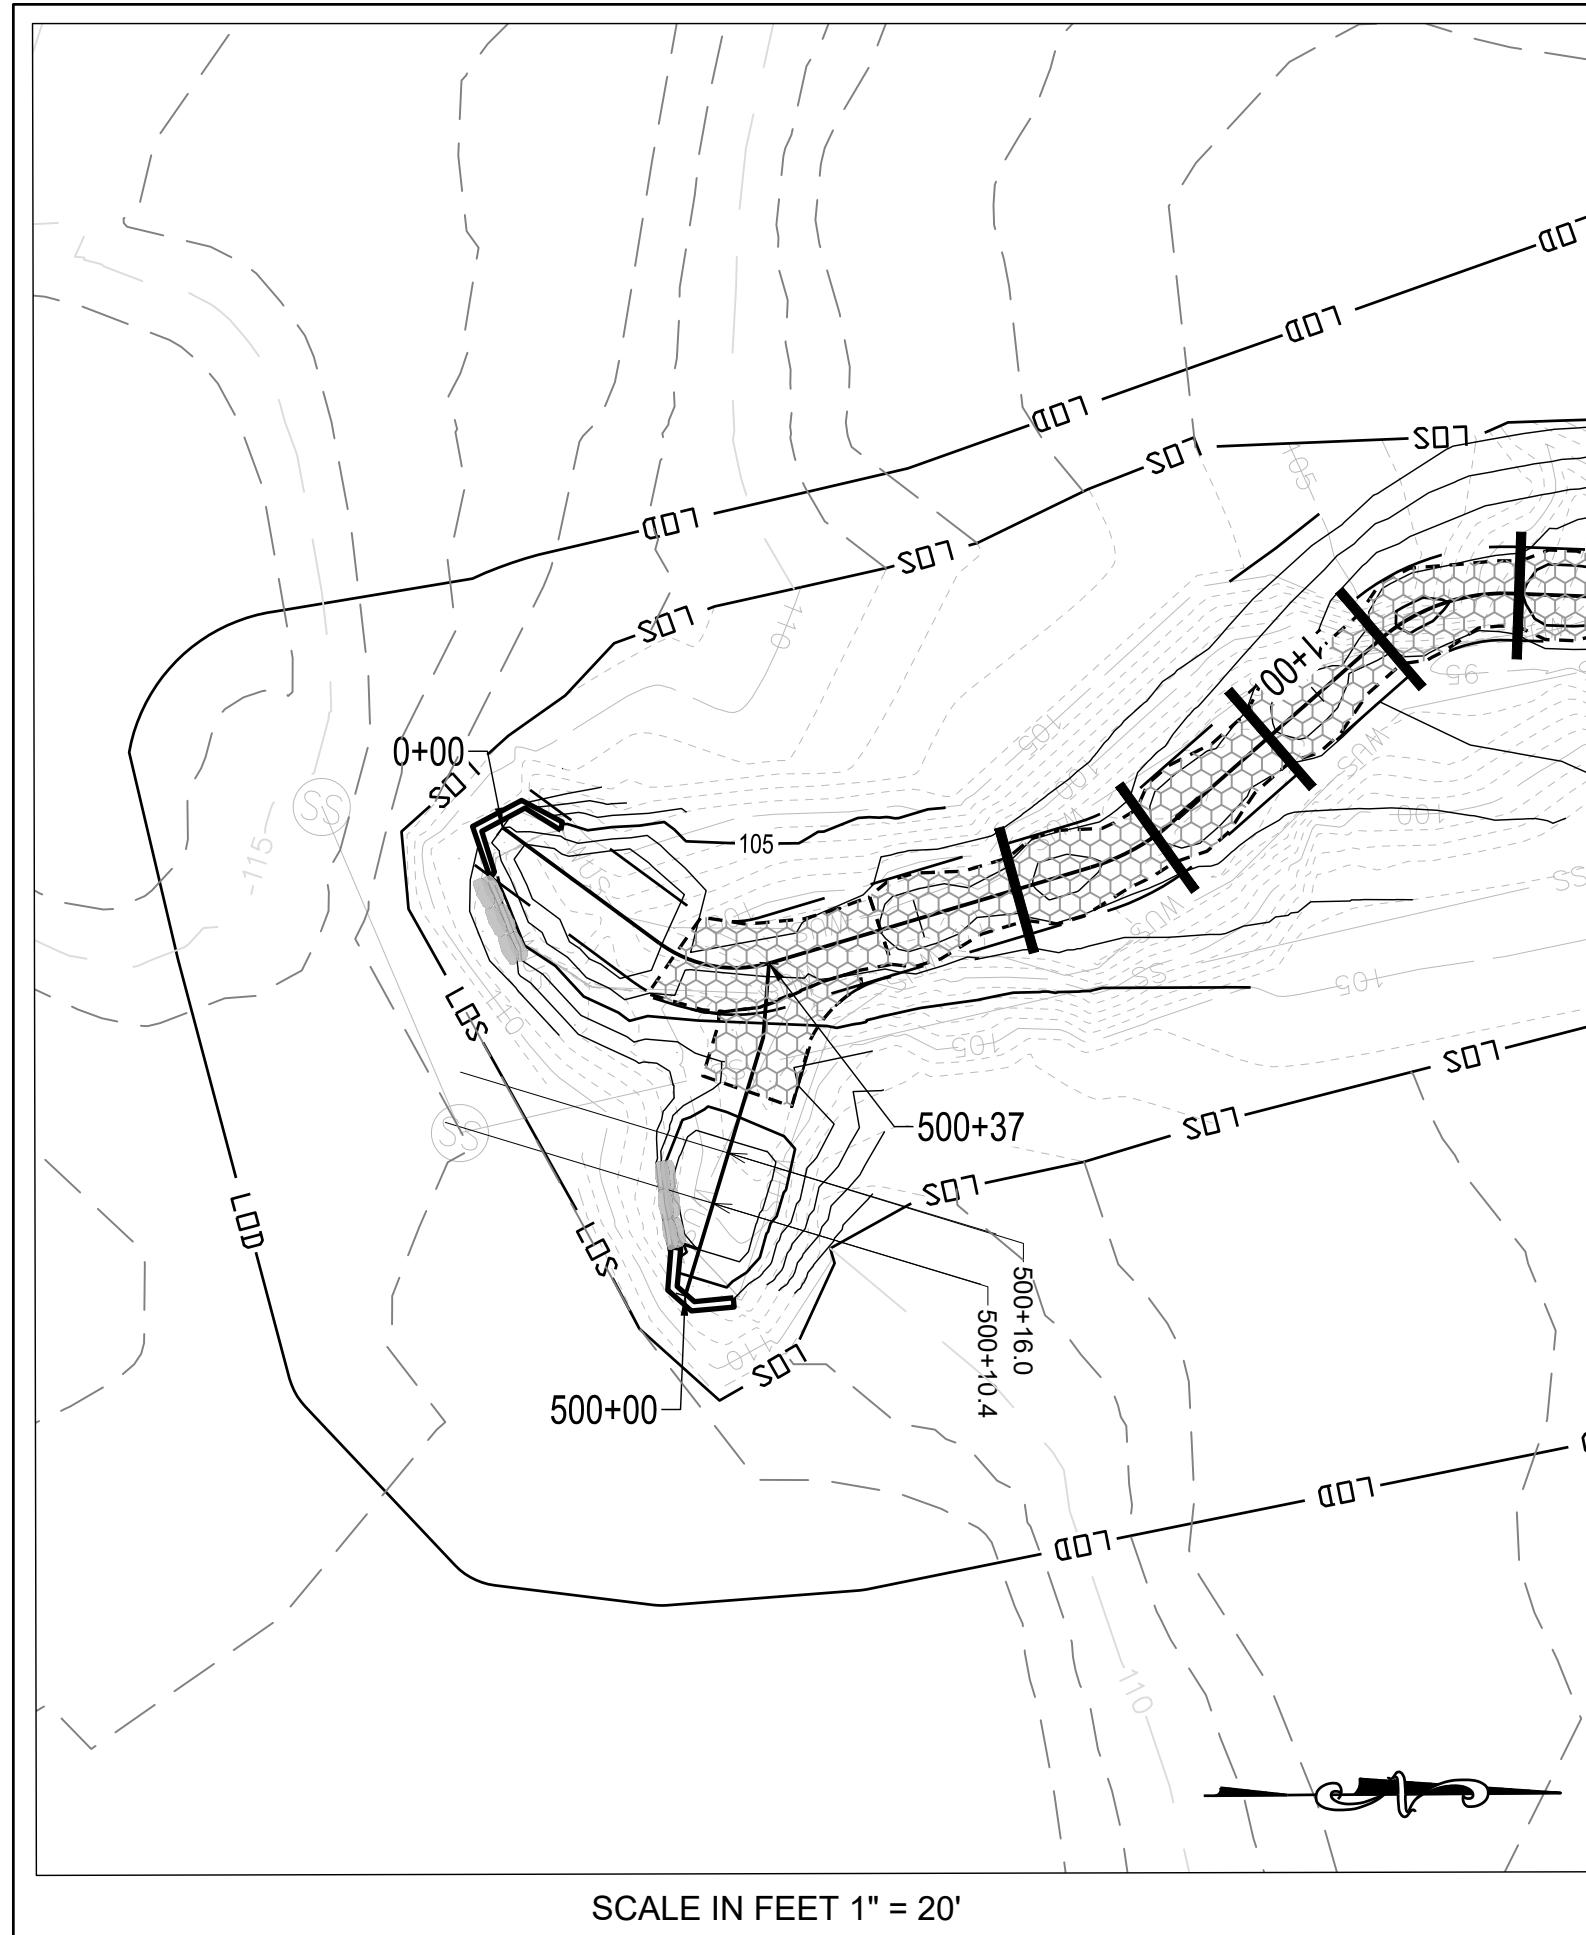

RT-1 SECTION VIEWS

SCALE: 1" = 10'

A horizontal scale with numerical markers at 0, 10, and 20. A black bar is positioned at the 20 mark. The scale is marked with a dashed pattern between 0 and 10, and a solid black line between 10 and 20.

SCALE IN FEET 1" = 100'

PROFESSIONAL CERTIFICATION

S/C

Table 1. Summary of the main characteristics of the four groups of patients.

HARFORD COUNTY, MARYLAND

EDGEGATER VILLAGE PARK STREAM RESTORATION SECTION VIEW

Drawn By : CA

Scales : AS SHOWN

Date : SEPTEMBER 2025


DATE: _____

Sheet No. 32 of 65




100

1000 J. POLYM. SCI.: PART A

1

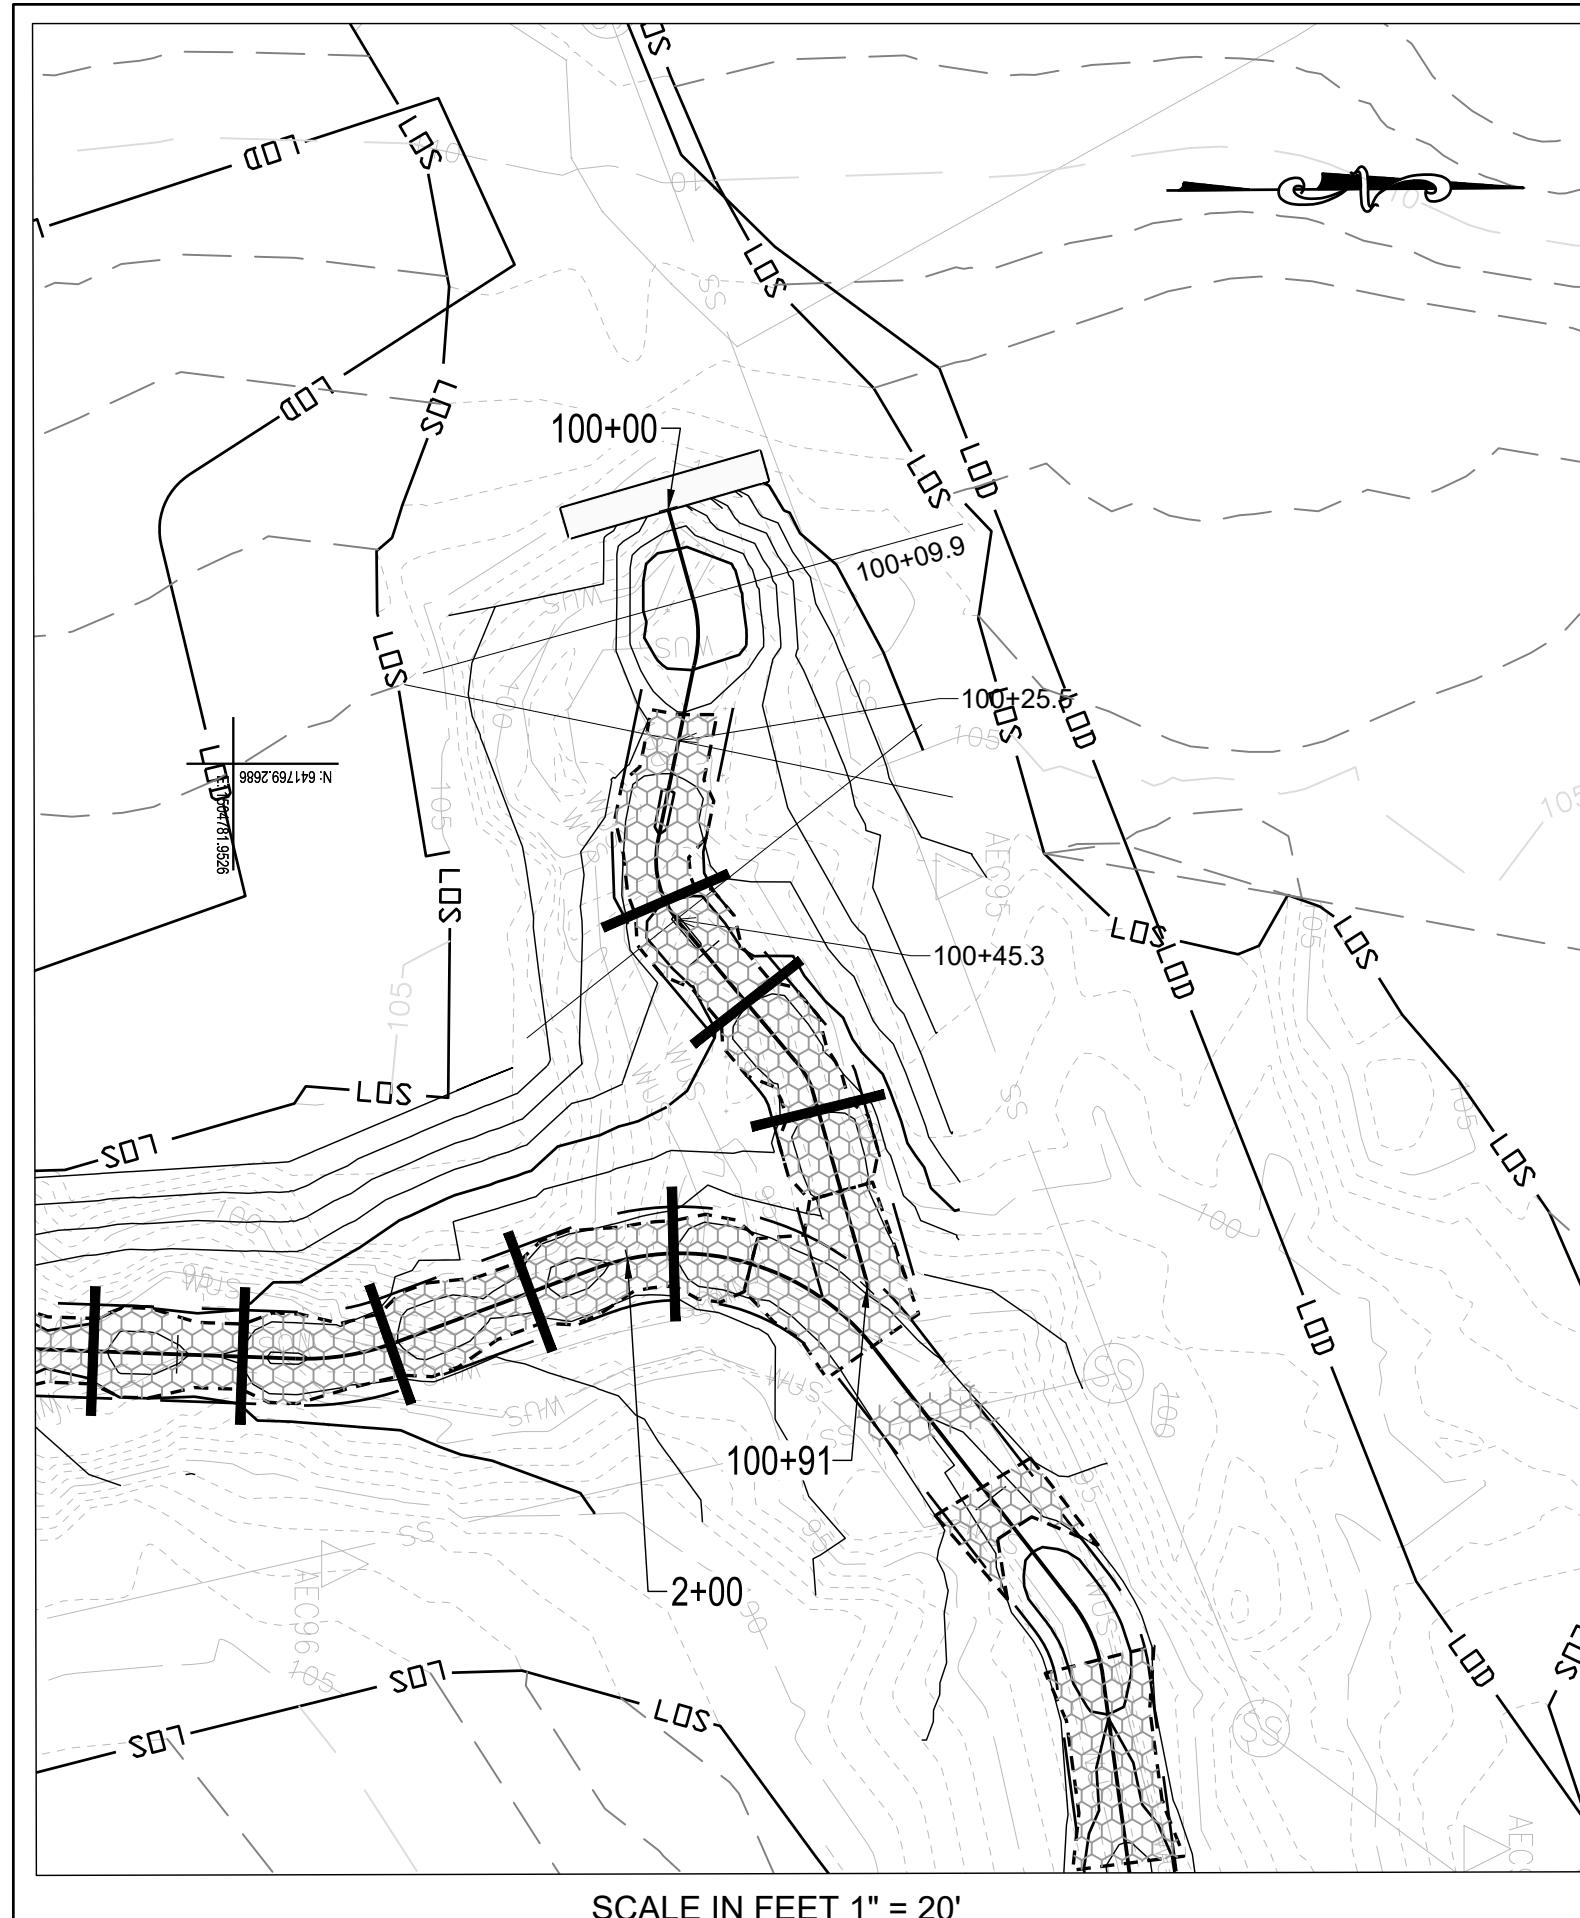

SCALE IN FEET 1" = 20'

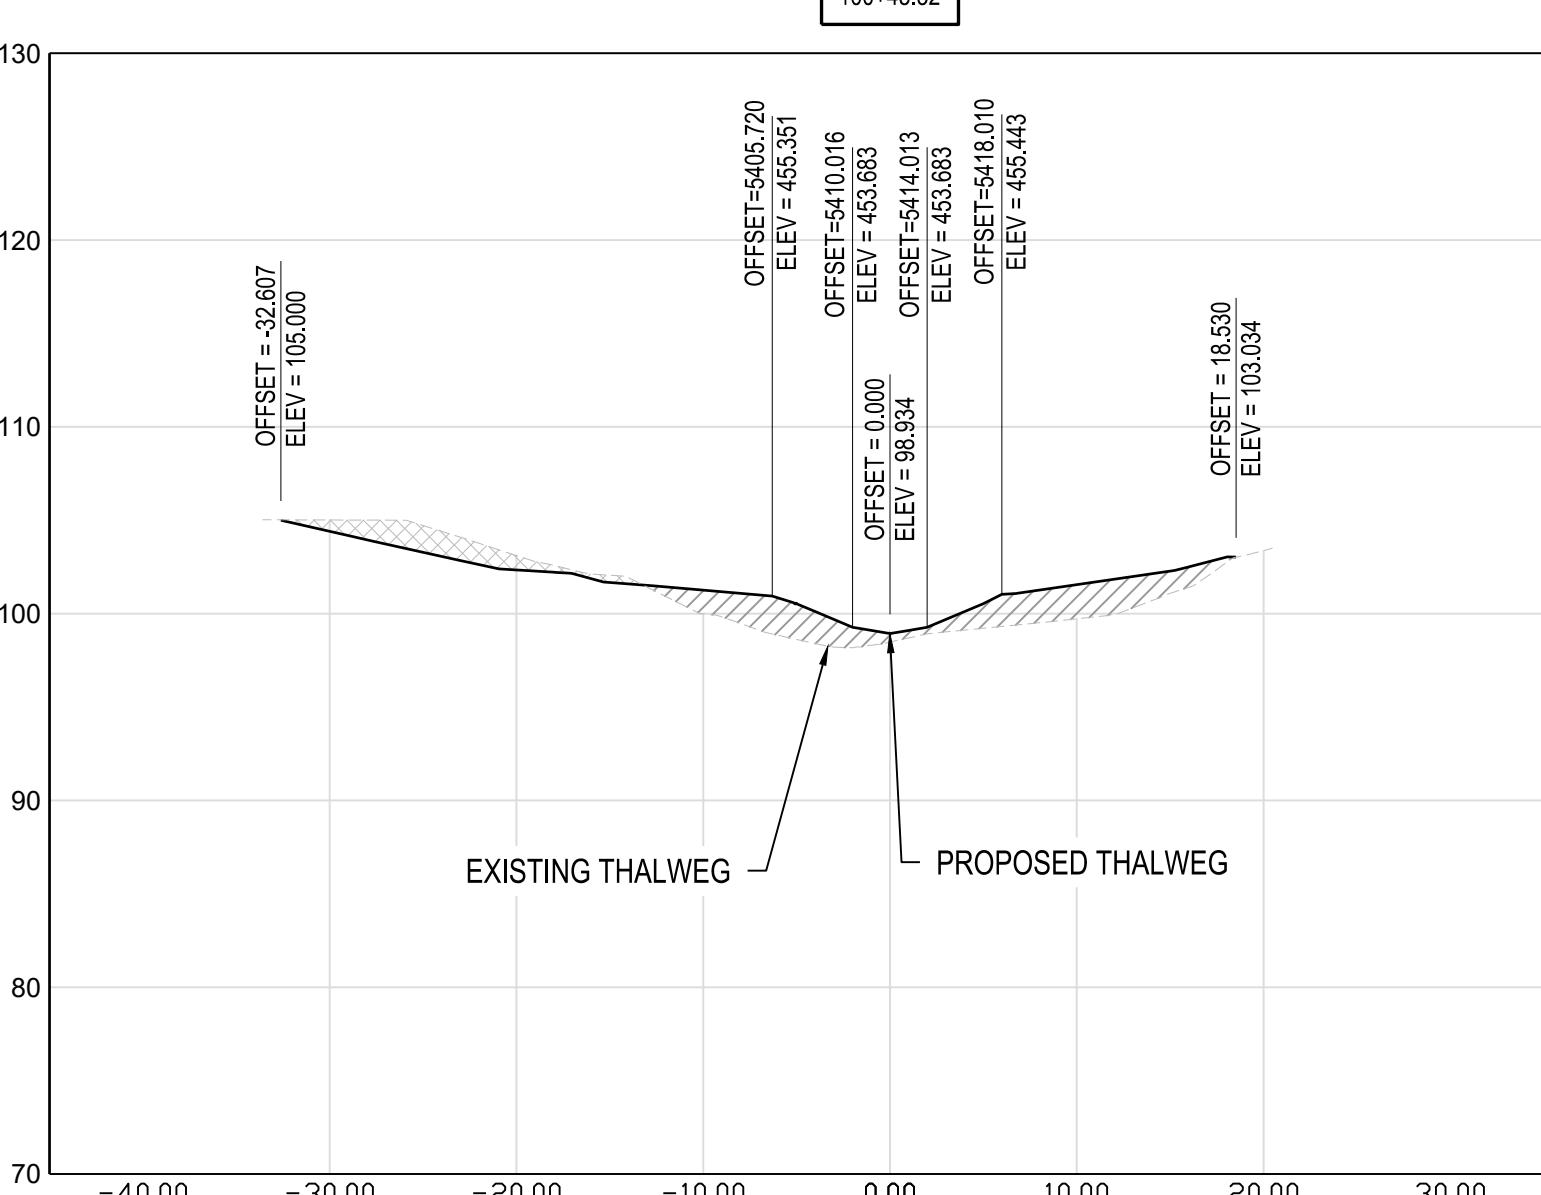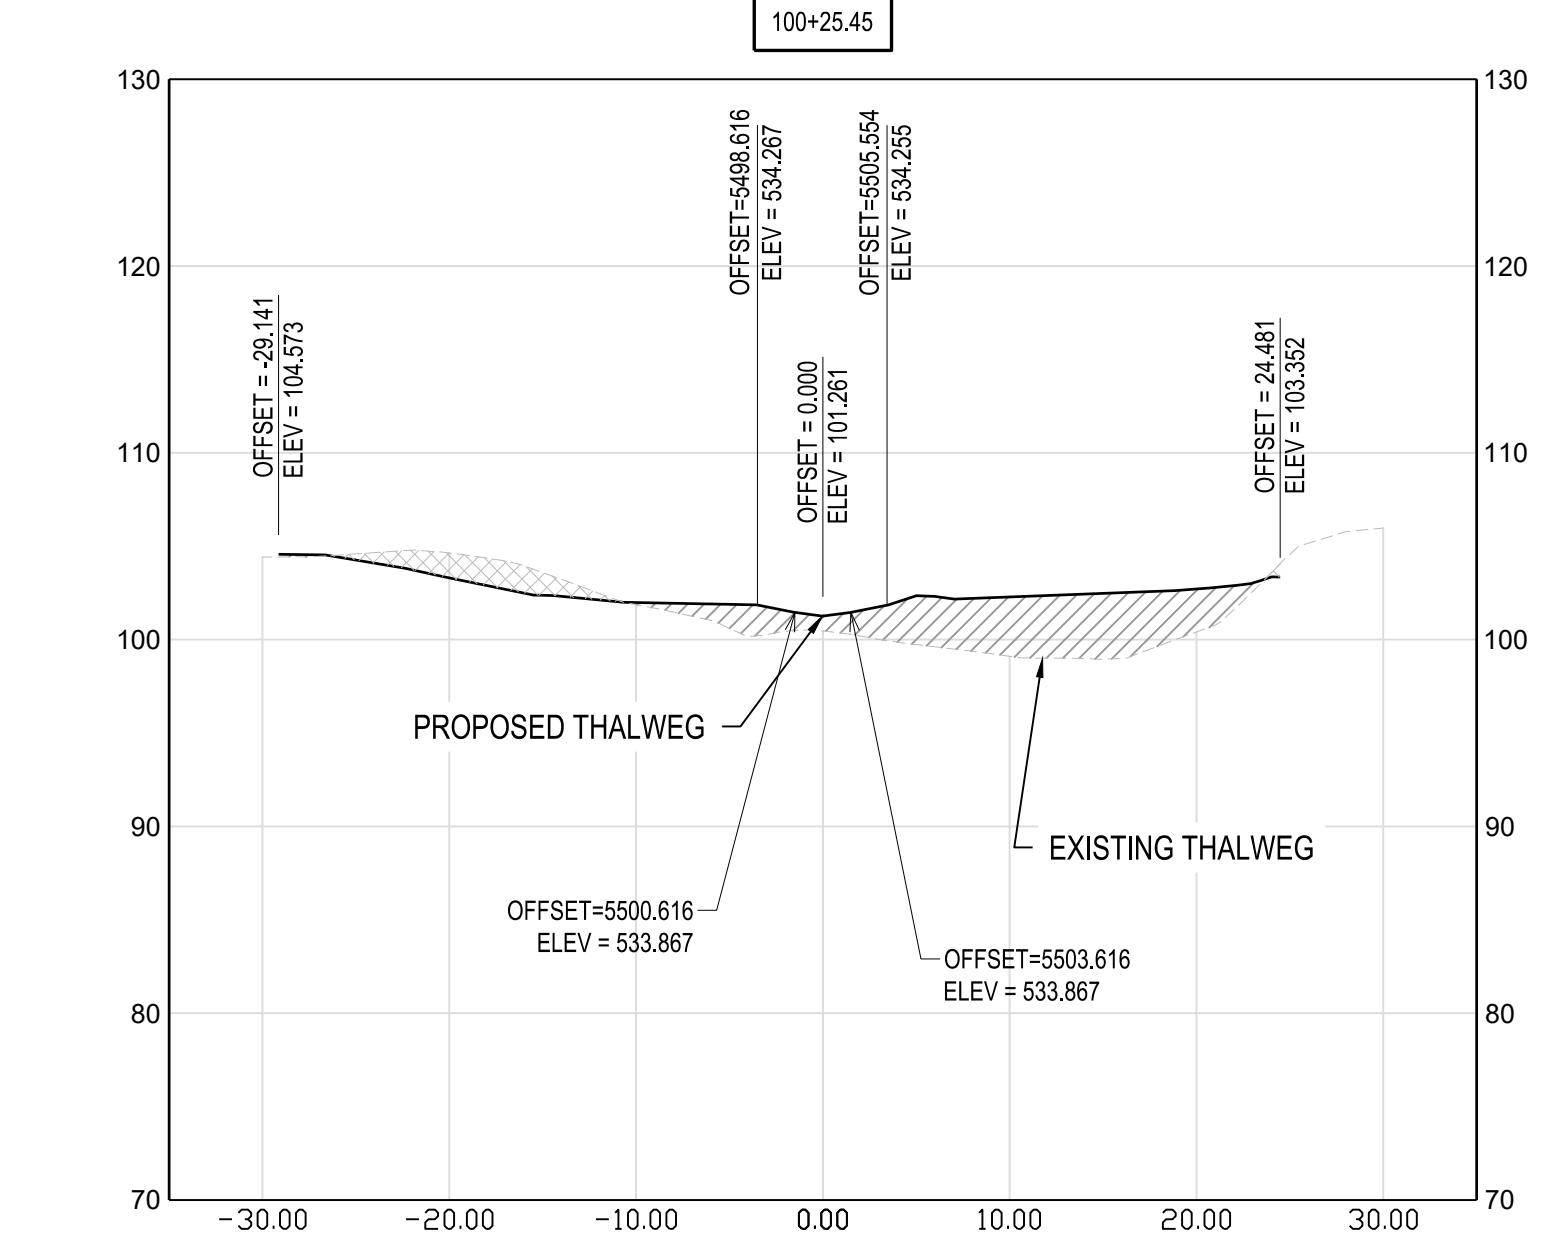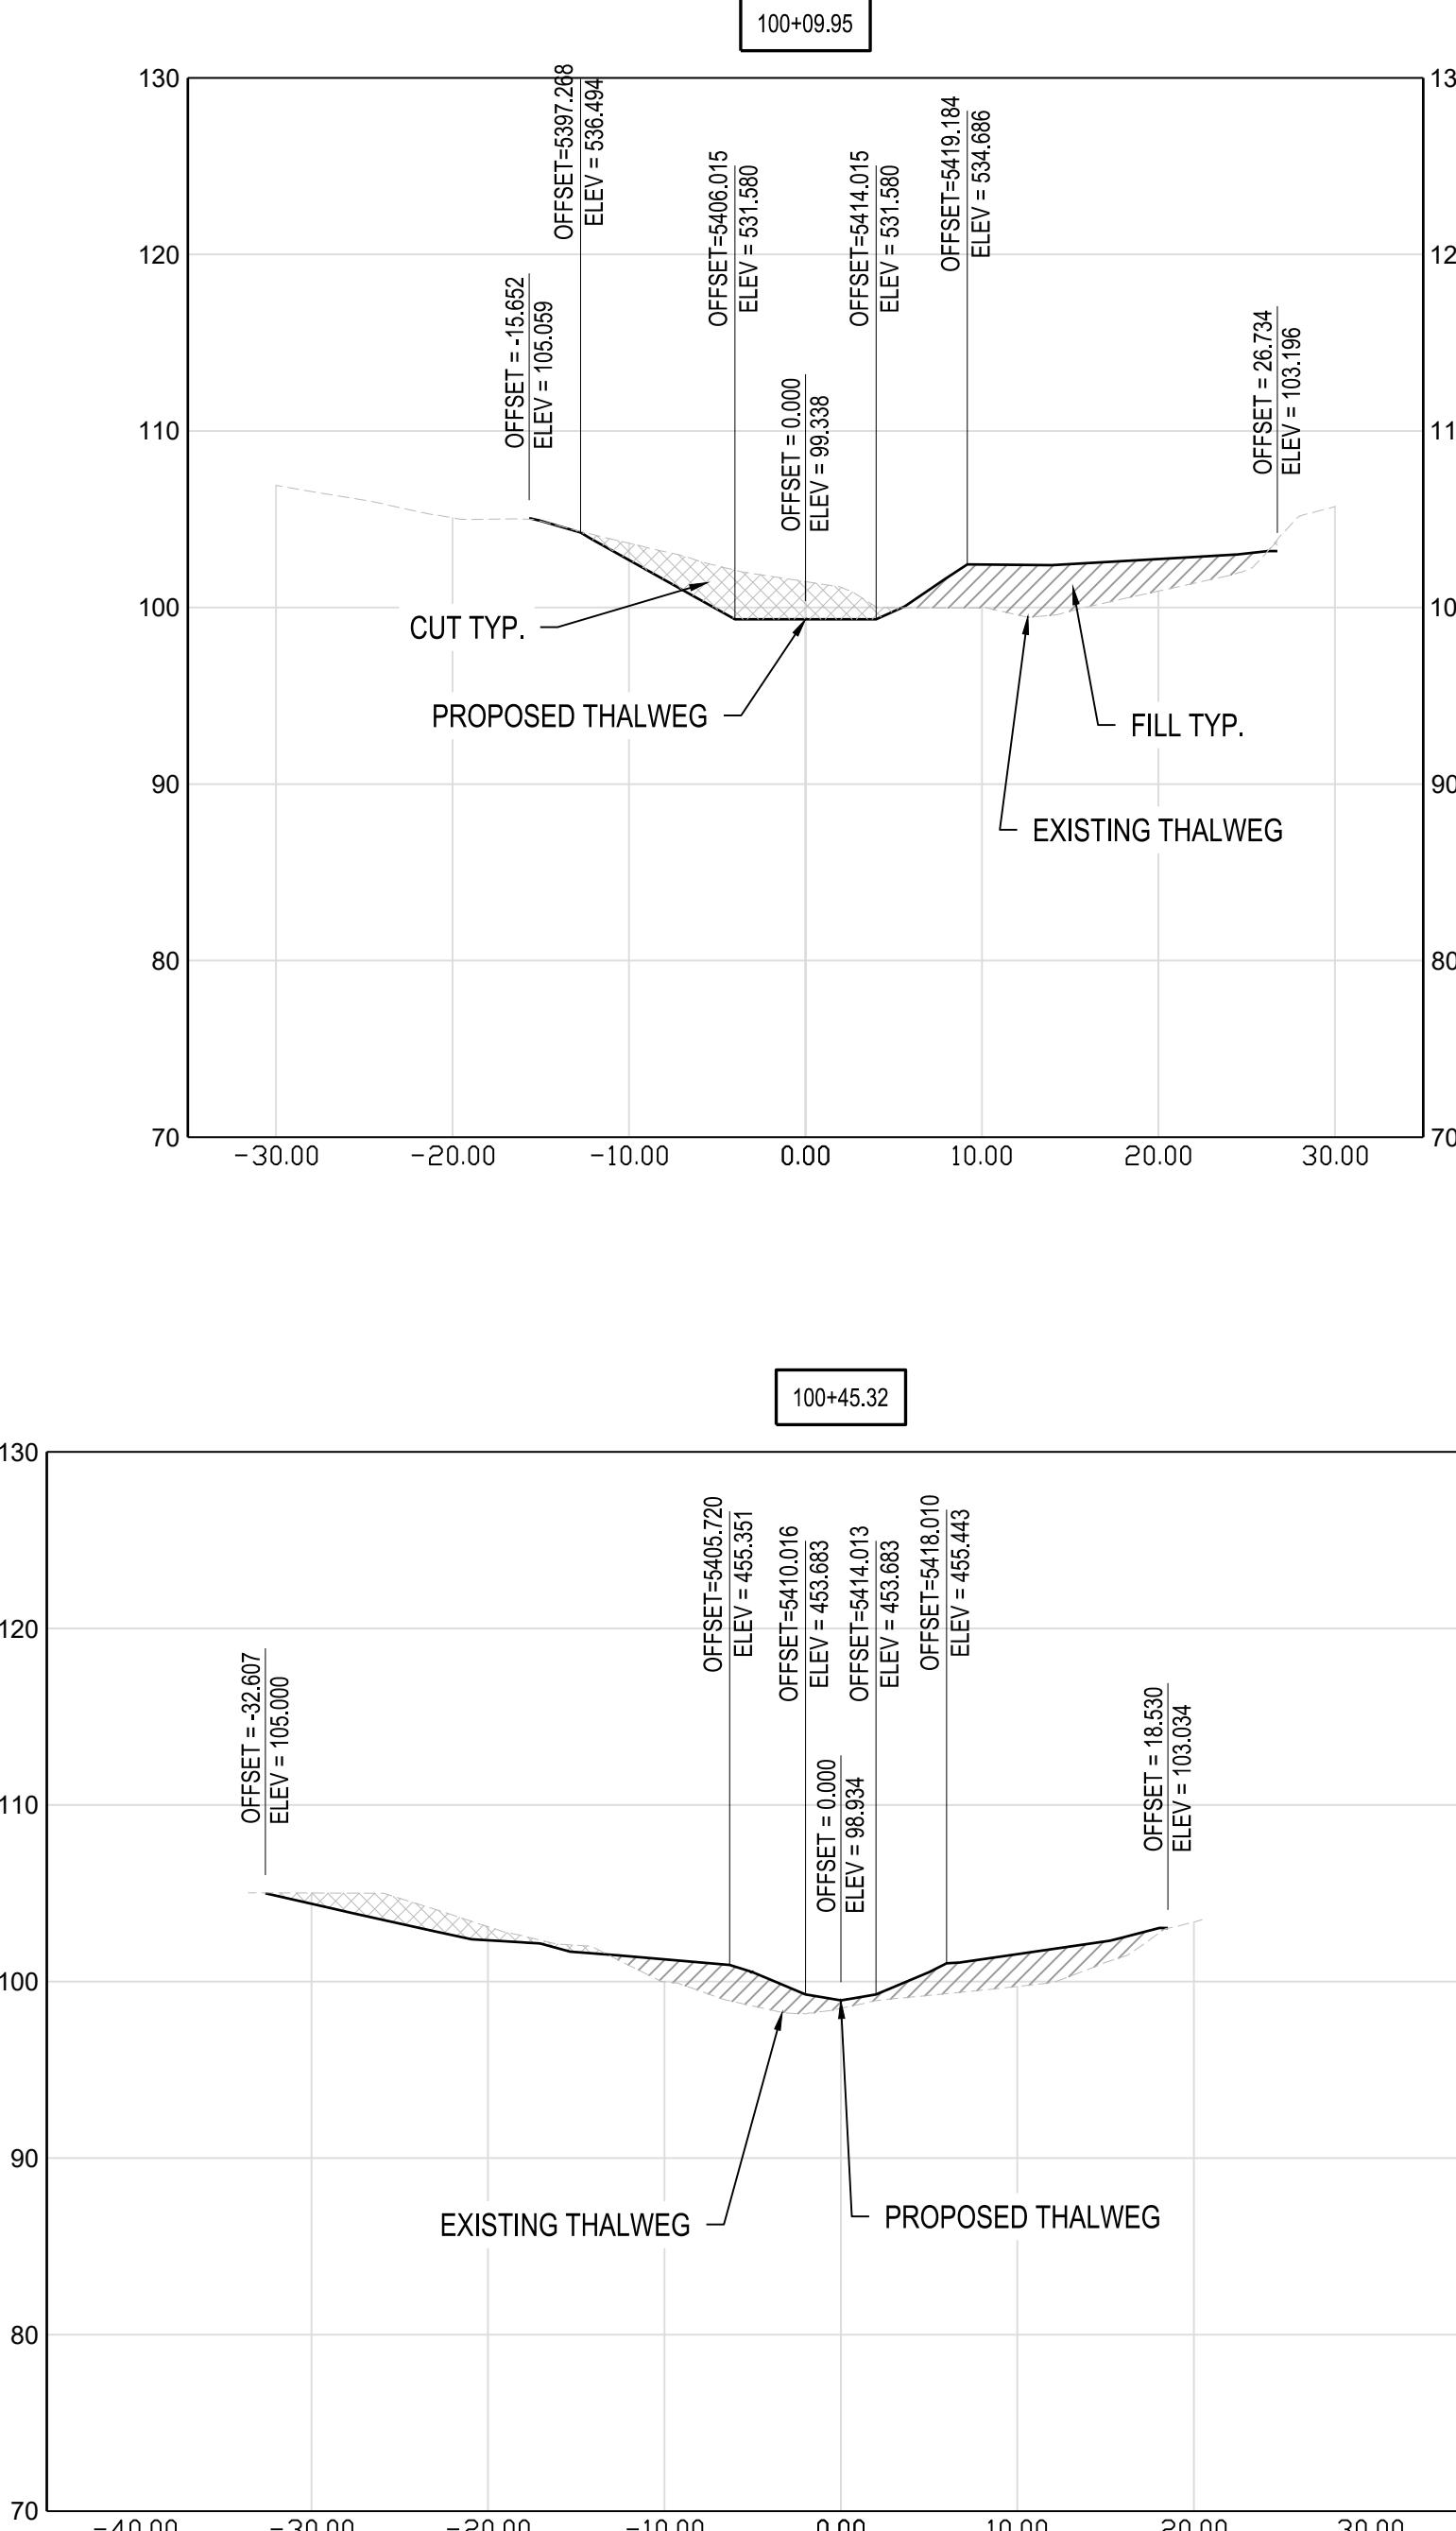

1 LT-1 SECTION VIEWS

SCALE: 1" = 10'



SCALE IN FEET 1" = 10'

PROFESSIONAL CERTIFICATION

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THE STATE OF MARYLAND. LICENSE NO. XXXXX, EXPIRATION DATE: XX/XX/XXXX.

S/C PLAN # 59914



GRA-004622-2025

Revisions

SIGN AND SEAL

HARFORD COUNTY, MARYLAND
EDGEWATER VILLAGE PARK
STREAM RESTORATION
SECTION VIEW

AS SHOWN
Scale : SEPTEMBER 2025
Drawing No. SE-09 of SE-03
Sheet No. 33 of 65

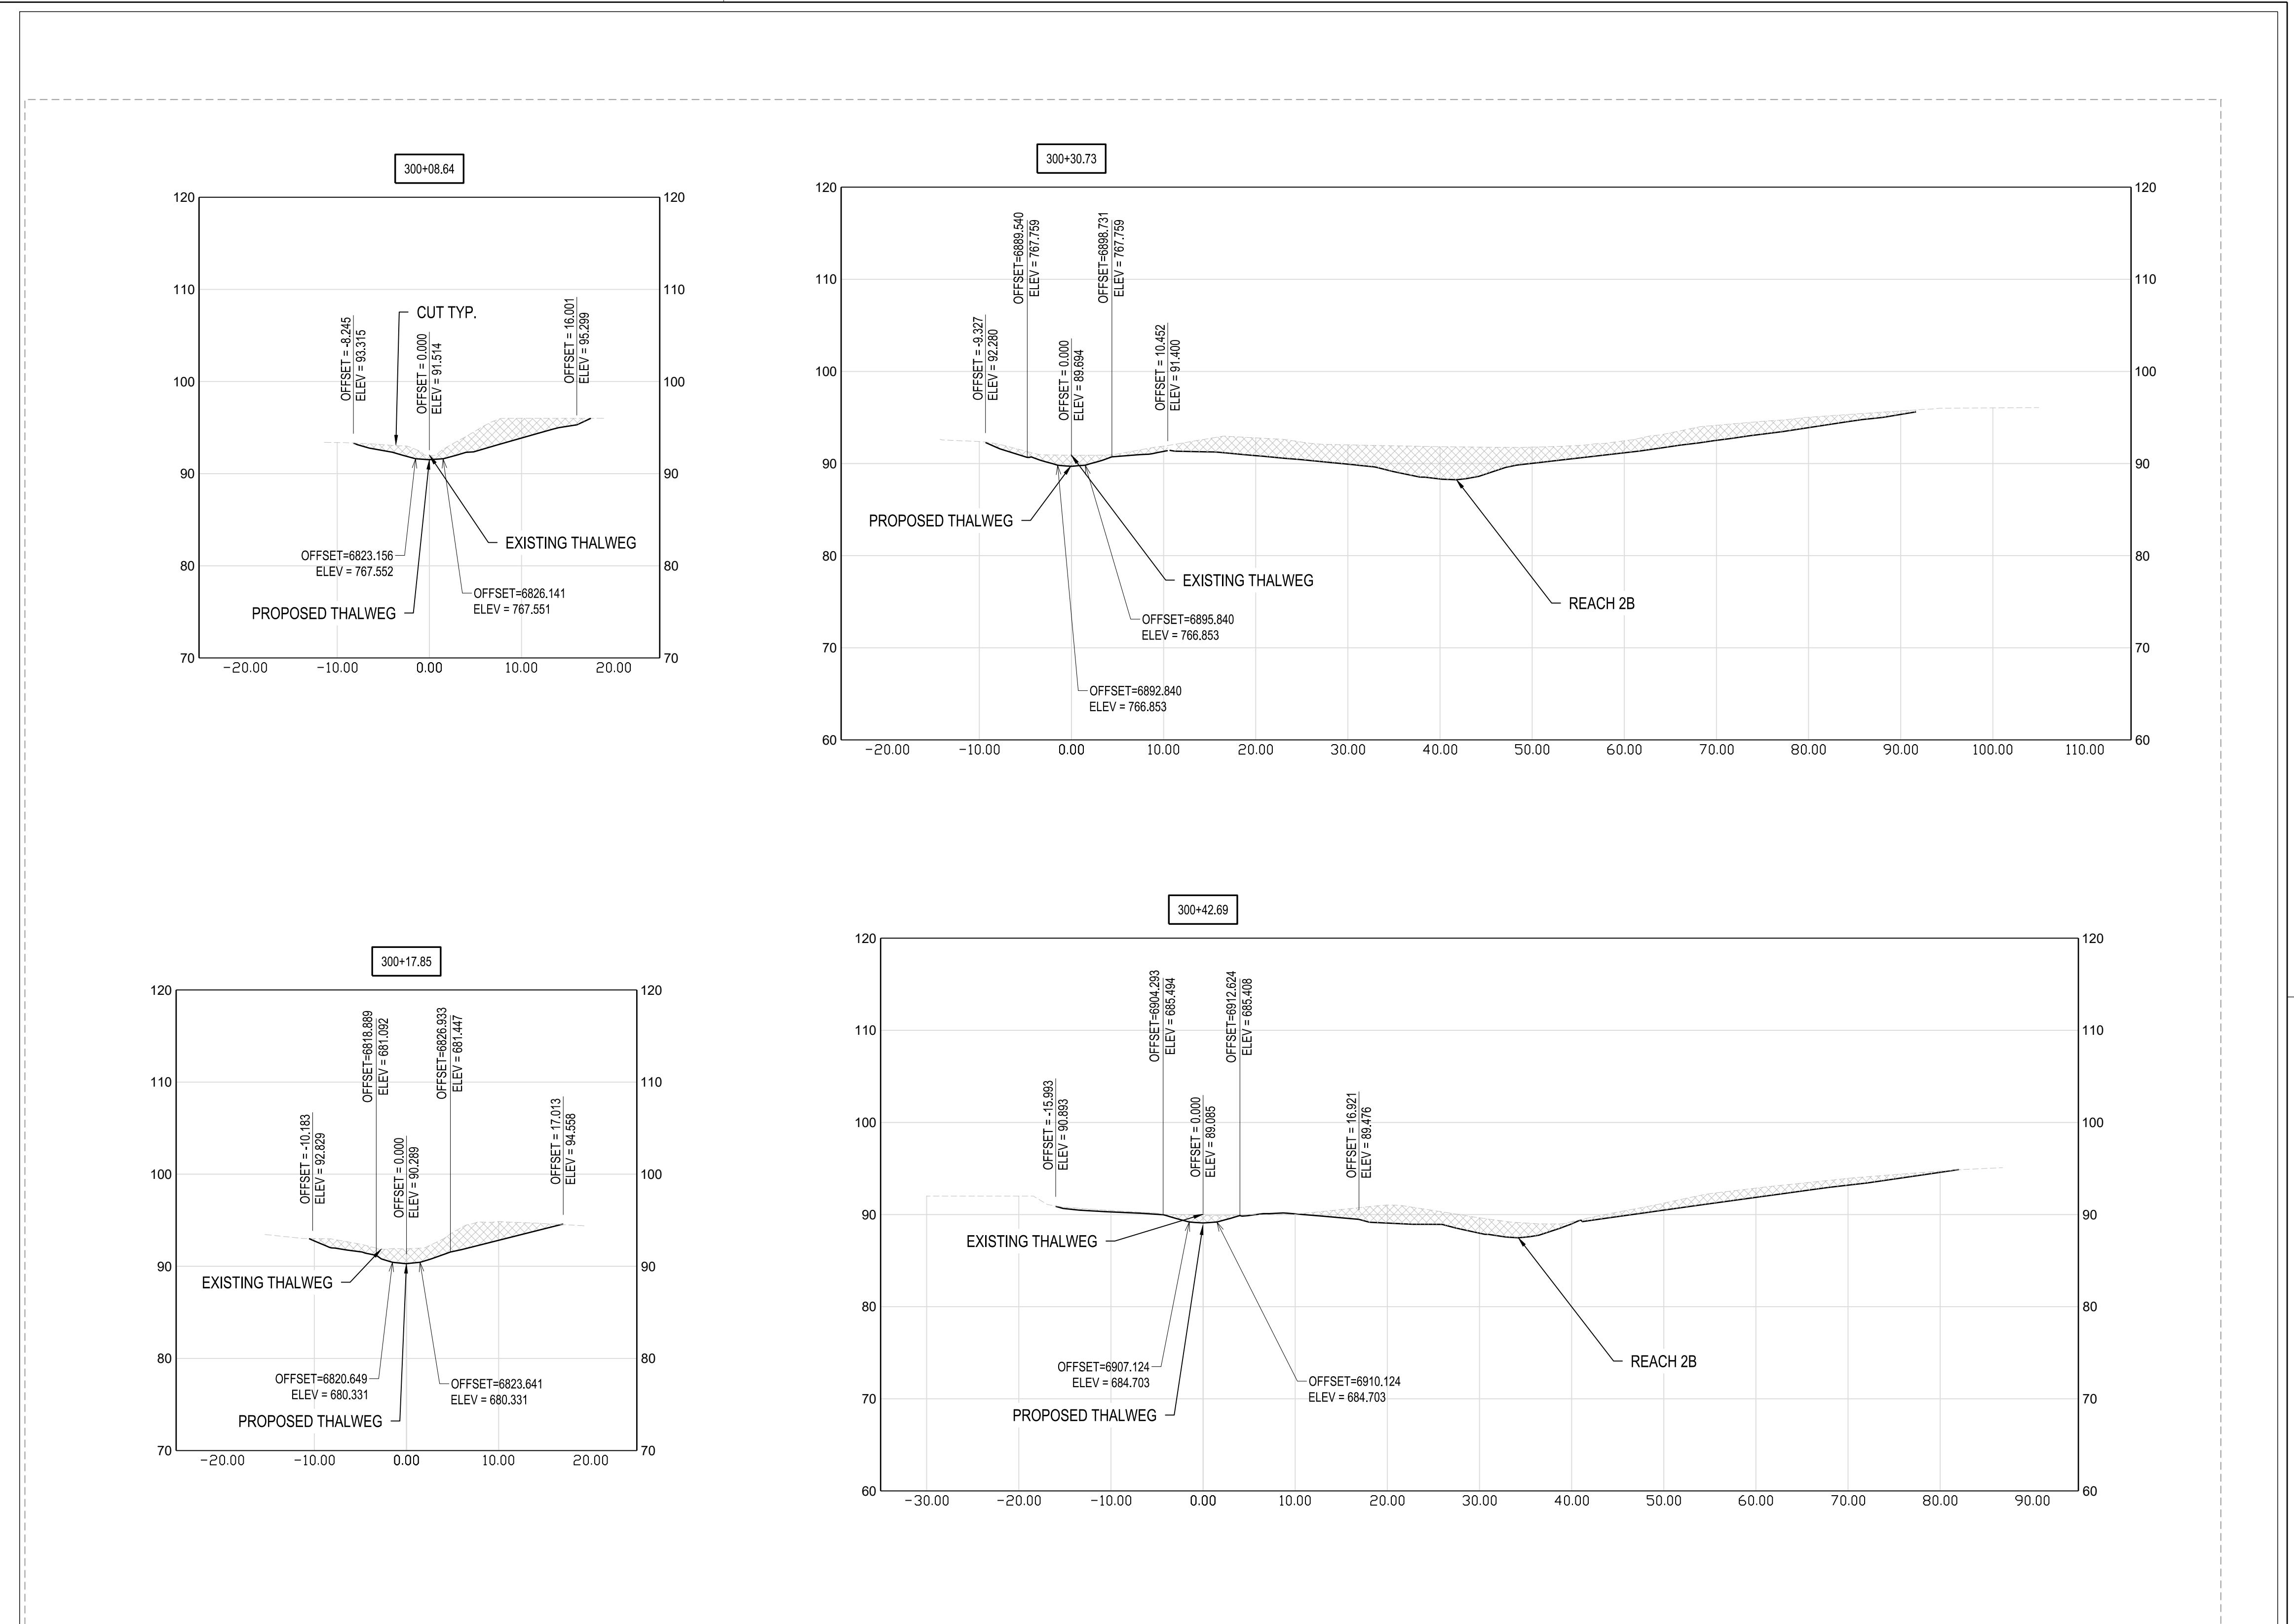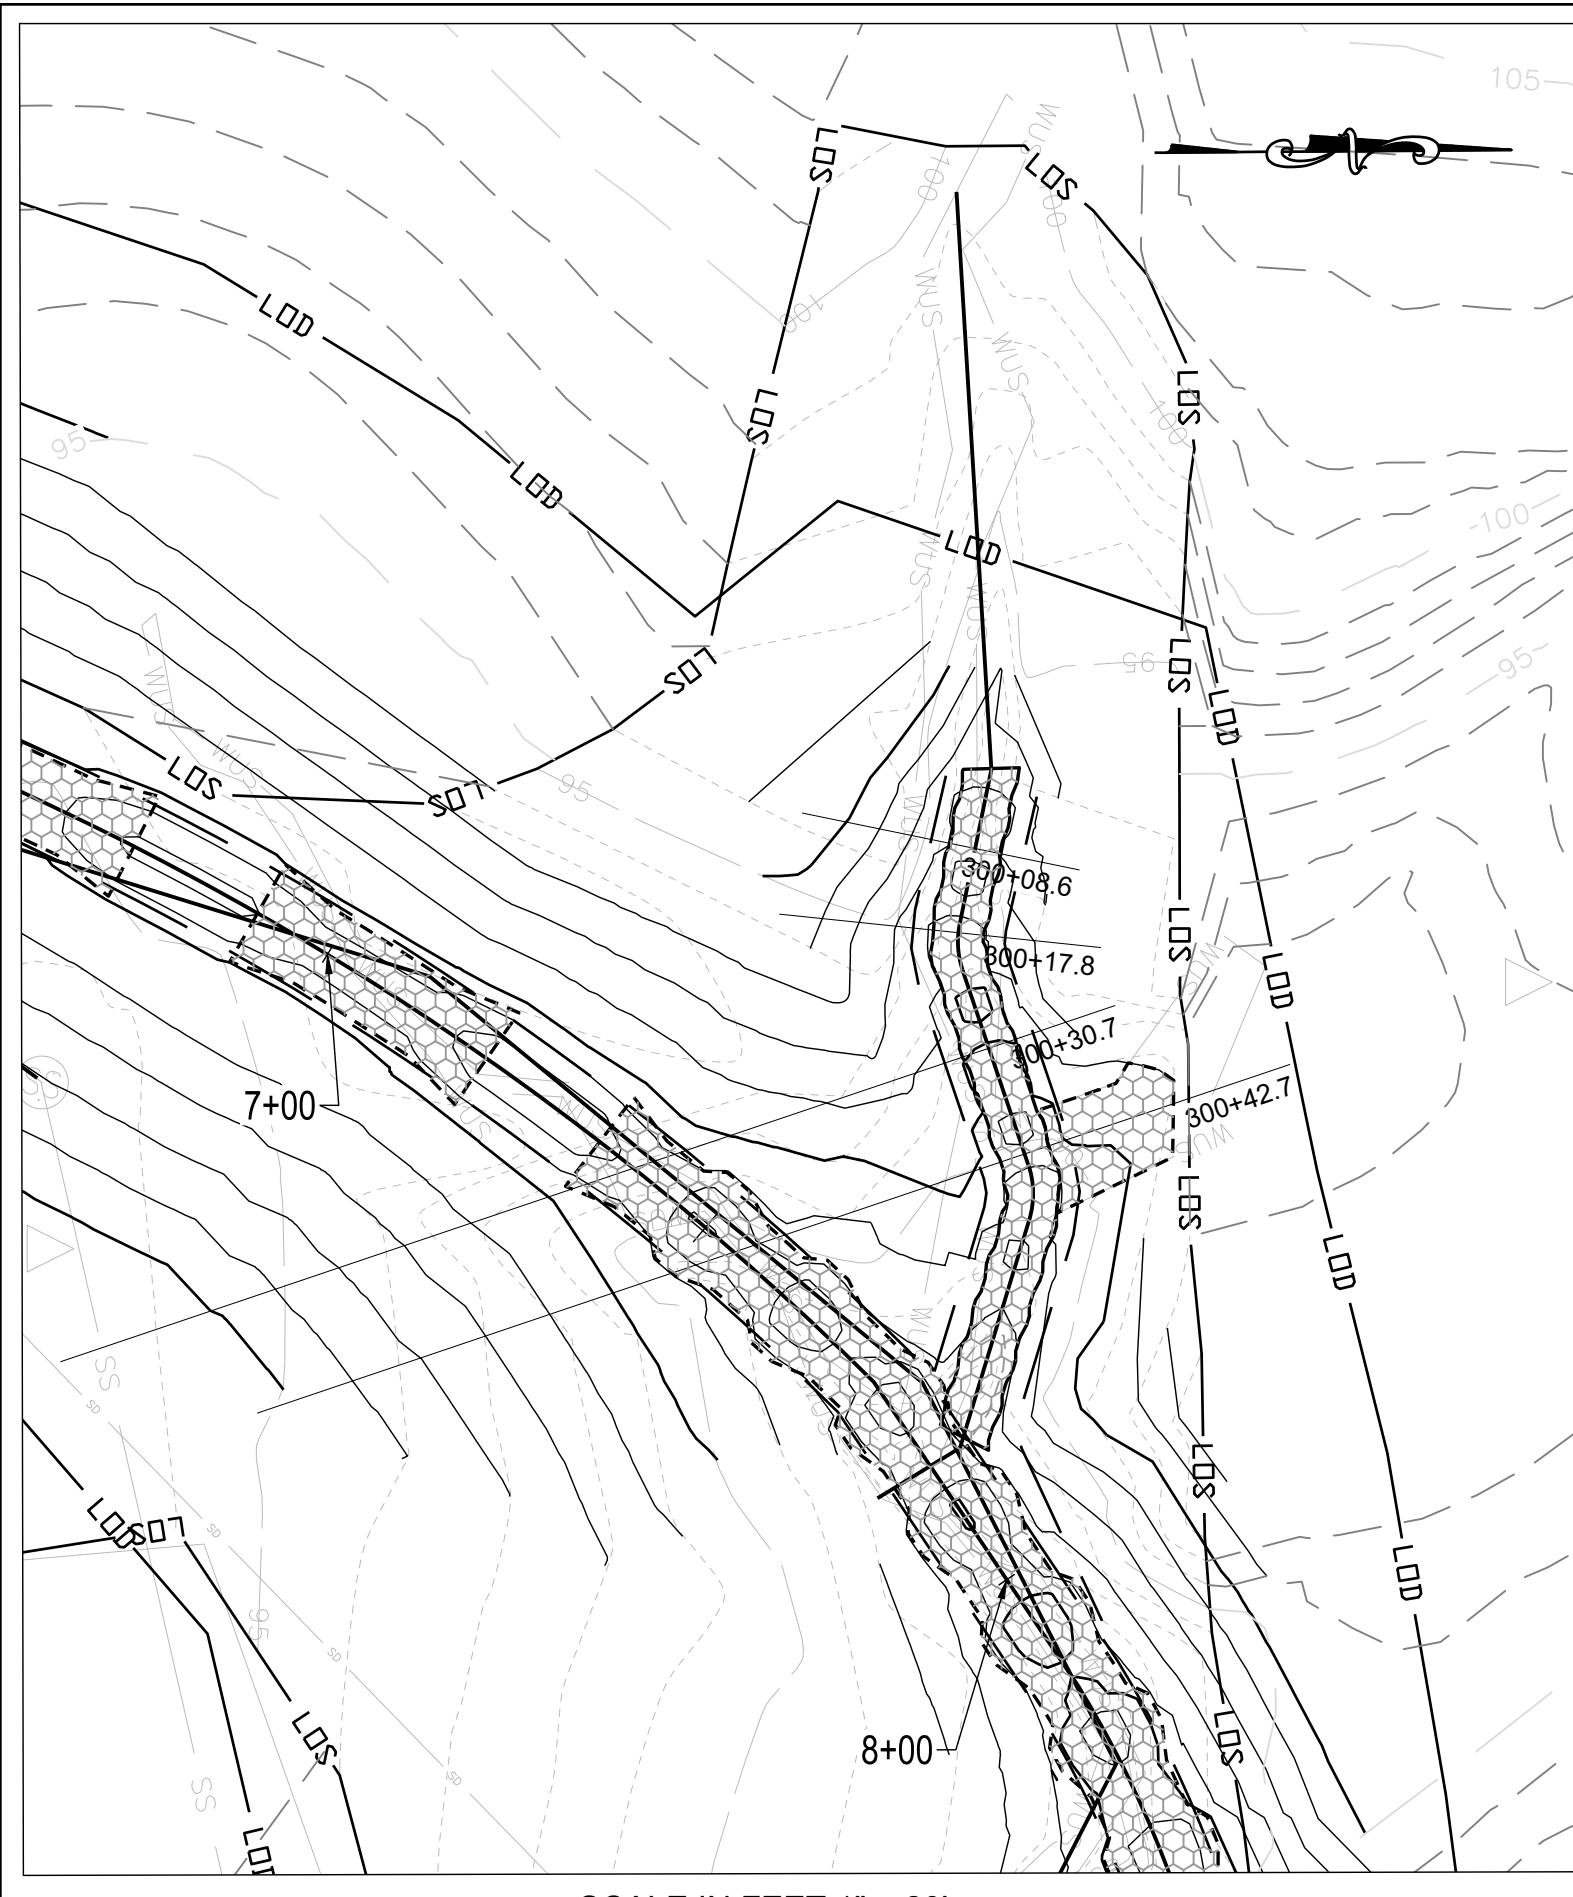


1 LT-2 SECTION VIEWS

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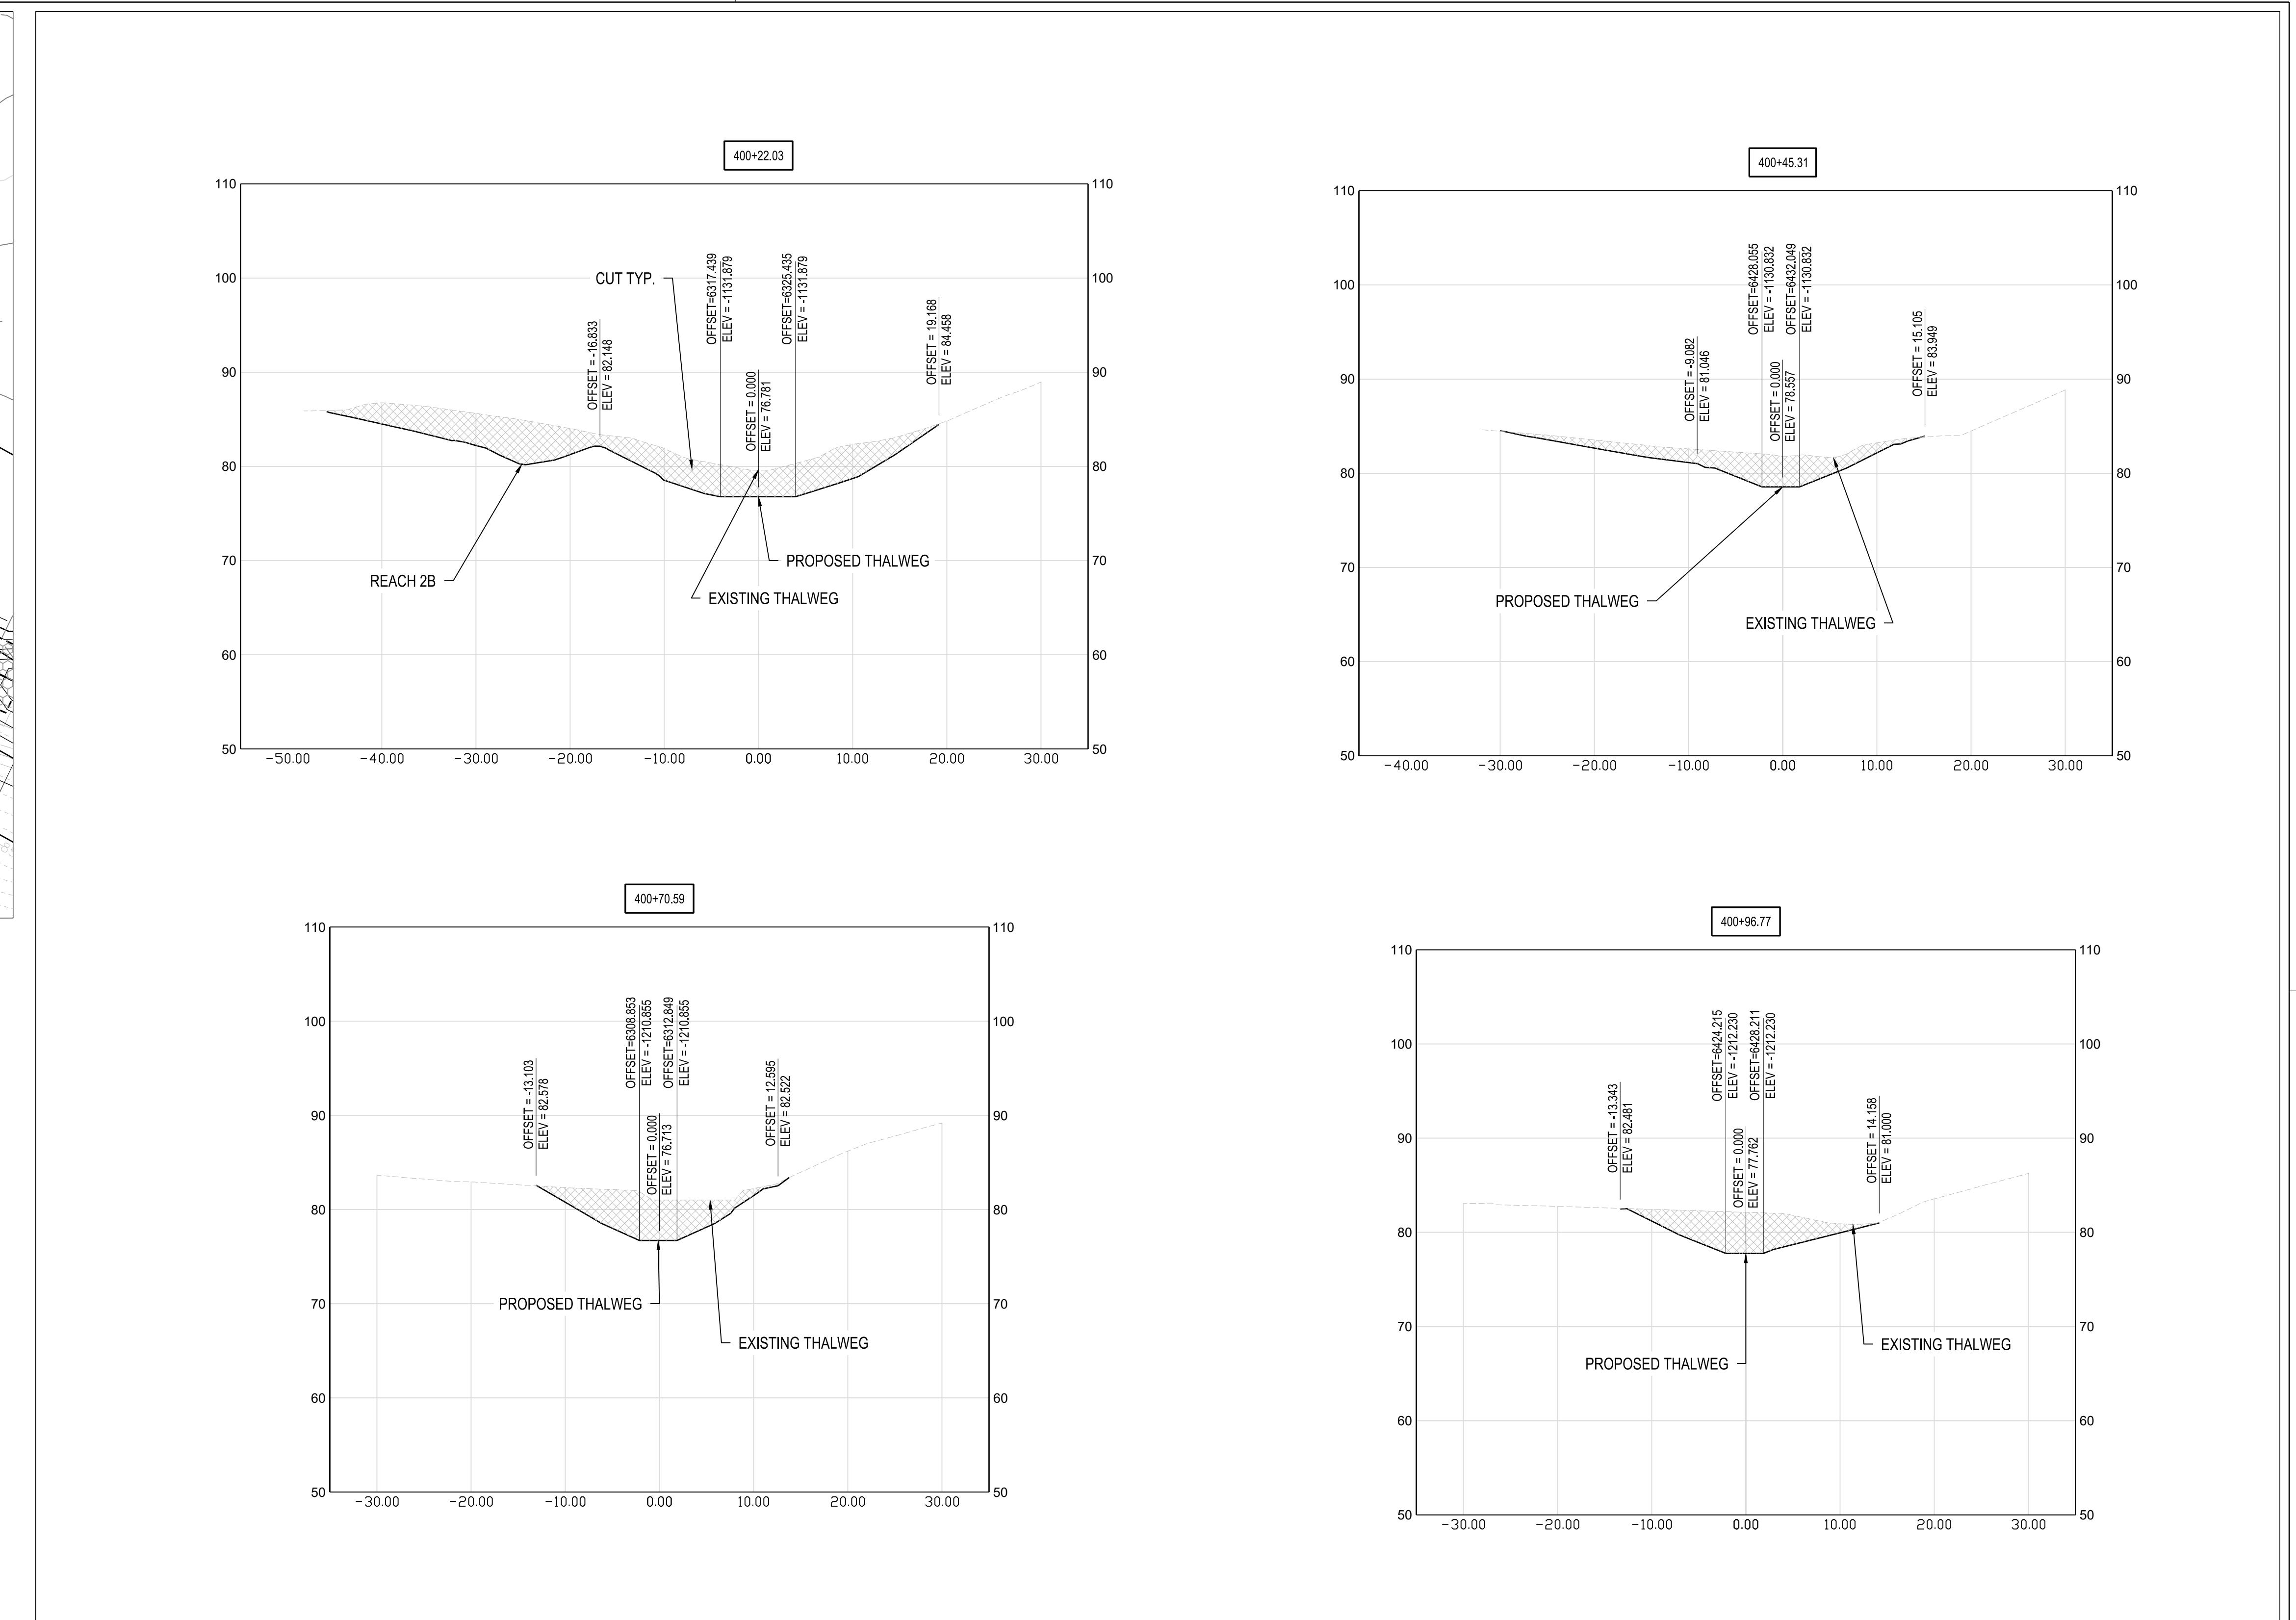
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SCALE IN FEET 1" = 10'

S/C PLAN # 59914	Revisions	HARFORD COUNTY, MARYLAND			
GRA-004622-2025	EDGEWATER VILLAGE PARK		AS SHOWN		
STREAM RESTORATION					
SECTION VIEWS					
Drawn By : CA	Scale : 1 inch	September 2025	Date :		
Designed By : CA					
Reviewed By : BWA					
Drawing No. SE-10 of SE-12	Sheet No.	34 of 65			
PROFESSIONAL CERTIFICATION					
I HEREBY CERTIFY THAT THESE DOCUMENTS WERE PREPARED OR APPROVED BY ME, AND THAT I AM A DULY LICENSED PROFESSIONAL ENGINEER UNDER THE LAWS OF THE STATE OF MARYLAND LICENSE NO. XXXXX, EXPIRATION DATE: XX/XX/XXXX.					



SCALE IN FEET 1" = 20'

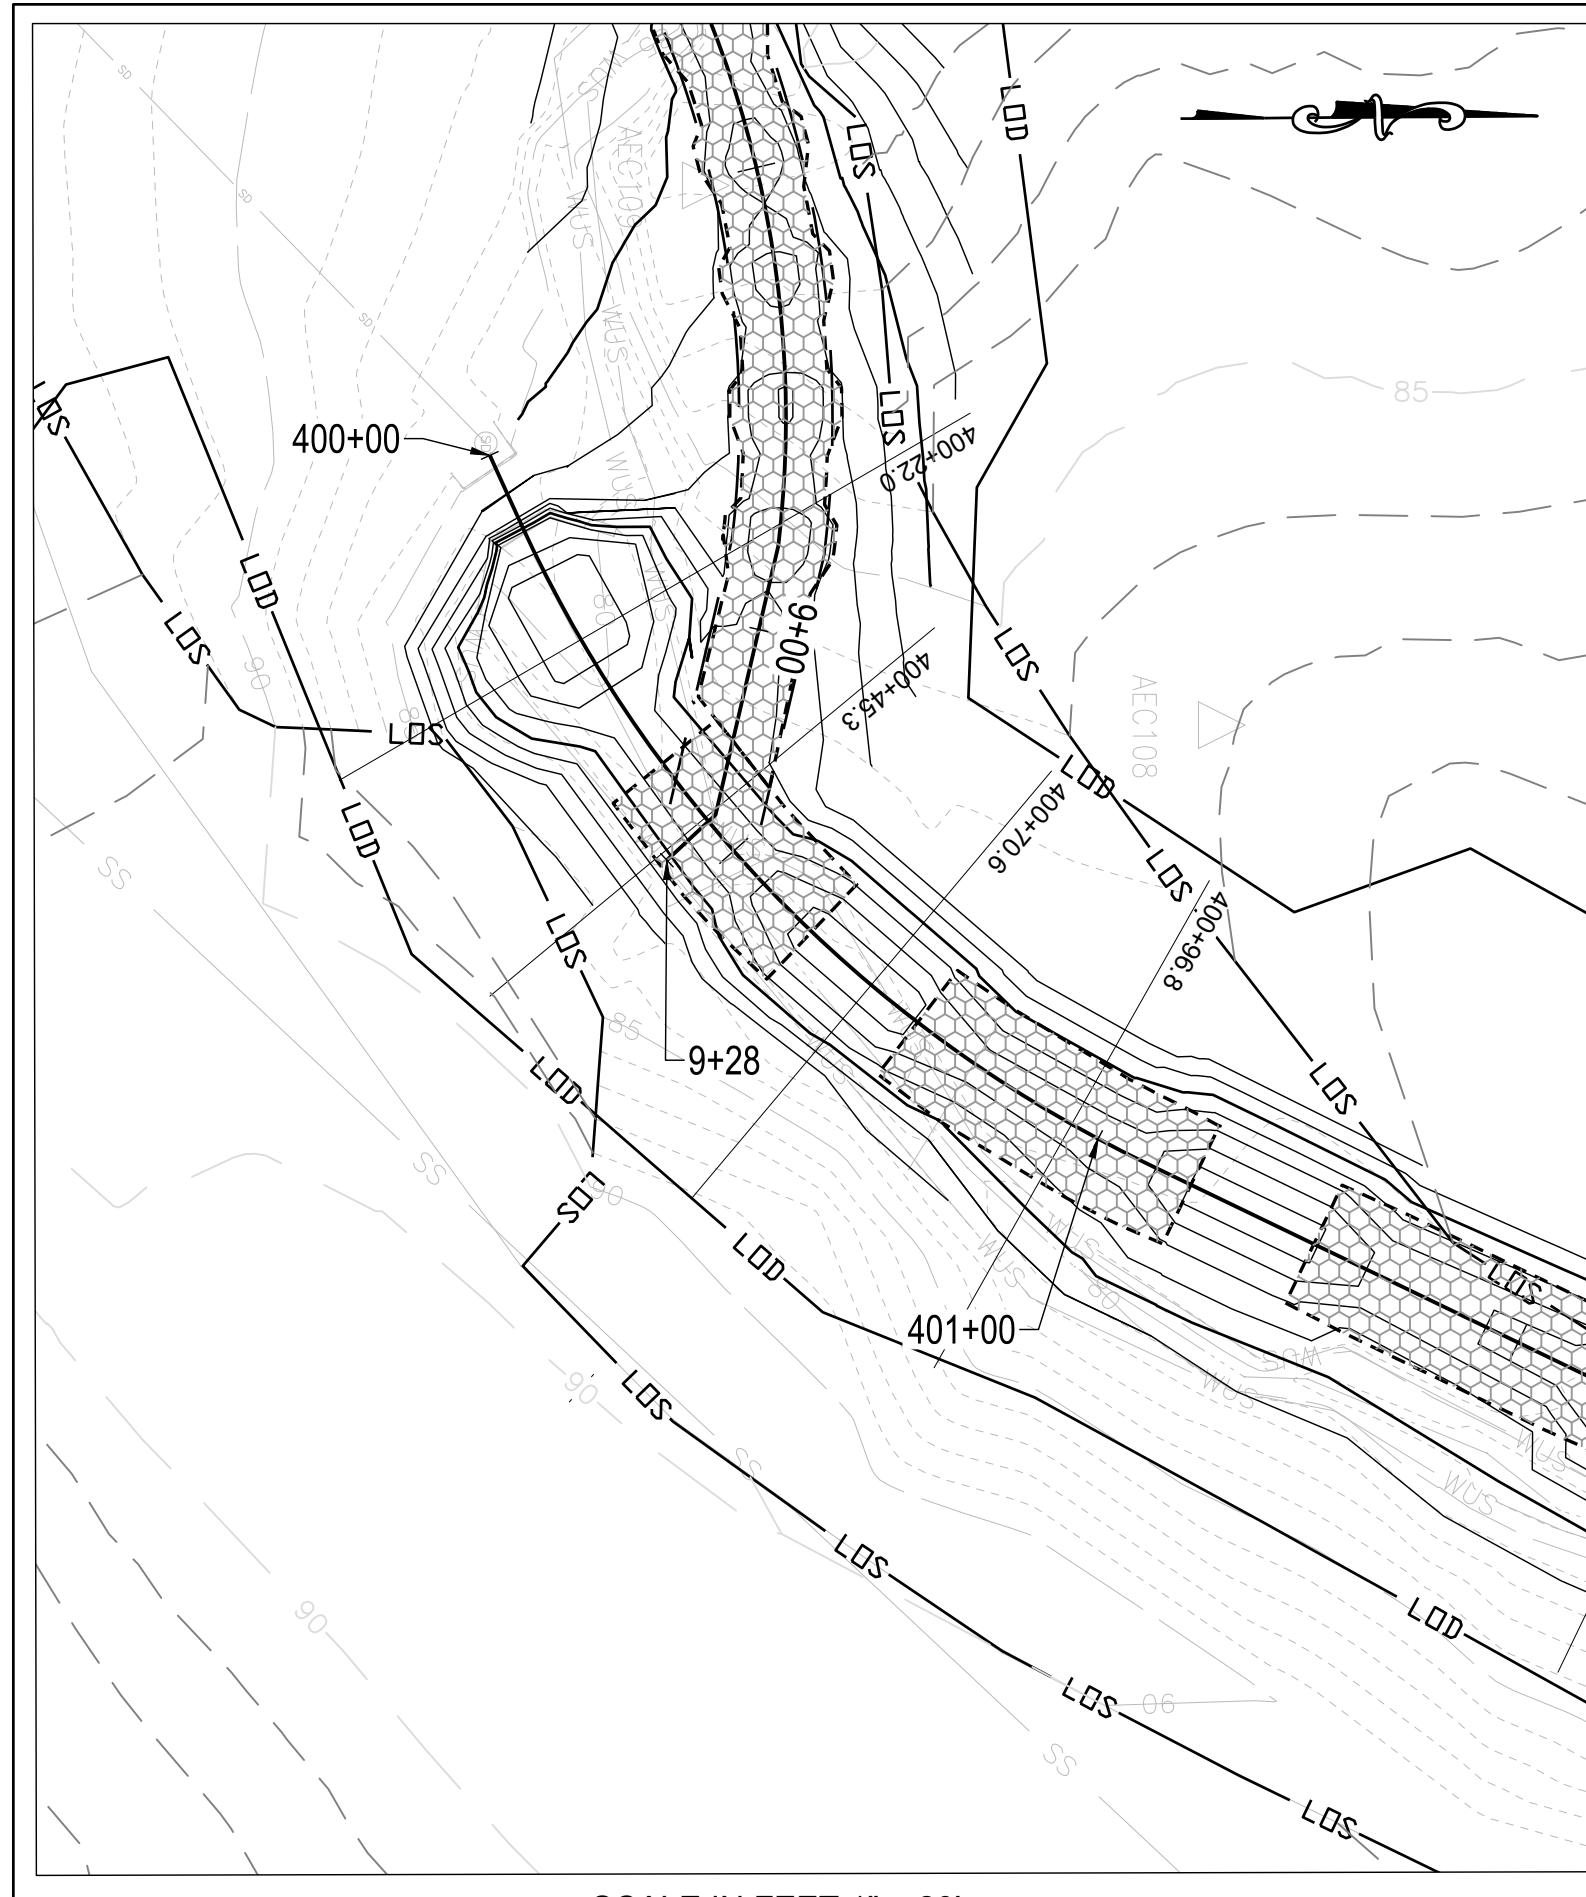

1 REACH 3 SECTION VIEWS

SCALE: 1" = 10'




SCALE IN FEET 1" = 10'



S/C PLAN # 59914	Revisions	HARFORD COUNTY, MARYLAND EDGEWATER VILLAGE PARK STREAM RESTORATION SECTION VIEW	
GRA-004622-2025			
SIGN AND SEAL		Drawn By : CA	AS SHOWN
		Designed By : CA	Scale : SEPTEMBER 2025
		Reviewed By : BWA	Date :
		Drawing No. SE-11 of SE-12	Sheet No. 35 of 65

PROFESSIONAL CERTIFICATION

I HEREBY CERTIFY THAT THESE DOCUMENTS WERE PREPARED OR APPROVED BY ME, AND THAT I AM A DULY LICENSED PROFESSIONAL ENGINEER UNDER THE LAWS OF THE STATE OF MARYLAND. LICENSE NO. XXXXX, EXPIRATION DATE: XX/XX/XXXX.

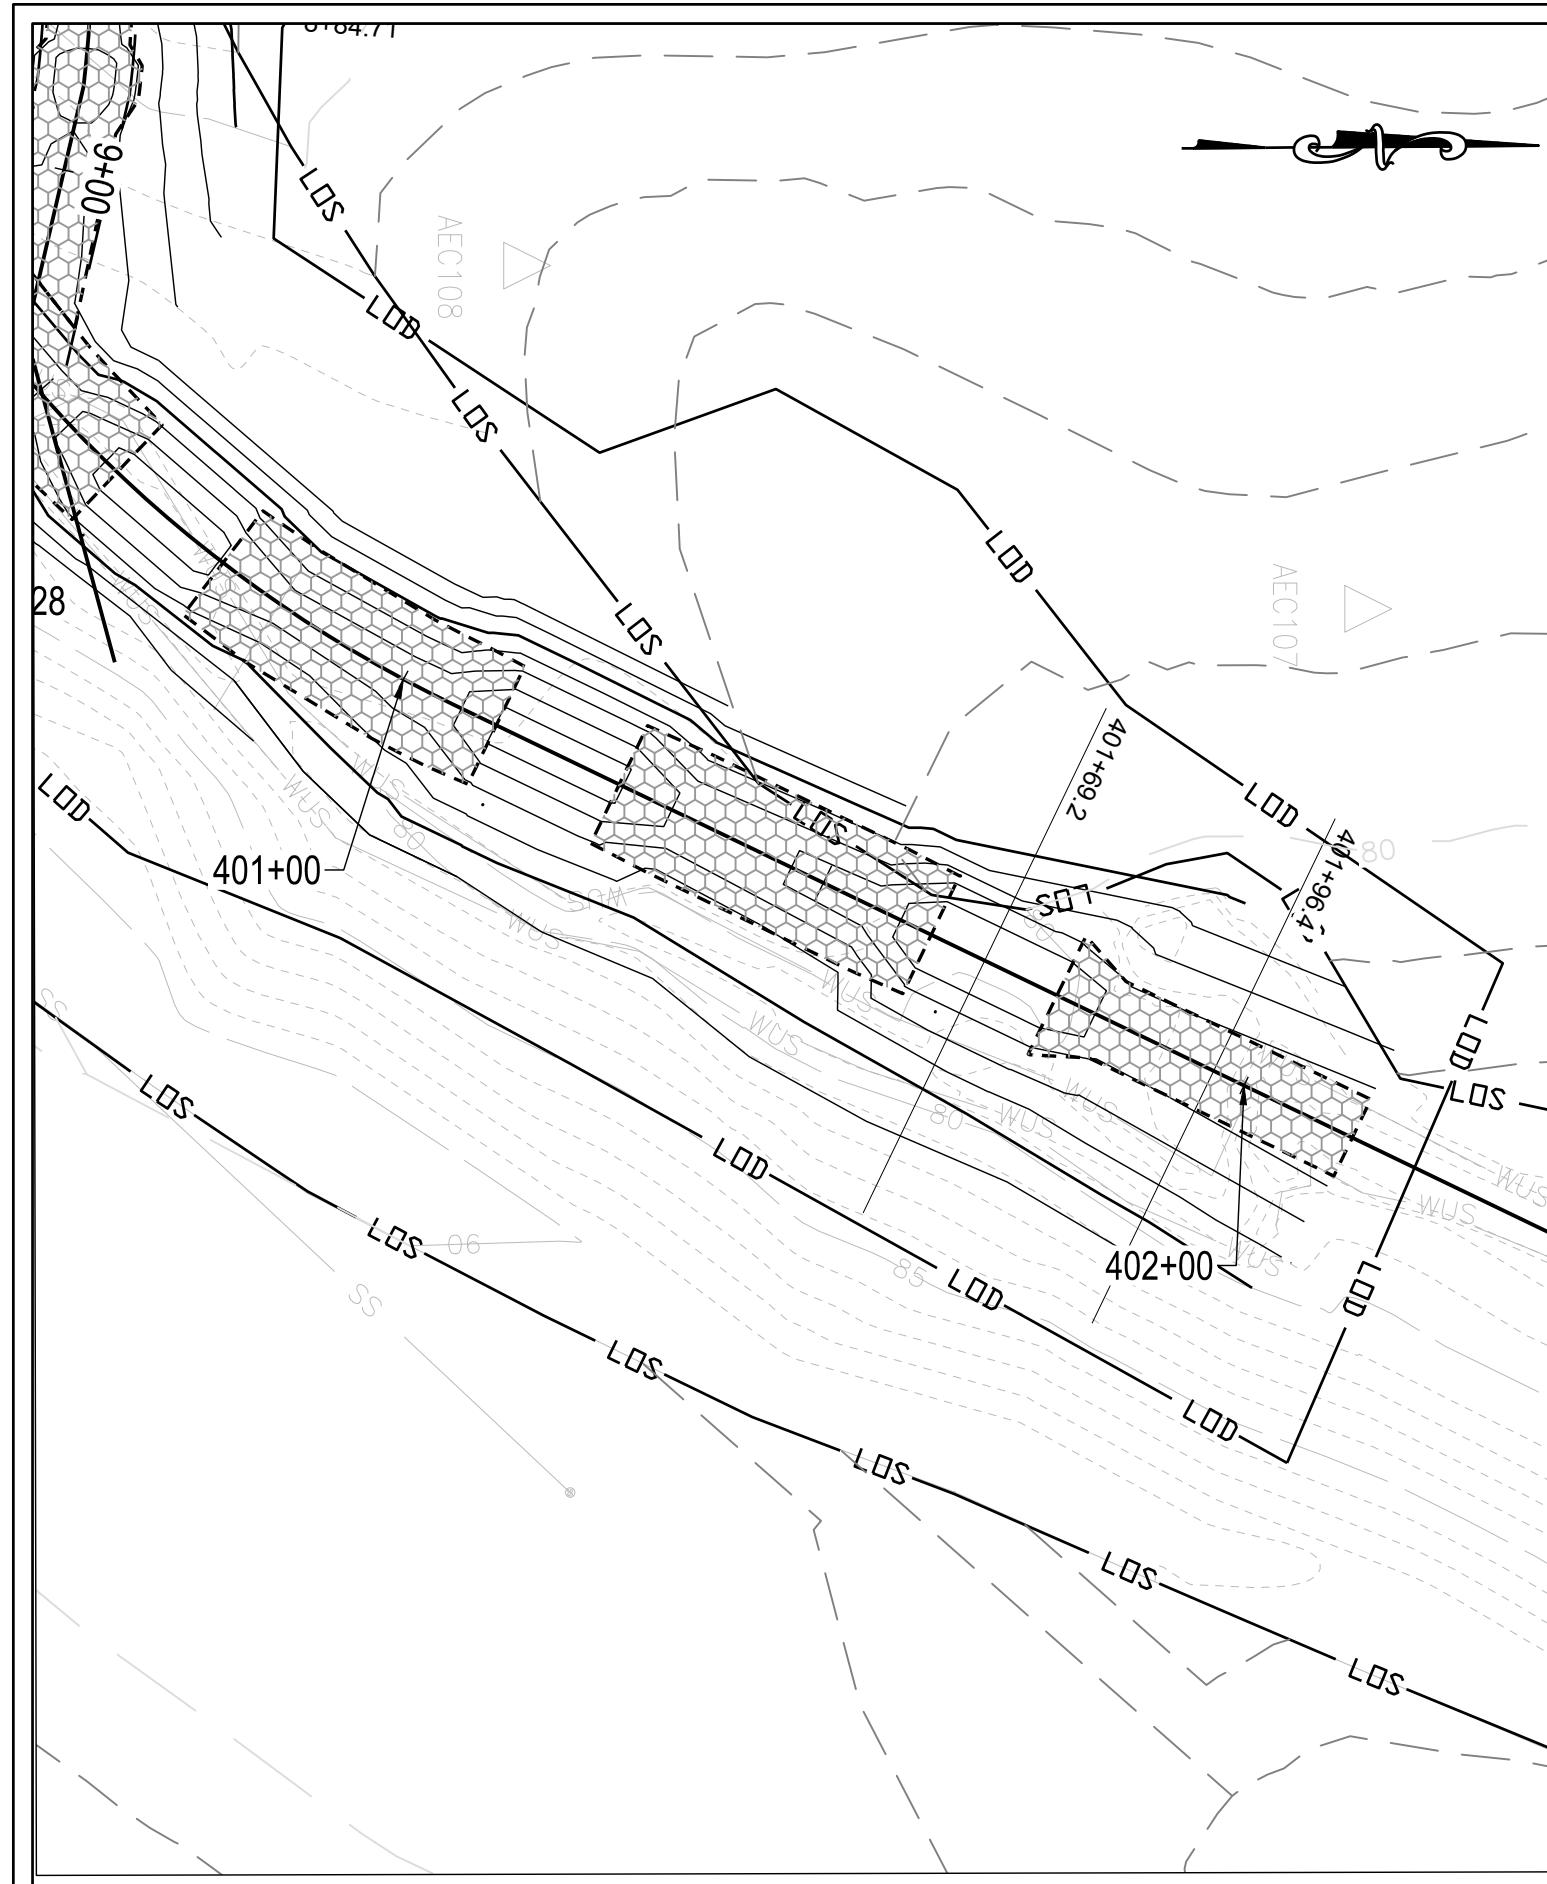

SCALE IN FEET 1" = 20'

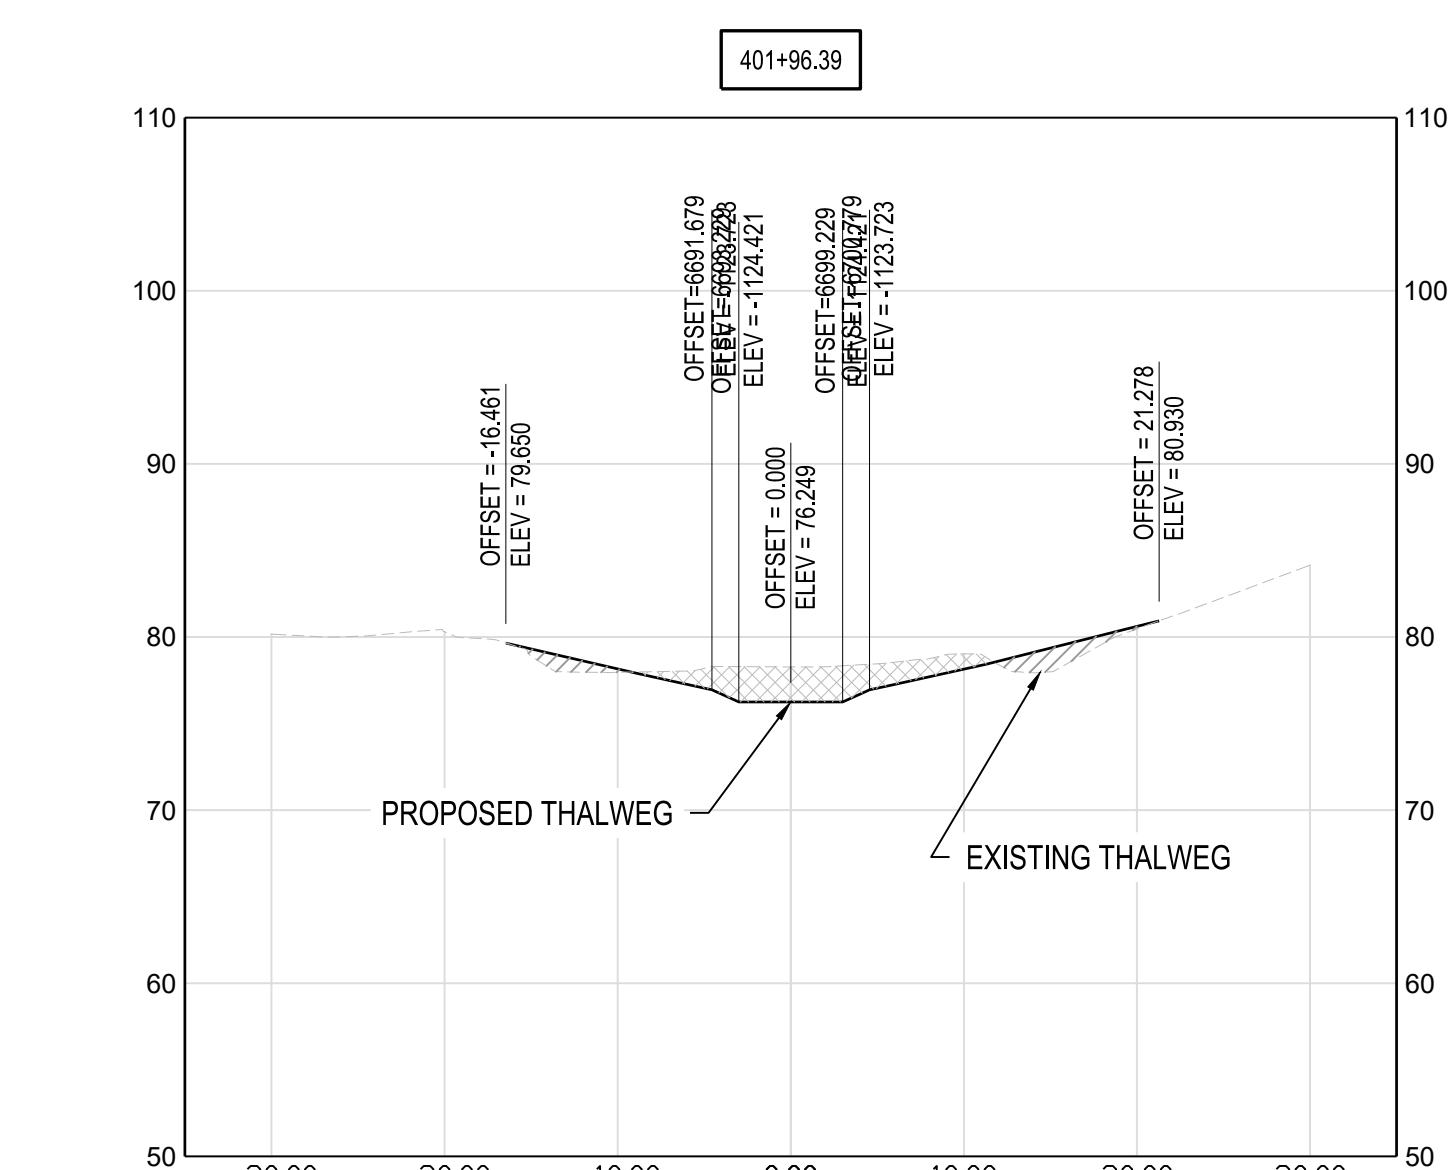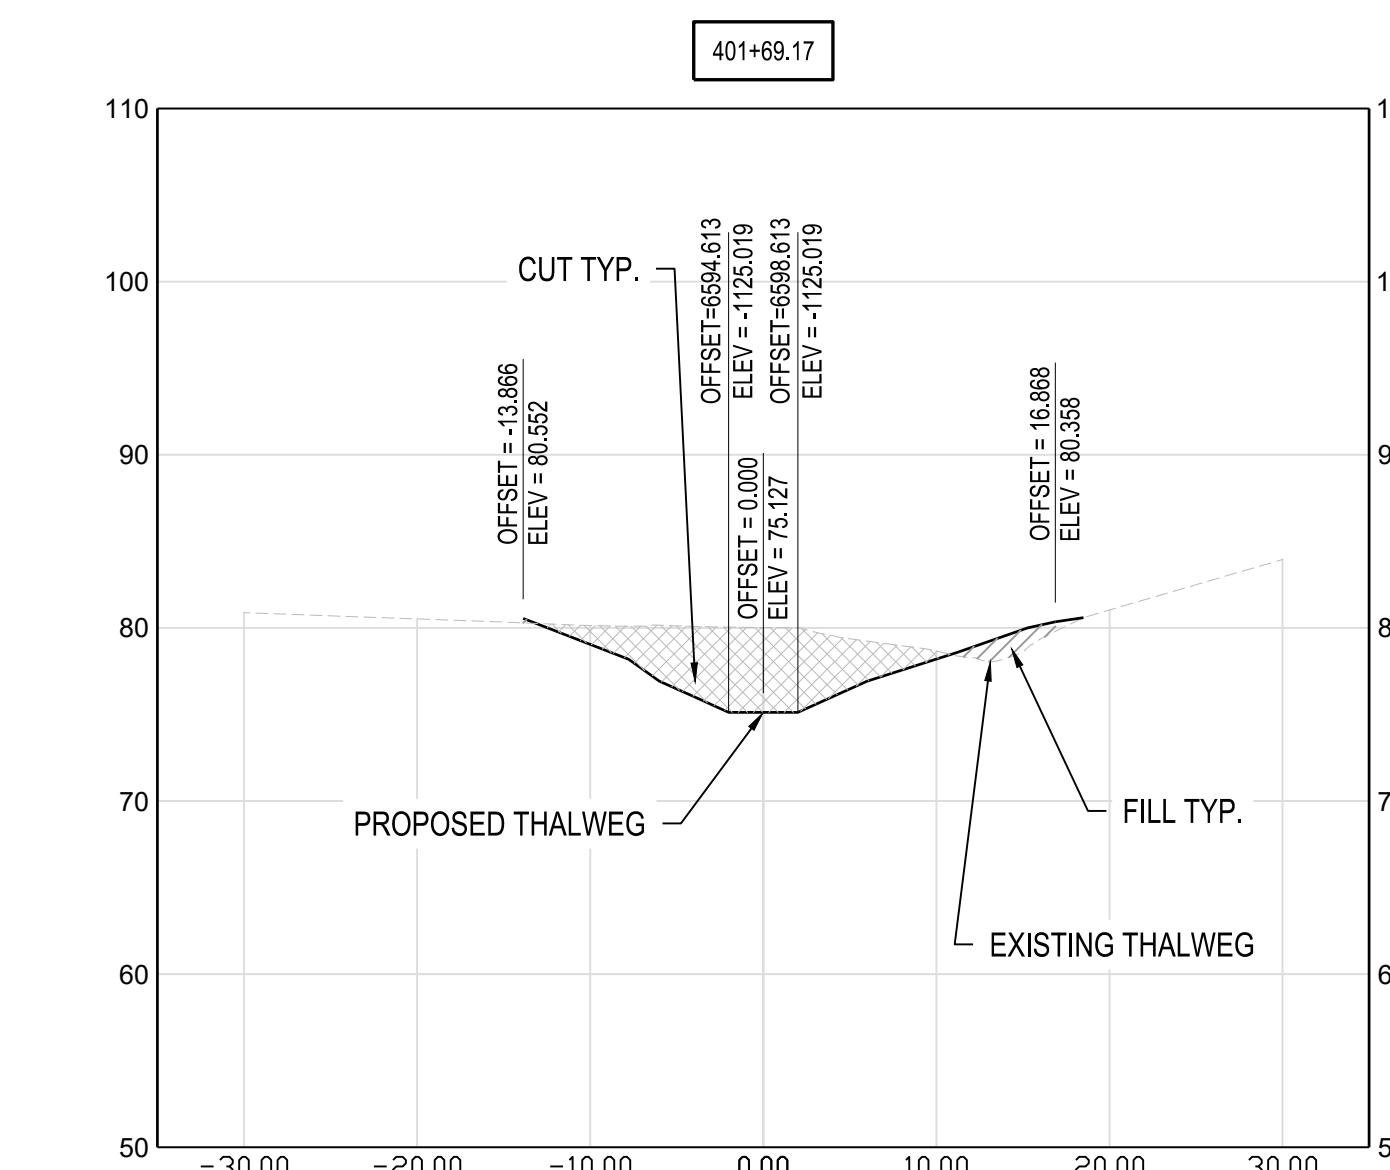

1 REACH 3 SECTION VIEWS

SCALE: 1" = 10'
10 0 10 20
SCALE IN FEET 1" = 10'




S/C PLAN # 59914		Revisions	HARFORD COUNTY, MARYLAND	
GRA-004622-2025		SIGN AND SEAL	EDGEMARSH VILLAGE PARK	
			STREAM RESTORATION	
			SECTION VIEW	
			Drawn By : CA	AS SHOWN
		Designed By : CA	Scale :	
		Reviewed By : BWA	Date : SEPTEMBER 2025	
		Drawing No. SE-12 of SE-12	Sheet No.	

PROFESSIONAL CERTIFICATION


I HEREBY CERTIFY THAT THESE DOCUMENTS WERE PREPARED OR APPROVED BY ME, AND THAT I AM A DULY LICENSED PROFESSIONAL ENGINEER UNDER THE LAWS OF THE STATE OF MARYLAND. LICENSE NO. XXXXX, EXPIRATION DATE: XX/XX/XXXX.

1 HGC DWG ID No.: _____

1 Scale : 1 inch

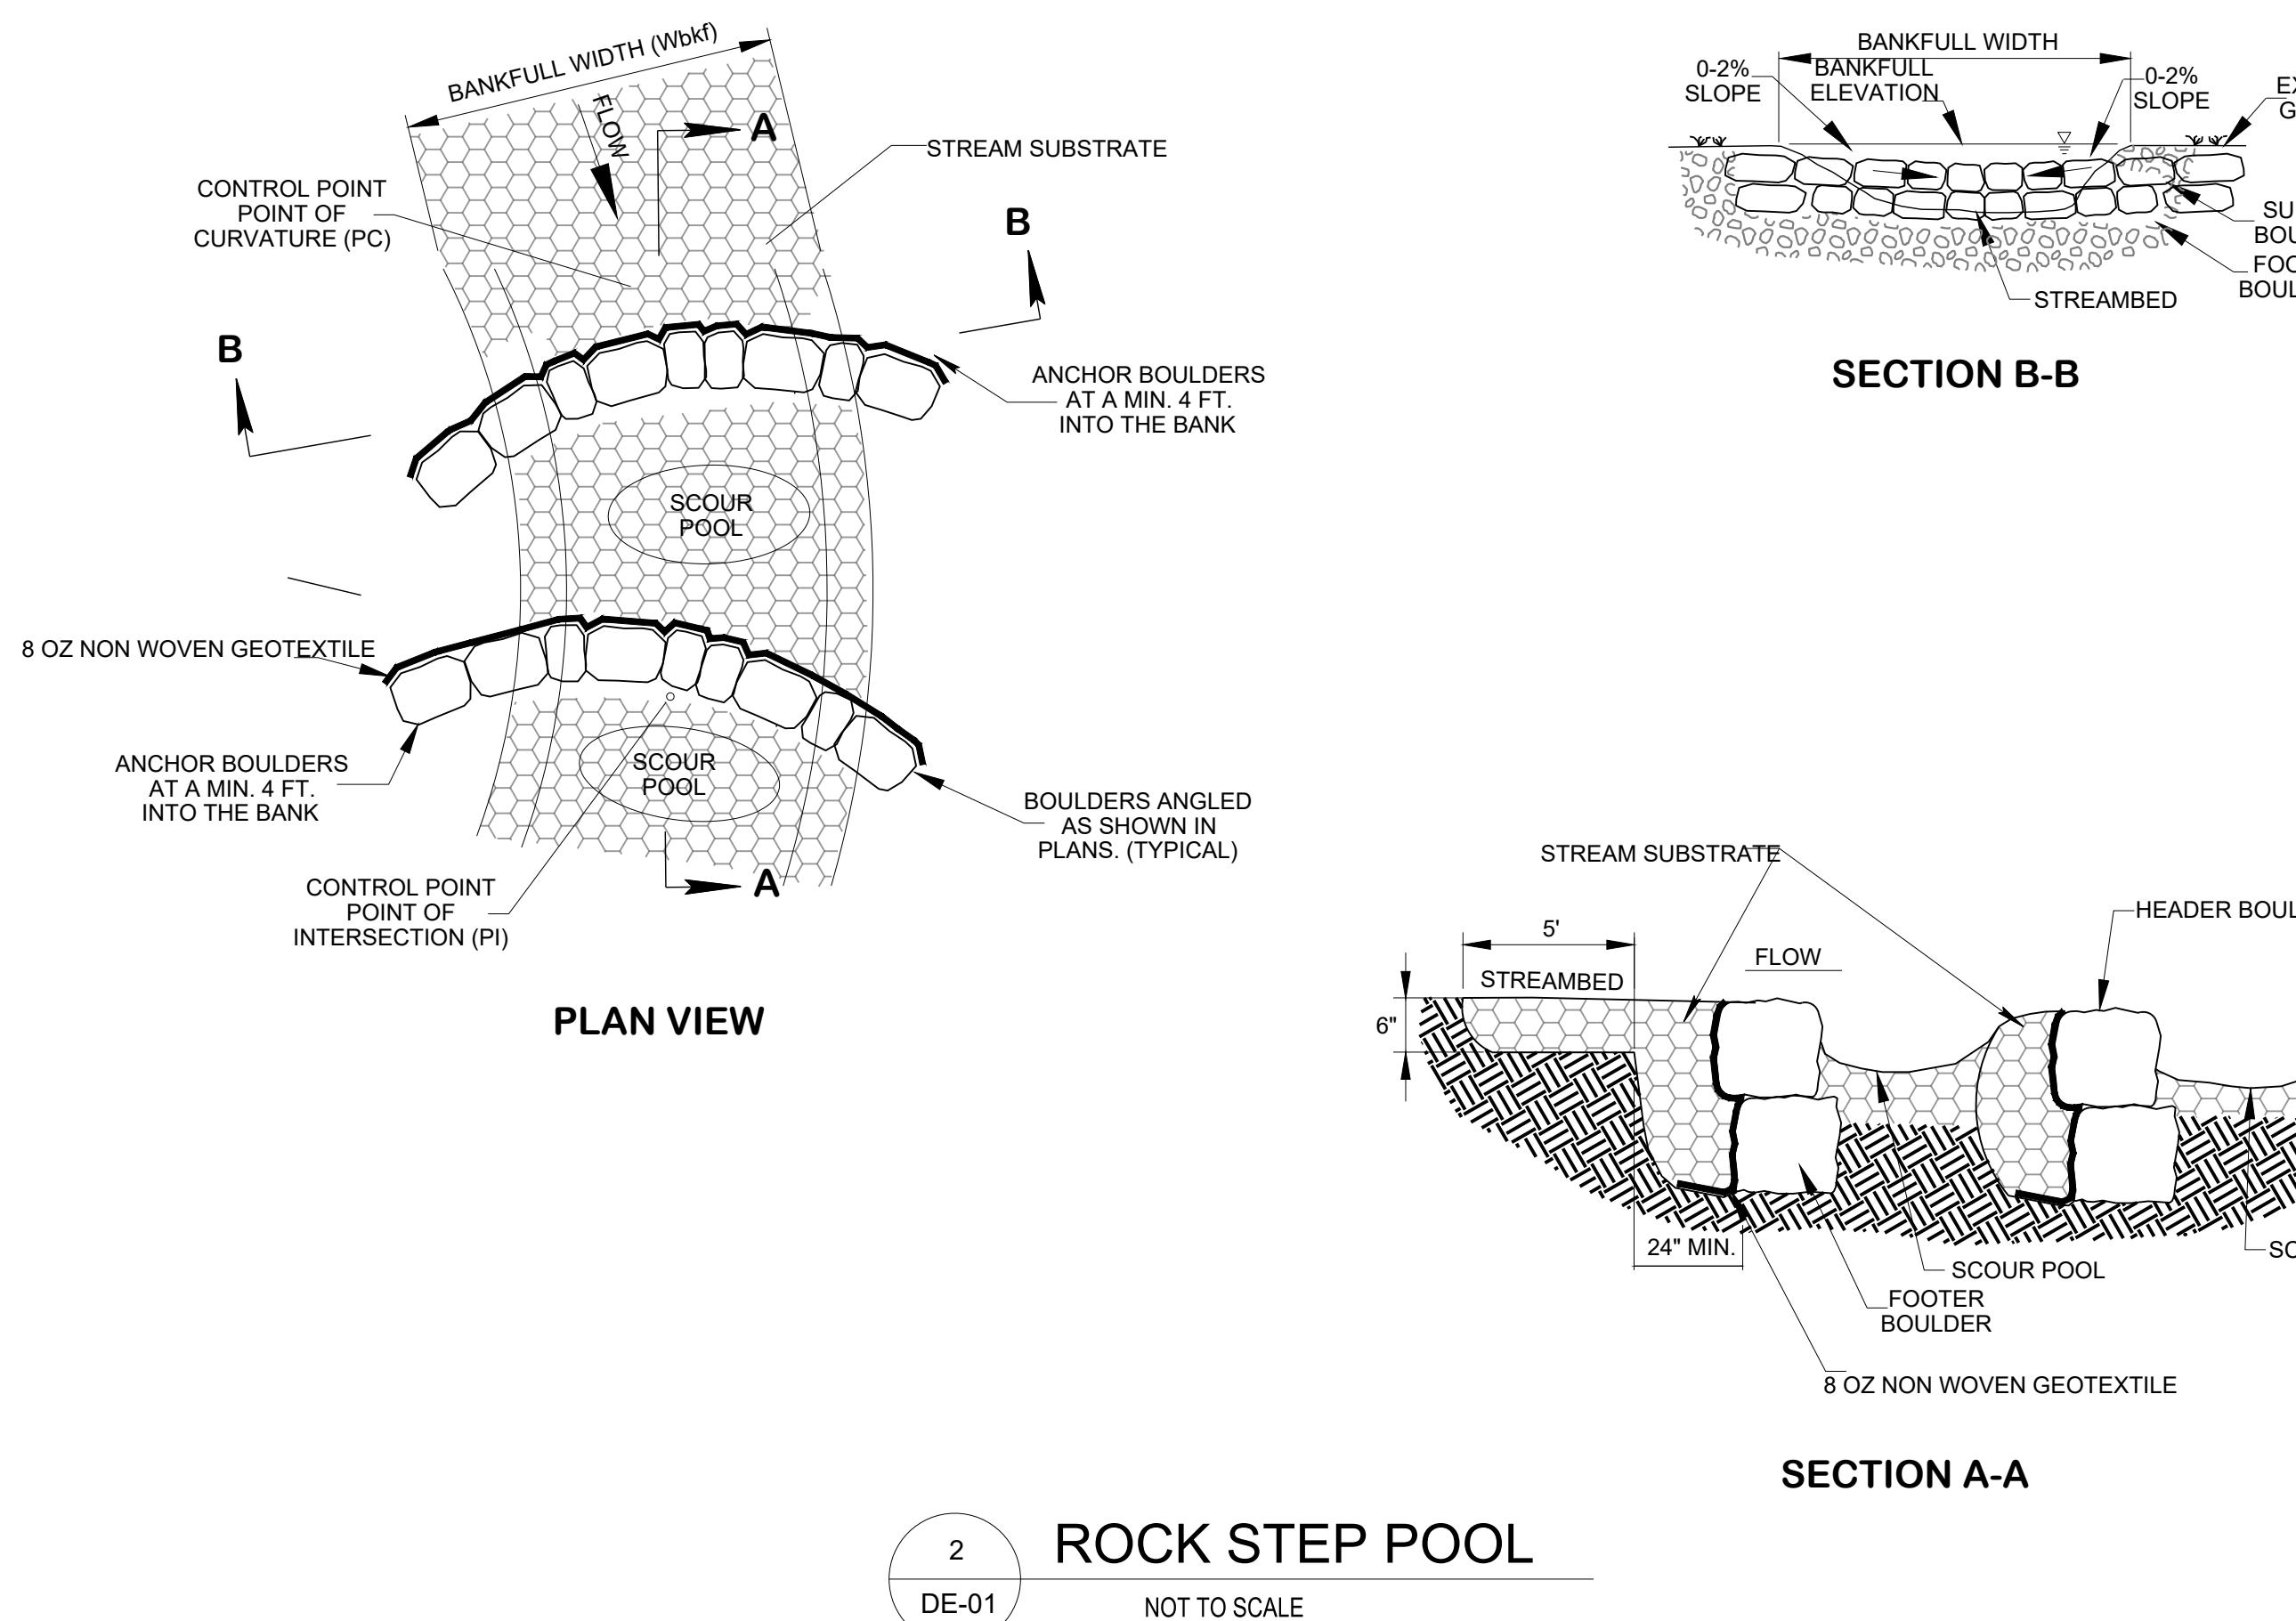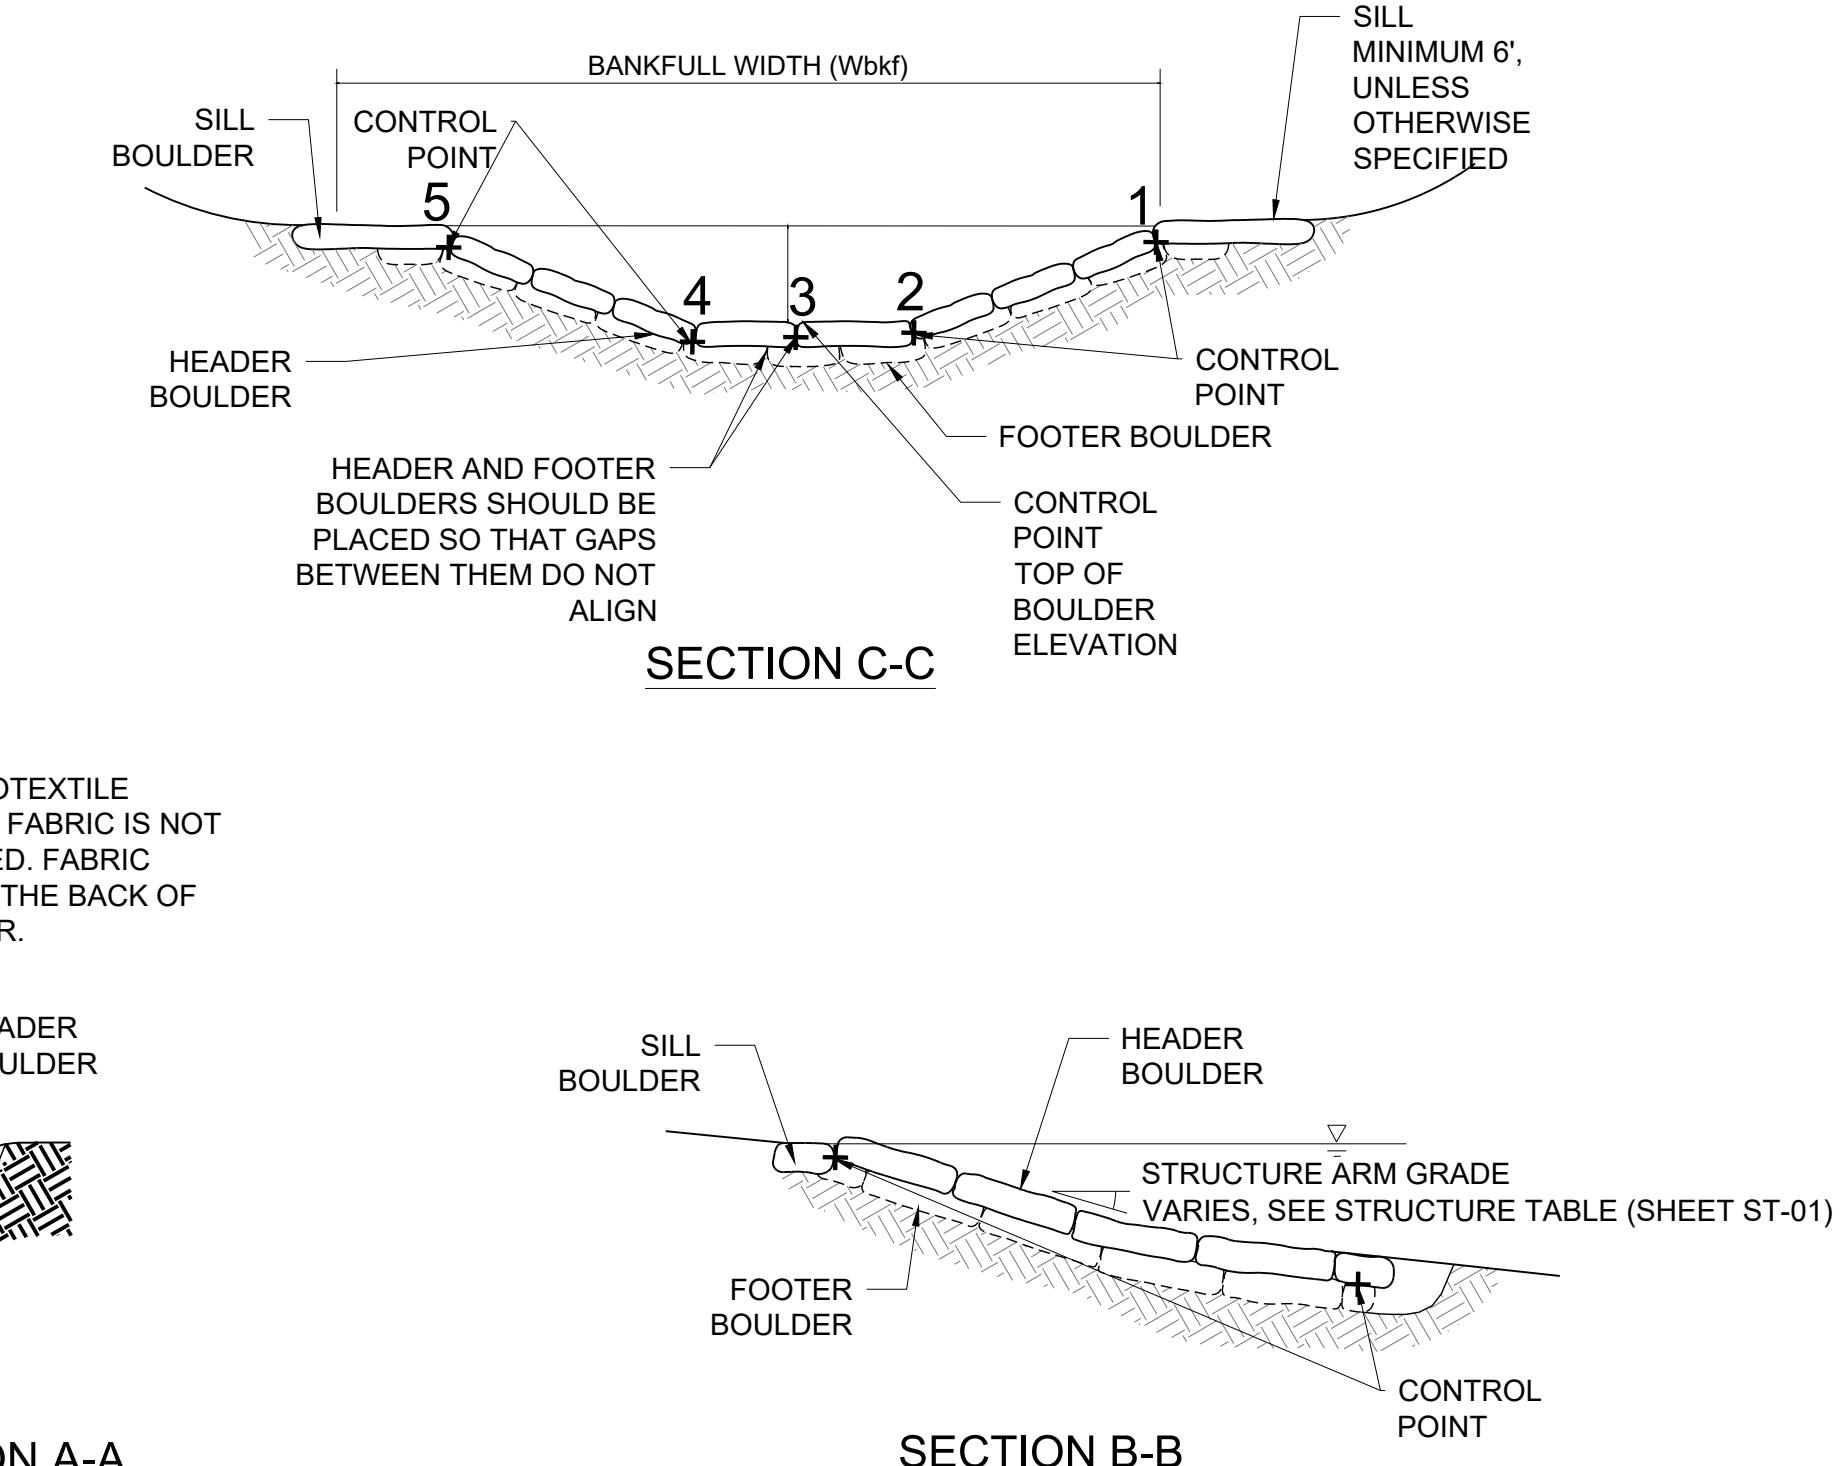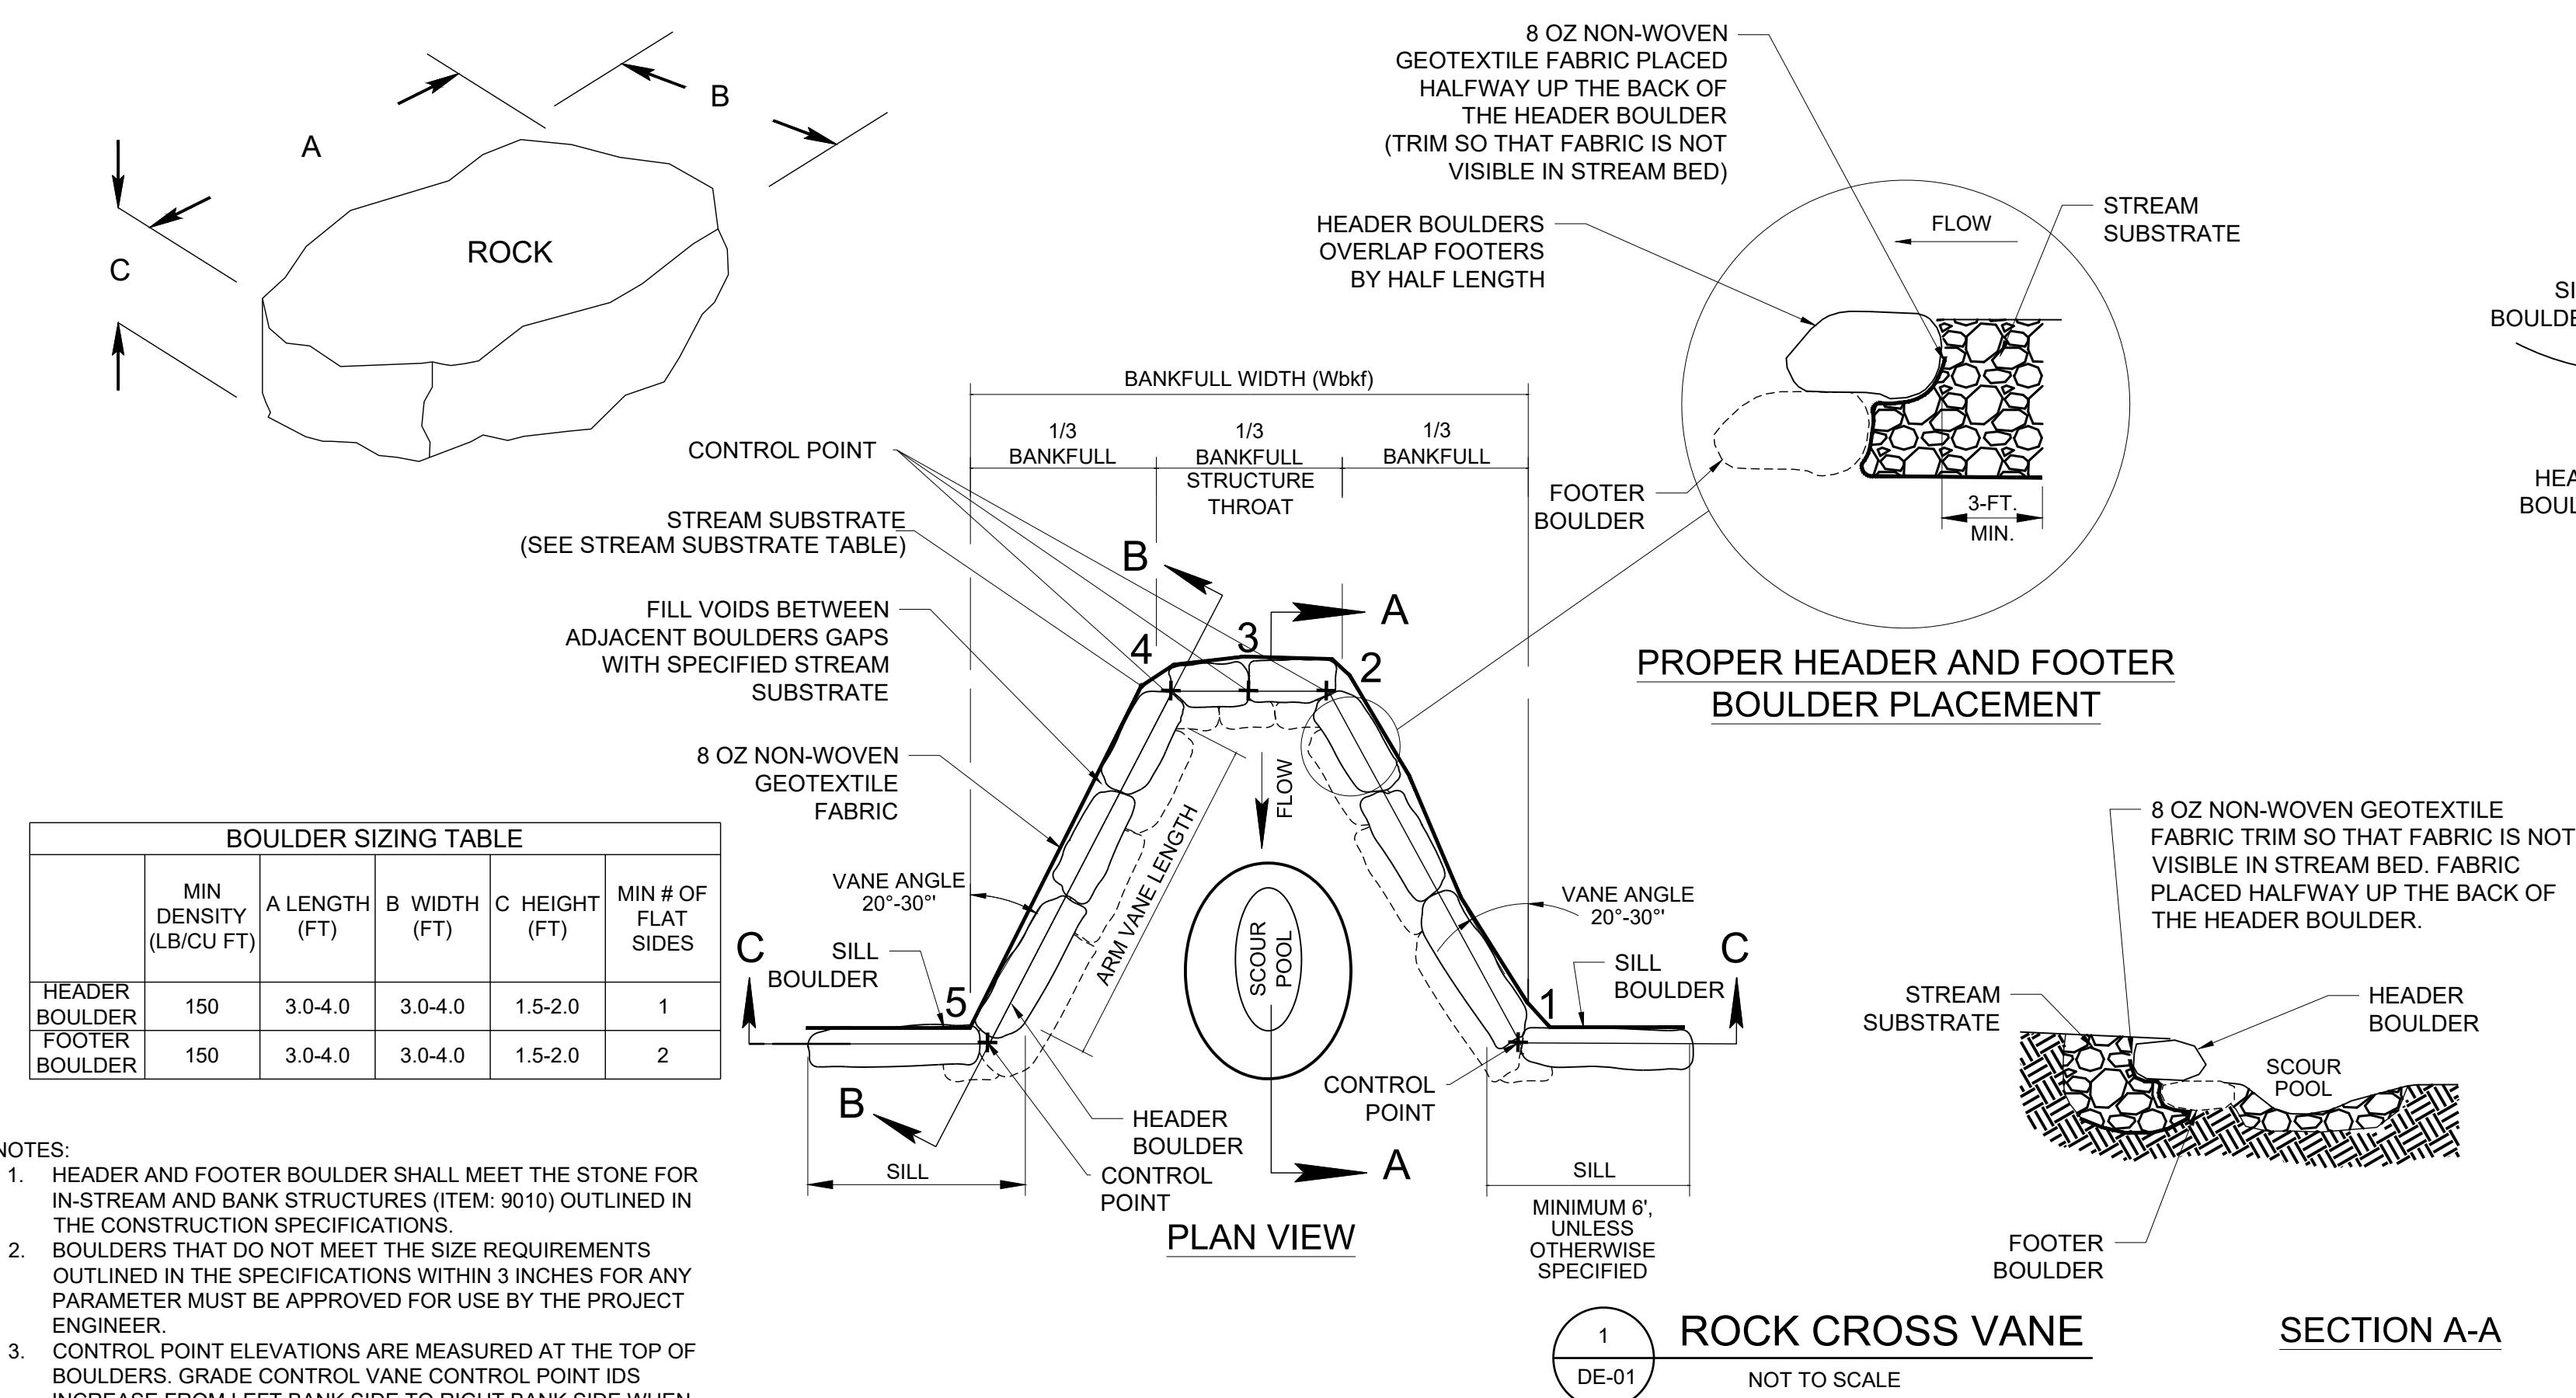

S/C PLAN # 59914		Revisions	HARFORD COUNTY, MARYLAND	
GRA-004622-2025			EDGEWATER VILLAGE PARK	
			STREAM RESTORATION	
			STREAM RESTORATION DETAILS	
			Drawn By : CA	AS NOTED
			Designed By : CA	Scale : 1:100
			Reviewed By : BWA	Date : SEPTEMBER 2025
SIGN AND SEAL			Drawing No. DE-01 of DE-06	Sheet No. 37 of 65
PROFESSIONAL CERTIFICATION			HGC DWG ID No. :	
I HEREBY CERTIFY THAT THESE DOCUMENTS WERE PREPARED OR APPROVED BY ME, AND THAT I AM A DULY LICENSED PROFESSIONAL ENGINEER UNDER THE LAWS OF THE STATE OF MARYLAND. LICENSE NO. XXXXX, EXPIRATION DATE: XX/XX/XXXX.				

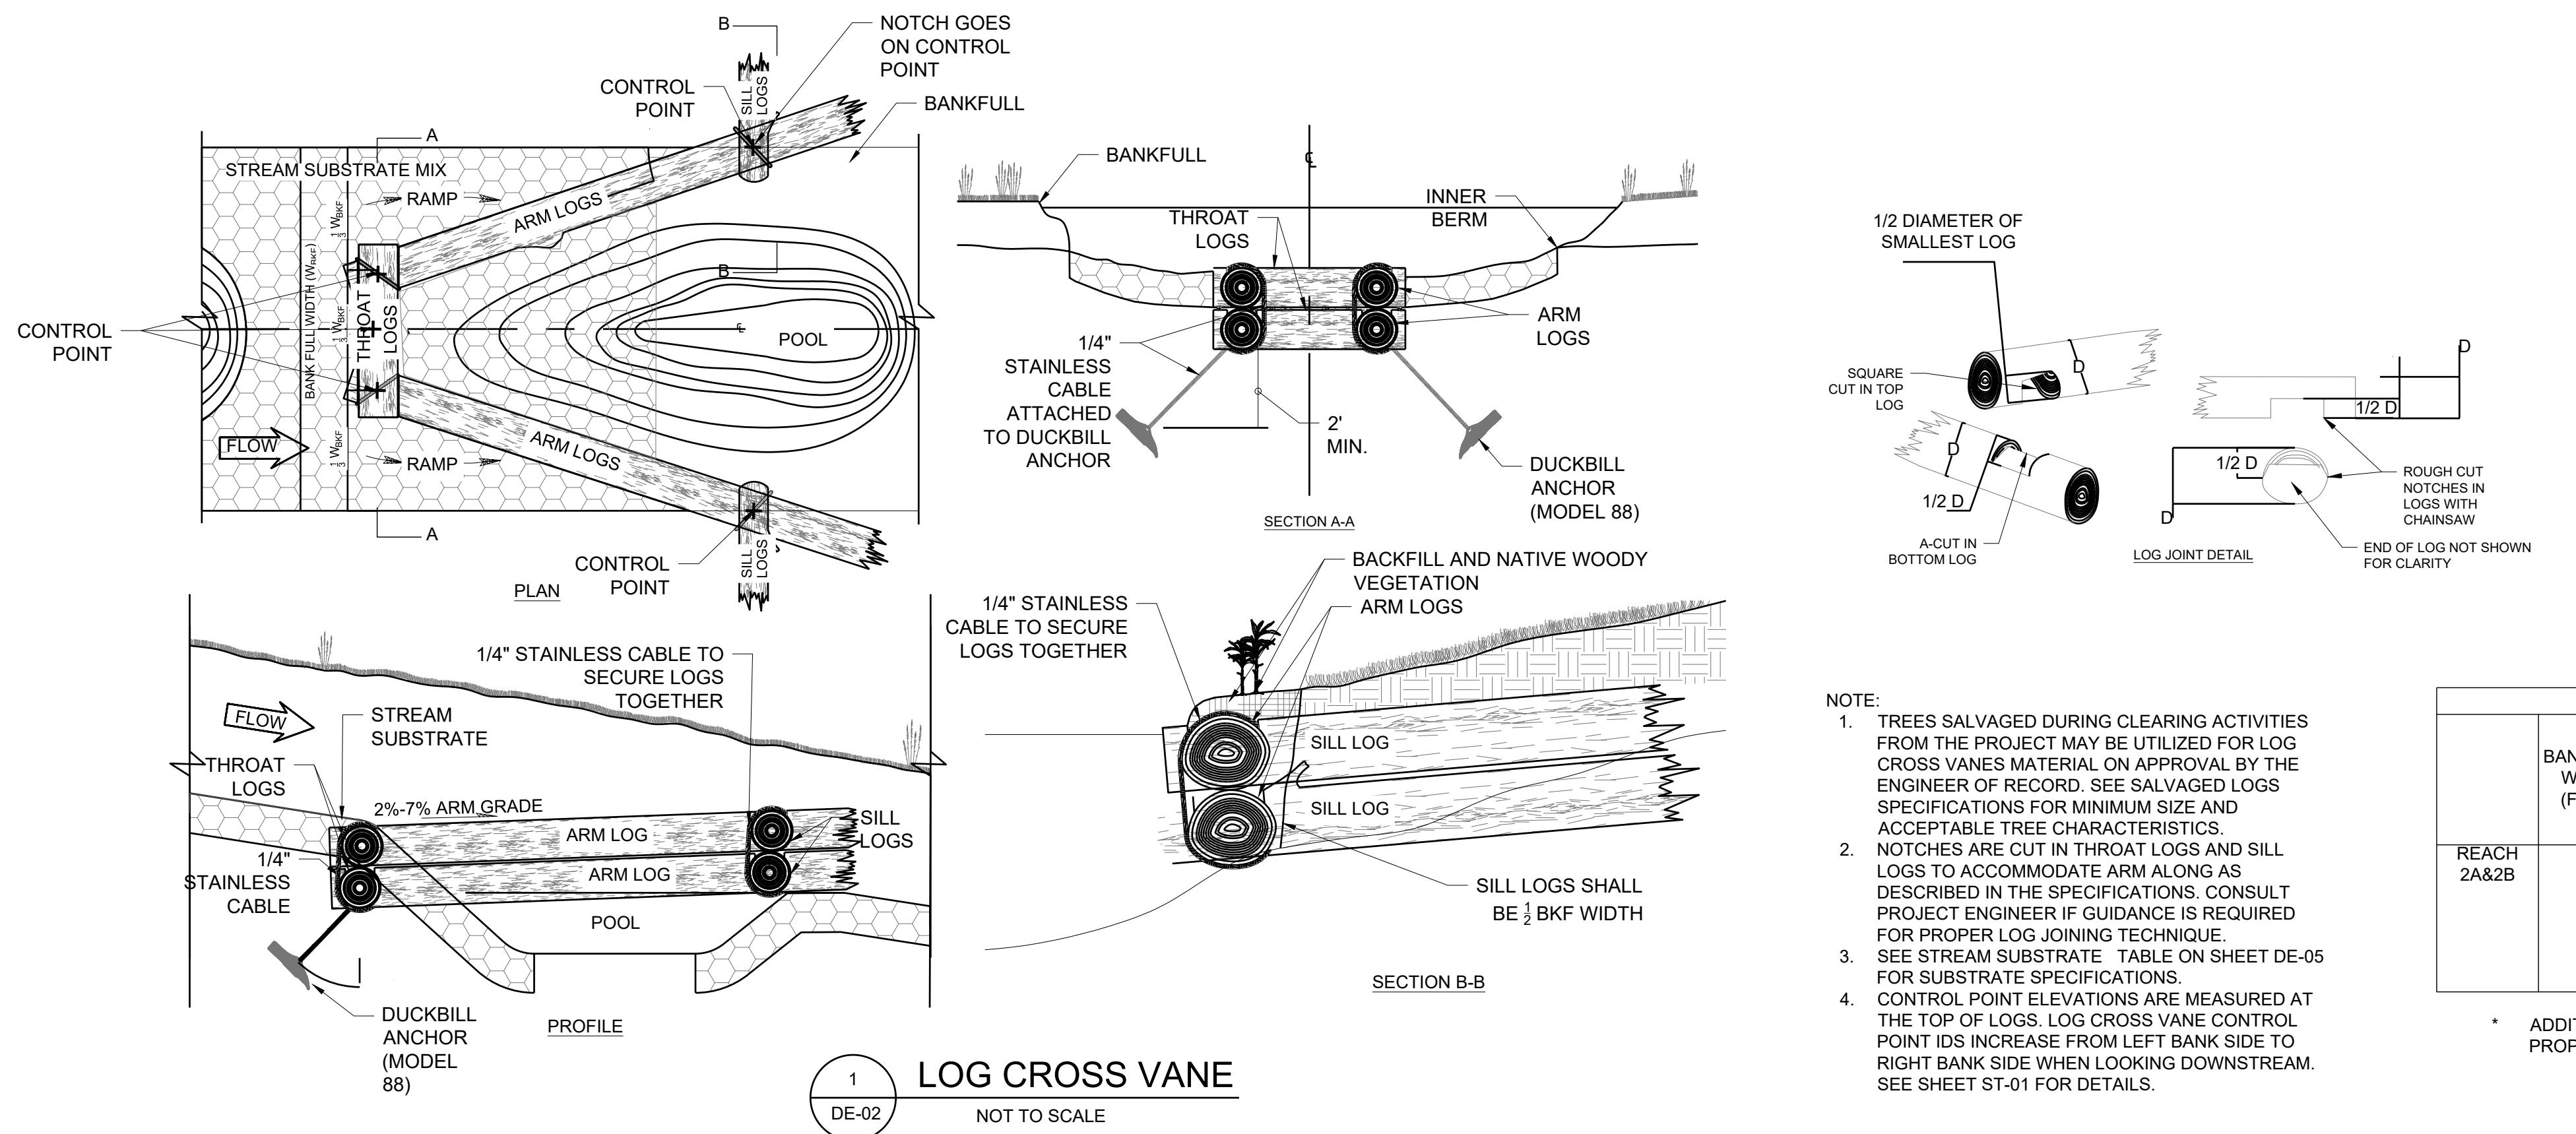


NOTE:


1. TREES SALVAGED DURING CLEARING ACTIVITIES FROM THE PROJECT MAY BE UTILIZED FOR LOG CROSS VANE MATERIAL ON APPROVAL BY THE ENGINEER OF RECORD. SEE SALVAGED LOGS SPECIFICATIONS FOR MINIMUM SIZE AND ACCEPTABLE TREE CHARACTERISTICS.
2. NOTCHES ARE CUT THROAT LOGS AND SILL LOGS TO ACCOMMODATE ARM ALONG AS DESCRIBED IN THE SPECIFICATIONS. CONSULT PROJECT ENGINEER IF GUIDANCE IS REQUIRED FOR PROPER LOG JOINING TECHNIQUE.
3. SEE STREAM SUBSTRATE TABLE ON SHEET DE-05 FOR SUBSTRATE SPECIFICATIONS.
4. CONTROL POINT ELEVATIONS ARE MEASURED AT THE TOP OF LOGS. LOG CROSS VANE CONTROL POINT IDS INCREASE FROM LEFT BANK SIDE TO RIGHT BANK SIDE WHEN LOOKING DOWNSTREAM. SEE SHEET ST-01 FOR DETAILS.

LOG CROSS VANE SIZING CHART REACH 2A&2B					
	BANKFULL WIDTH (FEET)	MIN. THROAT LOG LENGTH * (1/2 W_BKF) (FEET)	MIN. SILL LENGTH * (1/2 W_BKF) (FEET)	MIN. ARM LENGTH	MIN. DIAMETER (INCHES)
REACH 2A&2B	12'	4'	6'	SEE ST-01 FOR ARM LENGTH, VARIES BY STRUCTURE	12"

* ADDITIONAL LOG LENGTH MAY BE REQUIRED FOR PROPER LOG JOINTS

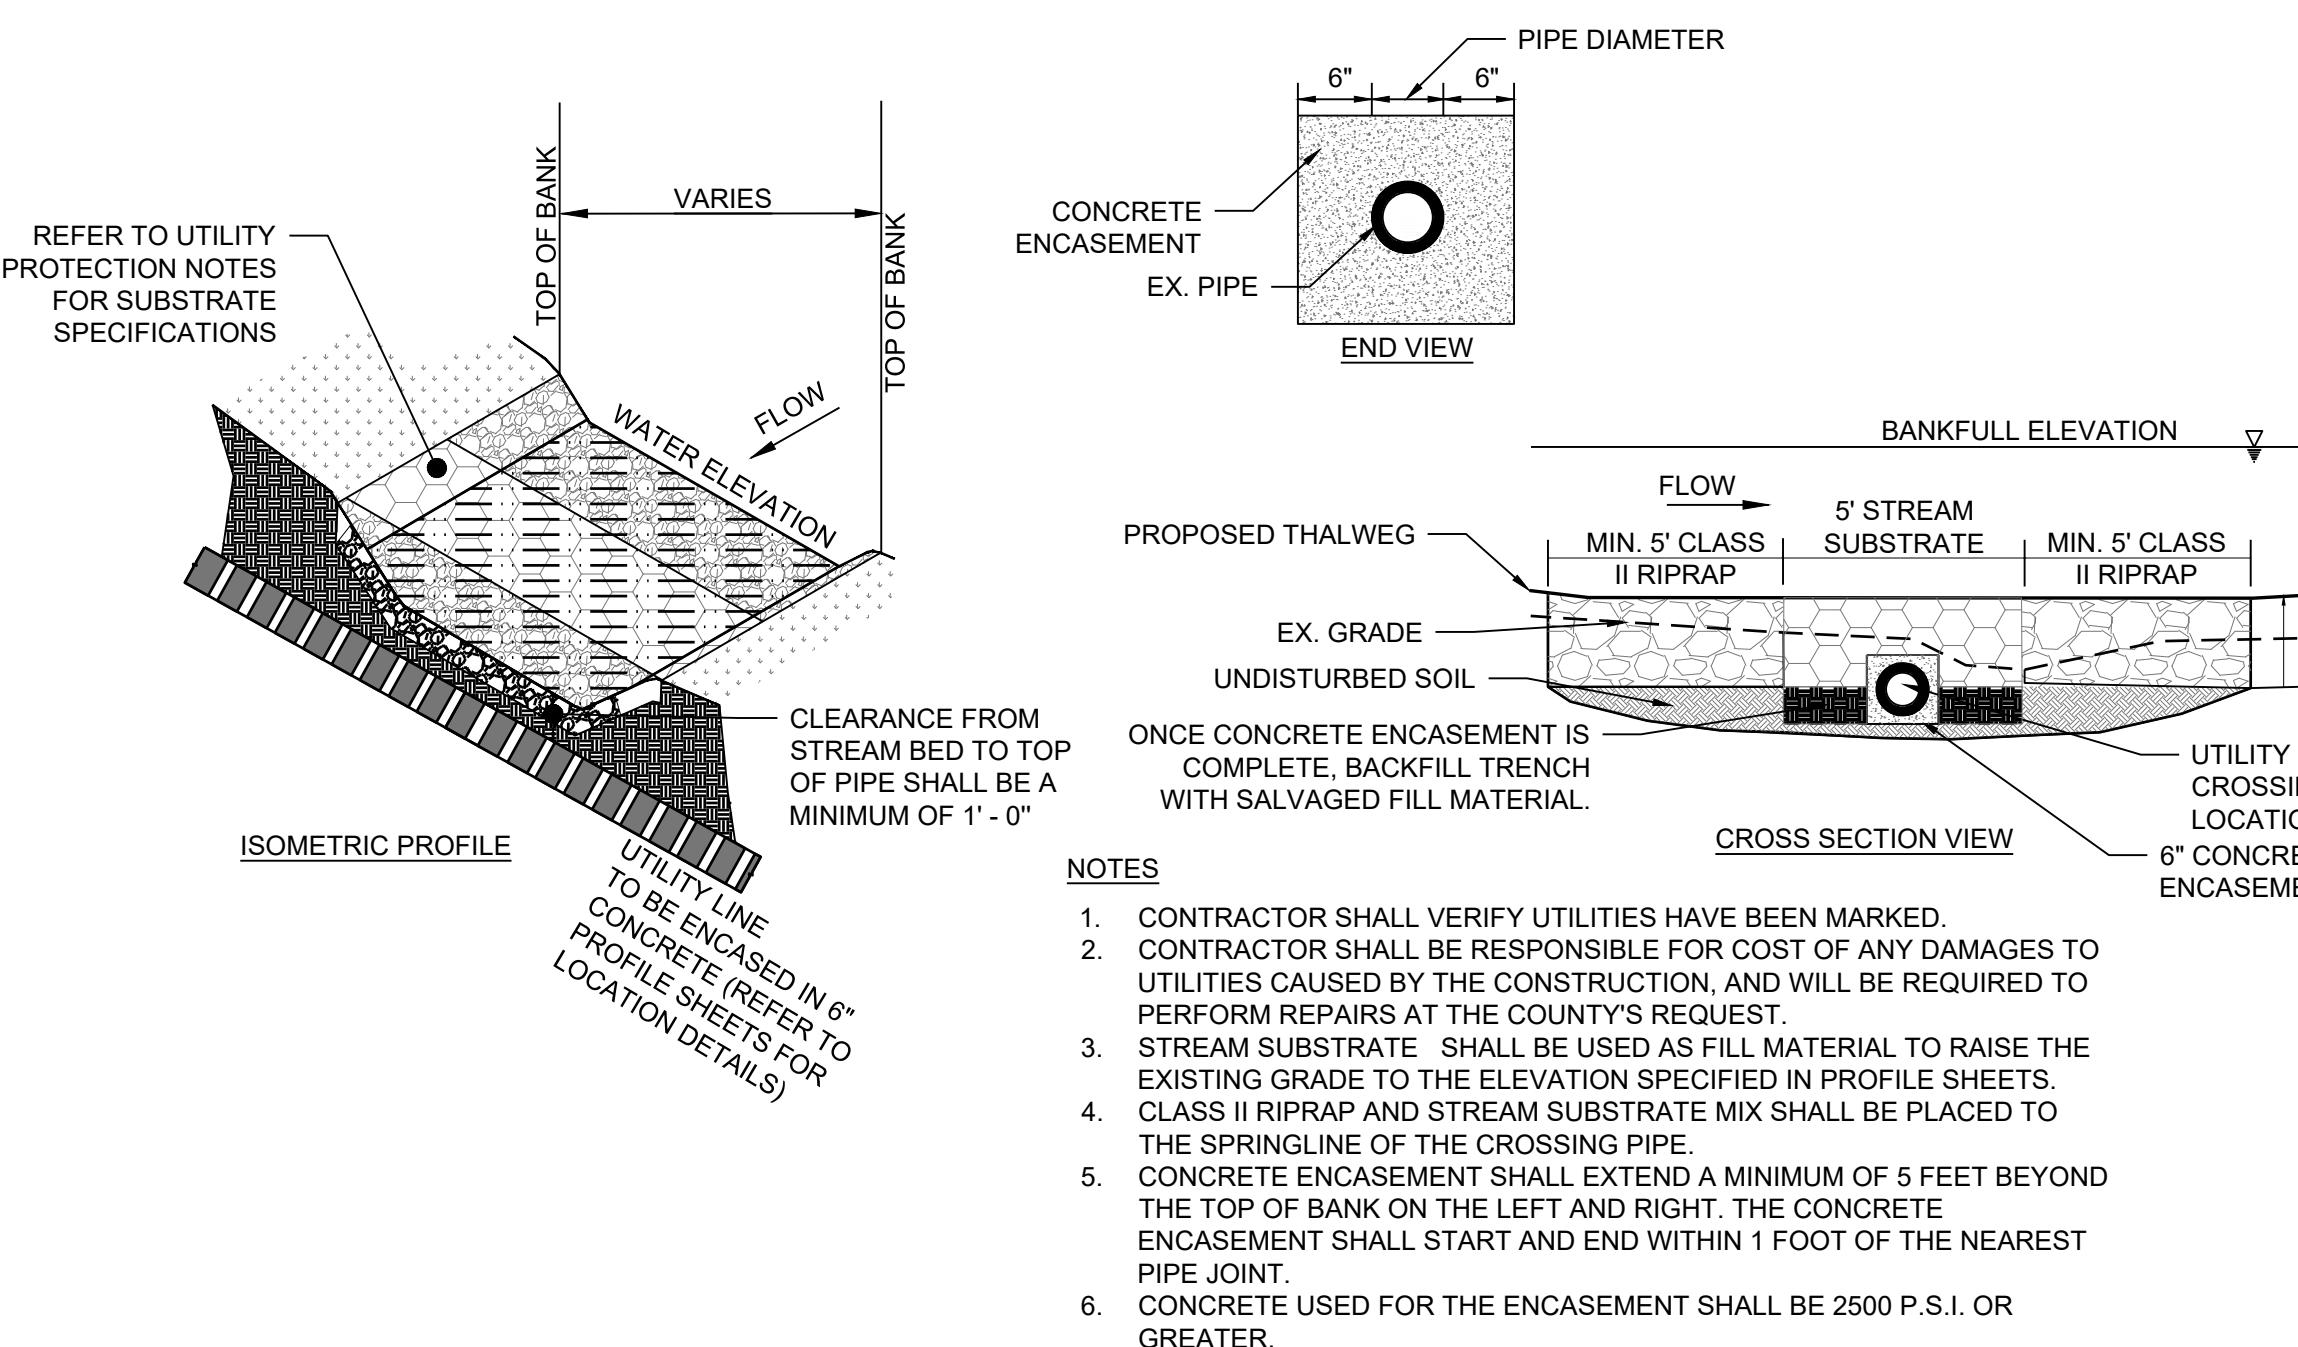


2 ARMoured UTILITY PROTECTION - WITH PIPE ENCASEMENT
DE-02 NOT TO SCALE

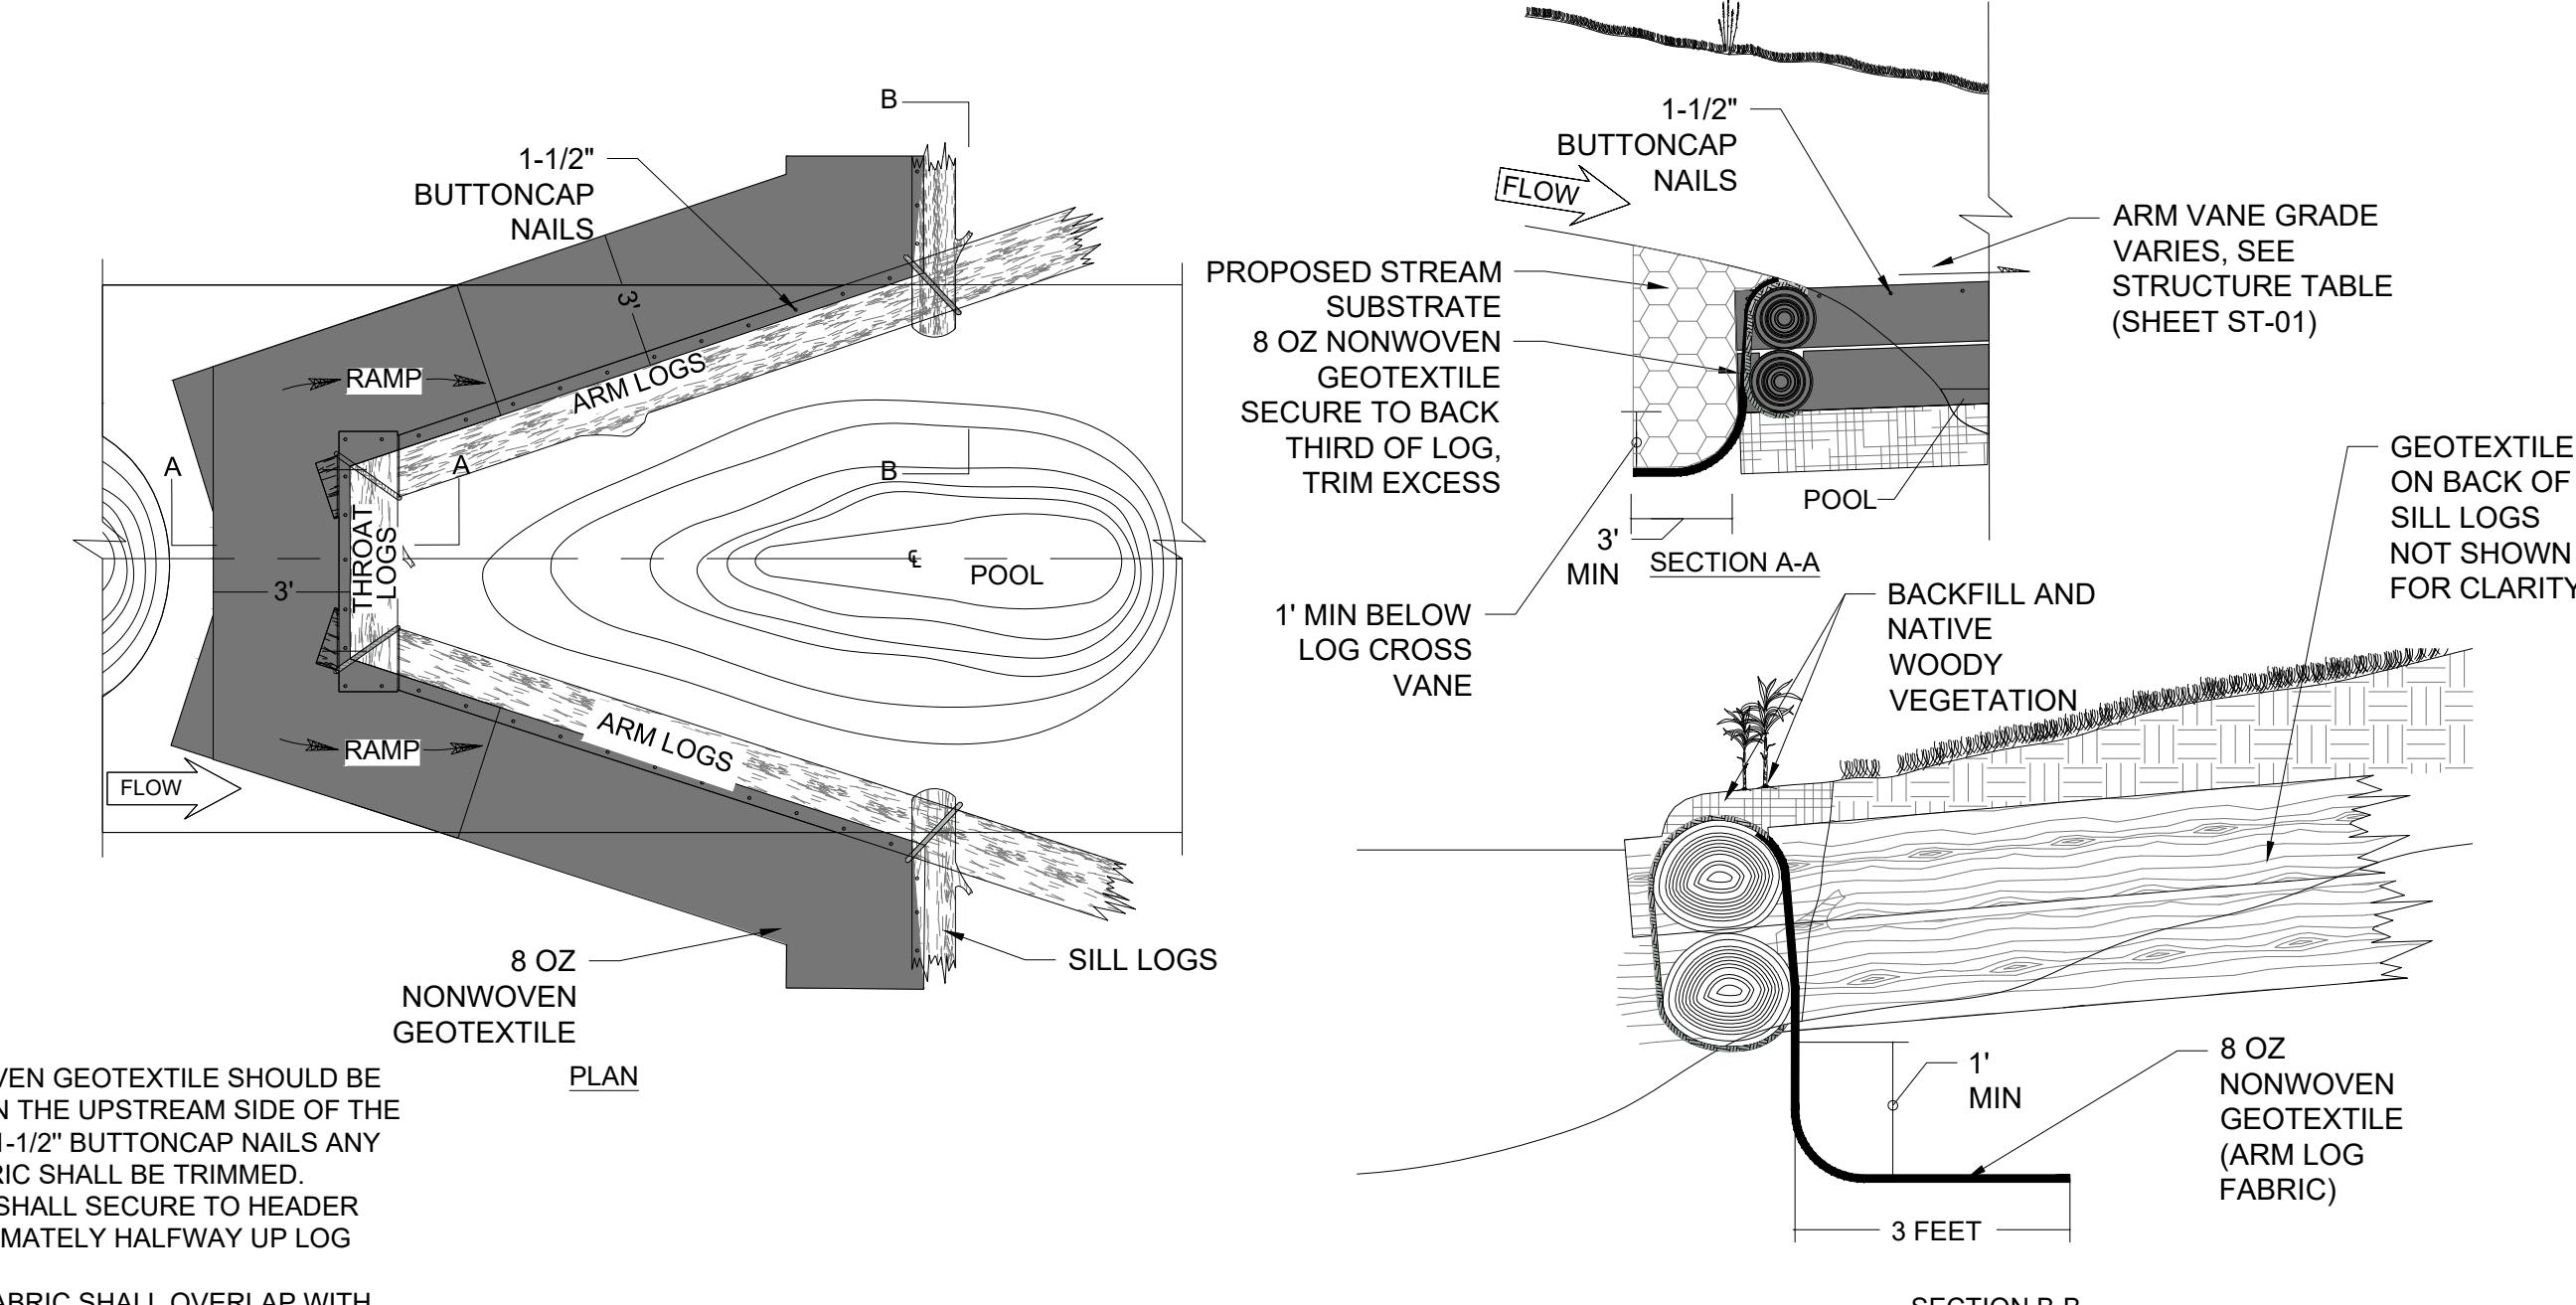

3 LOG CROSS VANE GEOTEXTILE DETAILS
DE-02 NOT TO SCALE

S/C PLAN # 59914	Revisions
GRA-004622-2025	
SIGN AND SEAL	
PROFESSIONAL CERTIFICATION	
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Drawn By : CA	
Designed By : CA	
Reviewed By : BWA	
Drawing No. DE-02 of DE-06	
Sheet No. 38 of 65	

HARFORD COUNTY, MARYLAND
EDGEWATER VILLAGE PARK
STREAM RESTORATION
STREAM RESTORATION DETAILS

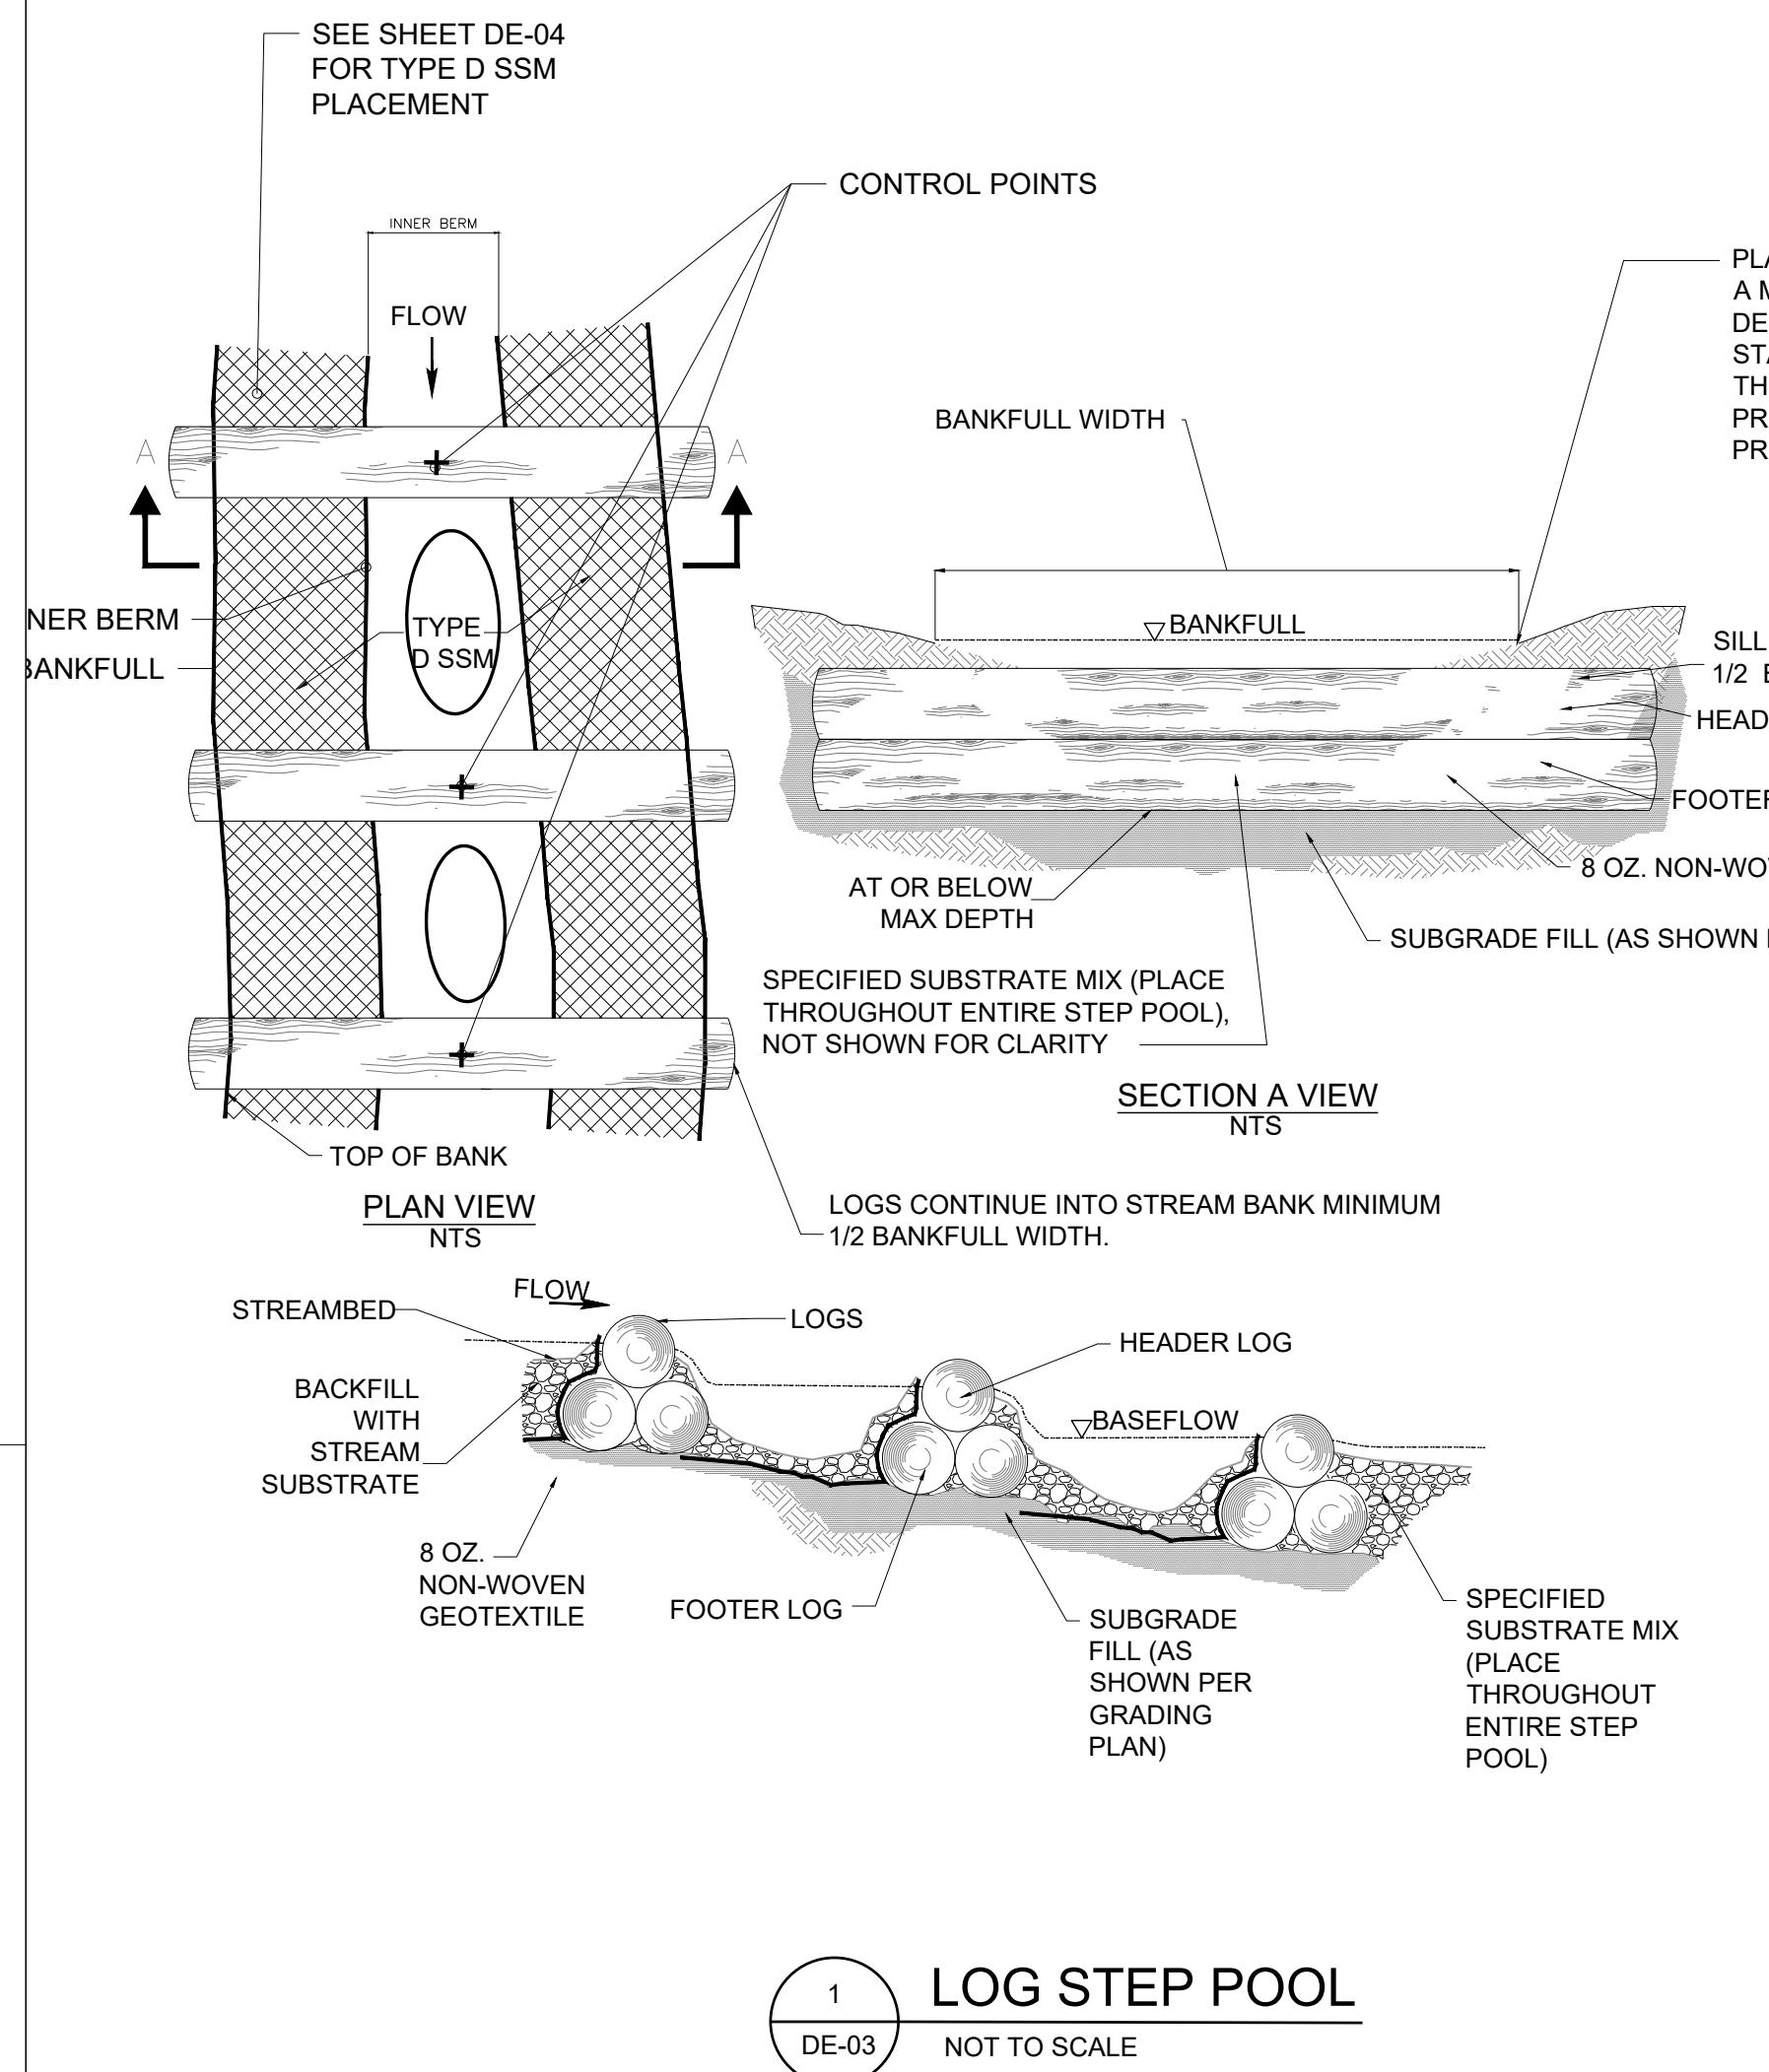


NOTE:

1. 8 OZ. NONWOVEN GEOTEXTILE SHOULD BE INSTALLED ON THE UPSTREAM SIDE OF THE LOGS USING 1-1/2" BUTTONCA
NAILS AND EXCESS FABRIC SHALL BE TRIMMED. GEOTEXTILE
SHALL SECURE TO HEADER LOG APPROXIMATELY HALFWAY
UP LOG BACKSIDE
2. SEE STRUCTURE TABLE ON SHEET ST-01 FOR LOCATION OF
CONTROL POINTS. CONTROL POINT ELEVATIONS ARE
MEASURED AT THE TOP OF THE HEADER LOG.

LOG STEP SIZING CHART			
	BANKFULL WIDTH (FEET)	MIN. SILL LENGTH ($\frac{1}{2}$ W _{BKF}) (FEET)	MIN. DIAMETER (INCHES)
REACH 1	10'	5'	12"
LT-1	10'	5'	12"
LT-2	8'	4'	12"

LOG STEP POOL


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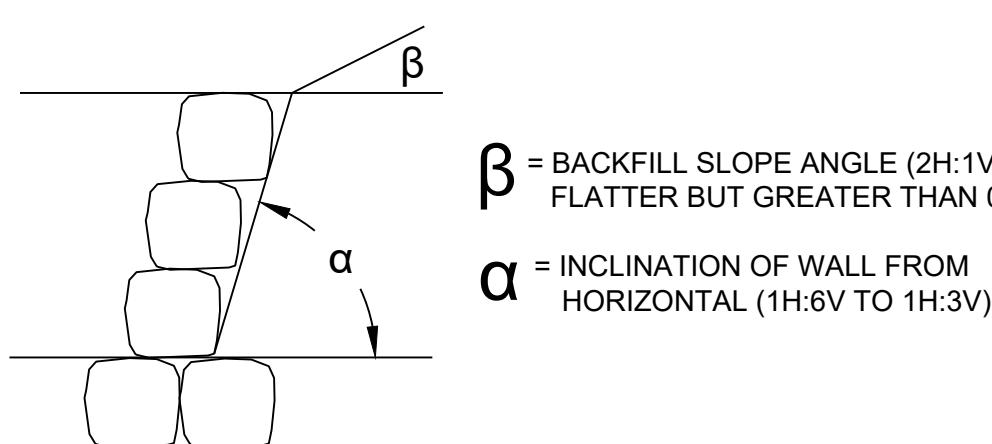
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2 7" COMBINATION CURB AND GUTTER
DE-03 NOT TO SCALE

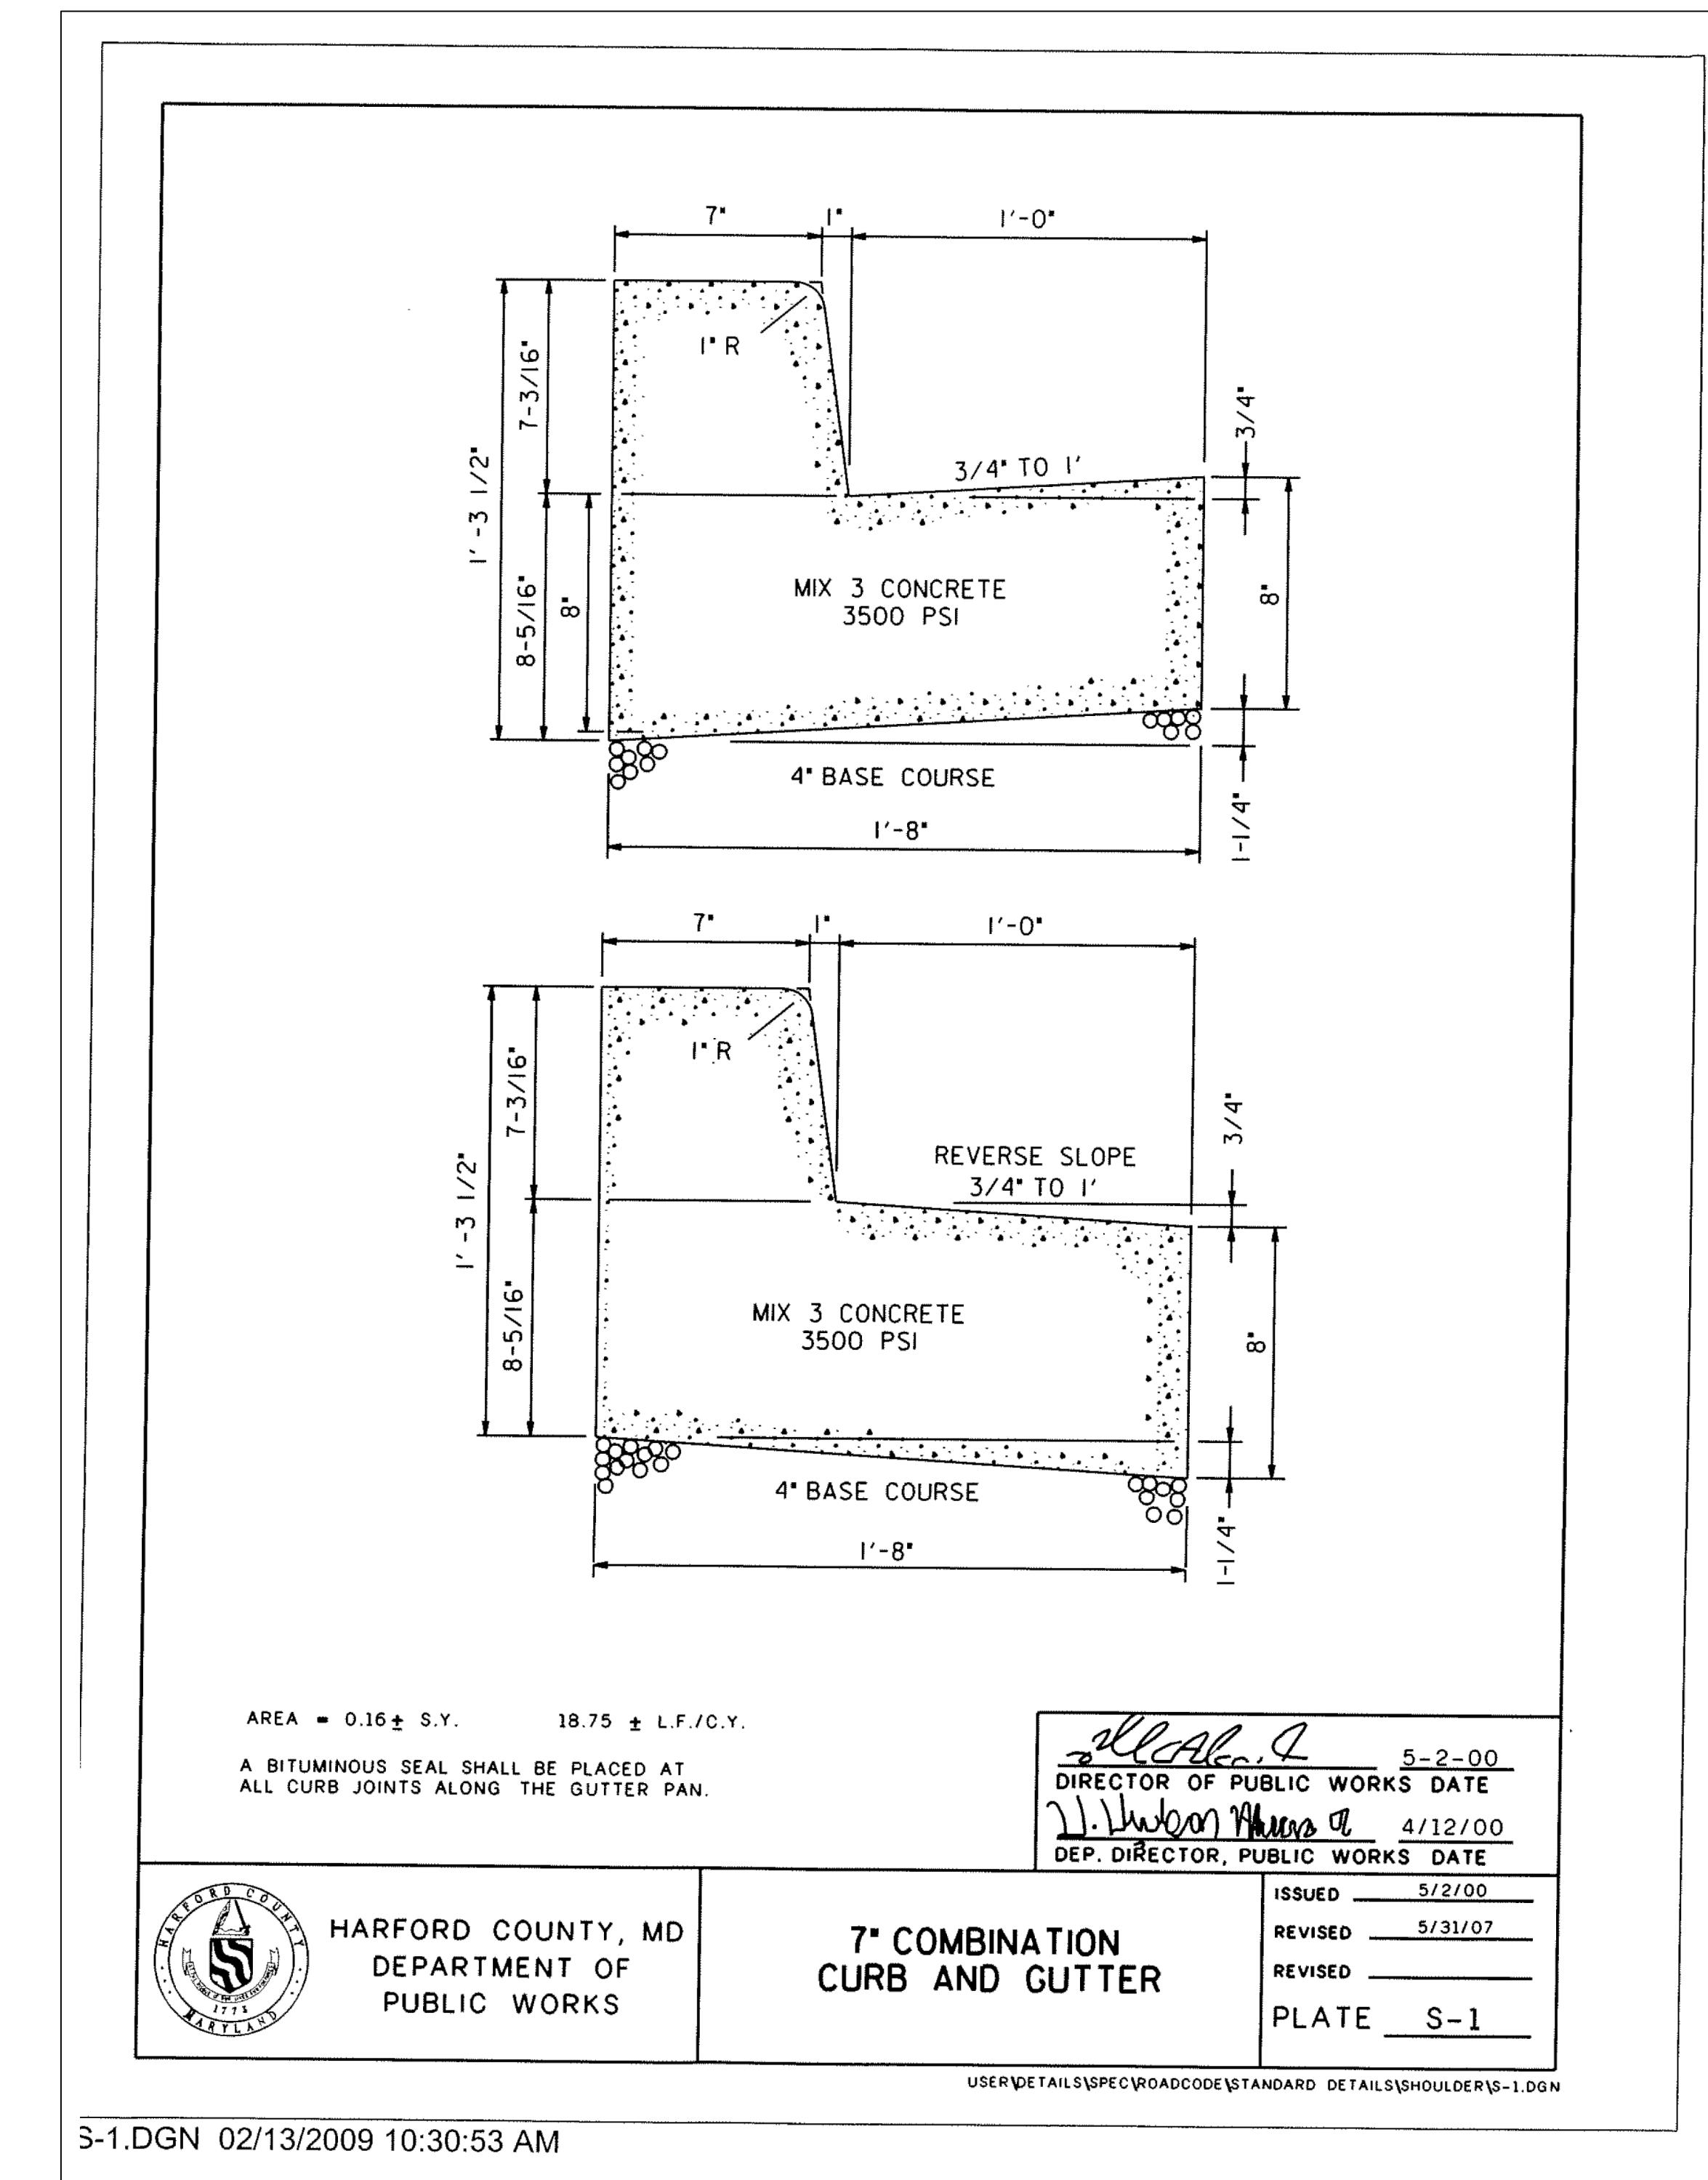		HARFORD COUNTY, MARYLAND		
S/C PLAN # 59914		Revisions	EDGEWATER VILLAGE PARK STREAM RESTORATION STREAM RESTORATION DETAILS	
GRA-004622-2025				
			Drawn By : CA	Scale : AS NOTED
			Designed By : CA	Date : SEPTEMBER 2025
			Reviewed By : BWA	
			Drawing No. DE-03 of DE-06	Sheet No. 39 of 65
SIGN AND SEAL				
<u>PROFESSIONAL CERTIFICATION</u>				
I HEREBY CERTIFY THAT THESE DOCUMENTS WERE PREPARED OR APPROVED BY ME, AND THAT I AM A DULY LICENSED PROFESSIONAL ENGINEER UNDER THE LAWS OF THE STATE OF MARYLAND. LICENSE NO. XXXXX, EXPIRATION DATE: XX/XX/XXXX.				



ROCK SIZING				
STRUCTURE	MINIMUM DENSITY (LB/CU FT)	LENGTH (FT)	WIDTH (FT)	HEIGHT (FT)
IMBRICATED ROCK	150	2.75 - 3.25	2.75 - 3.25	1.5 - 2.5

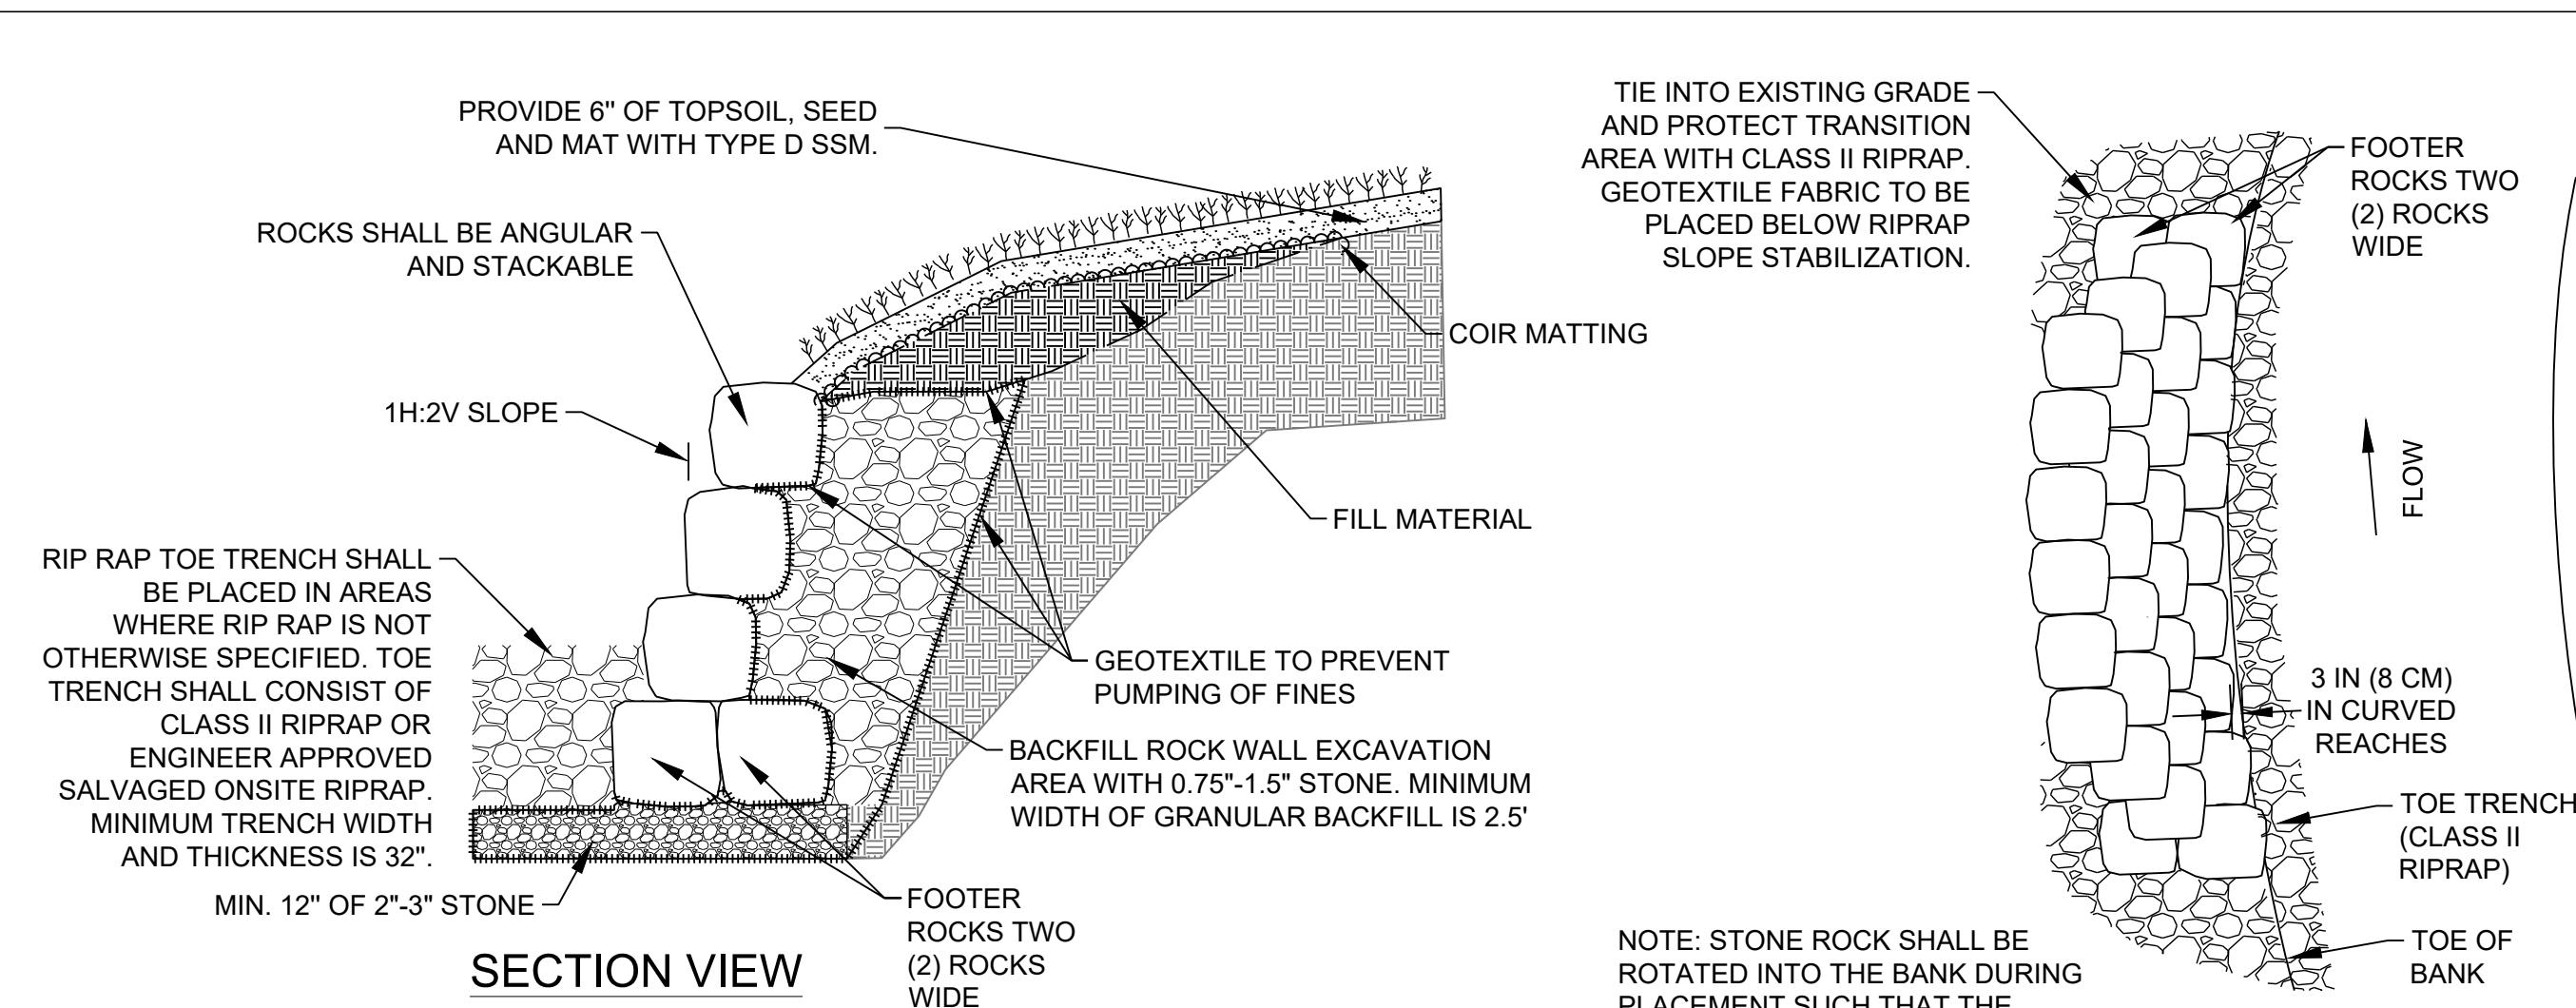

ADAPTED FROM MARYLAND'S
GUIDELINES TO WATERWAY
CONSTRUCTION


Imbricated Wall Geometry									
Reach	Centerline Station Start	Centerline Station End	Start Offset (FT)	End Offset (FT)	Top Elevation (FT)	Stream Channel Lowest Elevation (FT)	Footer Bottom Elevation (FT)	Total Height (FT)	Total Length (FT)
Reach 1	0+02.2	0+10.2	4	7.3	107.02	102.02	100.02	7	9.5
RT-1	0+5.53	0+13	1.7	4	107.2	103.2	101.2	6	9.5

NOTES:

- ALL EXCAVATION SHOULD BE MADE IN REASONABLY CLOSE CONFORMITY WITH THE EXISTING STREAM SLOPE AND BED. THE SLOPE OF THE CUT FACE SHOULD BE IN THE RANGE OF 1H:6V TO 2H:6V.
- COIR MATTING IS TO BE KEYED IN A MINIMUM OF 6" AT ENDS AND STAKED PER MANUFACTURER RECOMMENDATIONS.
- GEOTEXTILE IS TO BE PLACED BEHIND IMBRICATED ROCK WALL, ON THE FACE OF THE CUT SLOPE, BETWEEN GRANULAR BACKFILL MATERIAL AND IMPORTED SOIL, AND BELOW RIPRAP SLOPE STABILIZATION TO PREVENT PUMPING OF FINES. FABRIC SHALL BE SECURED IN PLACE BY STAKES OR PINS AS SPECIFIED BY MANUFACTURER INSTALLATION INSTRUCTIONS.
- AFTER GRANULAR BACKFILL MATERIAL (NO. 8 STONE) IS PLACED, IT SHOULD BE COVERED WITH A GEOTEXTILE FILTER LAYER AND THE REMAINING BANK SHALL BE FILLED AT A 2:1 MAX SLOPE WITH IMPORTED FILL MATERIAL UNTIL SPECIFIED SUBGRADE IS ACHIEVED. IMPORTED FILL MATERIAL SHALL CONSIST OF SUITABLE FILL, DESIGNATED AS MEETING THE REQUIREMENTS OF THE UNIFIED SOIL CLASSIFICATION SYSTEM
- TYPES SW, GW, GC, SC, SM, ML, CL, OR AS DESIGNATED IN THE CONSTRUCTION SPECIFICATIONS. FILL MATERIAL SHALL BE FREE OF ROOTS, PLANTS, STONES, CLAY LUMPS, AND OTHER EXTRANEous MATERIAL.
- #1 STONE BASE IS NOT PLACED IF BEDROCK IS ENCOUNTERED.
- NUMBER OF STONES IN IMBRICATED ROCK WALL IS VARIABLE AND NOT DRAWN TO SCALE. ACTUAL NUMBER OF ROCKS TO ACHIEVE GRADE MAY VARY DEPENDING ON SIZE.
- ANY LOCALIZED SOFT OR UNSUITABLE EXISTING FILL MATERIAL AT THE FOOTING SUBGRADES SHOULD BE REMOVED AND REPLACED WITH NEW COMPACTED STRUCTURAL FILL, CRUSHED STONE, OR CONCRETE. BRIDGING OVER SOFT AND YIELDING SOILS WITH GEOTEXTILE AND CRUSHED STONE MAY ALSO BE NECESSARY IN SOME AREAS OF THE SITE. THE UNDERCUT DEPTH AND CRUSHED STONE THICKNESS WILL DEPEND ON THE SOIL CONDITIONS ENCOUNTERED, AND SHOULD BE VERIFIED AND APPROVED BY THE PROJECT ENGINEER AND/OR CITY DURING CONSTRUCTION.
- SEE TECHNICAL SPECIFICATIONS FOR PRODUCT SPECIFICATIONS AND INSTALLATION INSTRUCTIONS.
- ALL IMBRICATED ROCK SHALL HAVE 2 FLAT SIDES EXCEPT FOR THE TOP ROCK WHICH SHALL HAVE A MINIMUM OF 1 FLAT SIDE.


IMBRICATED RIP RAP WALL

NOT TO SCALE


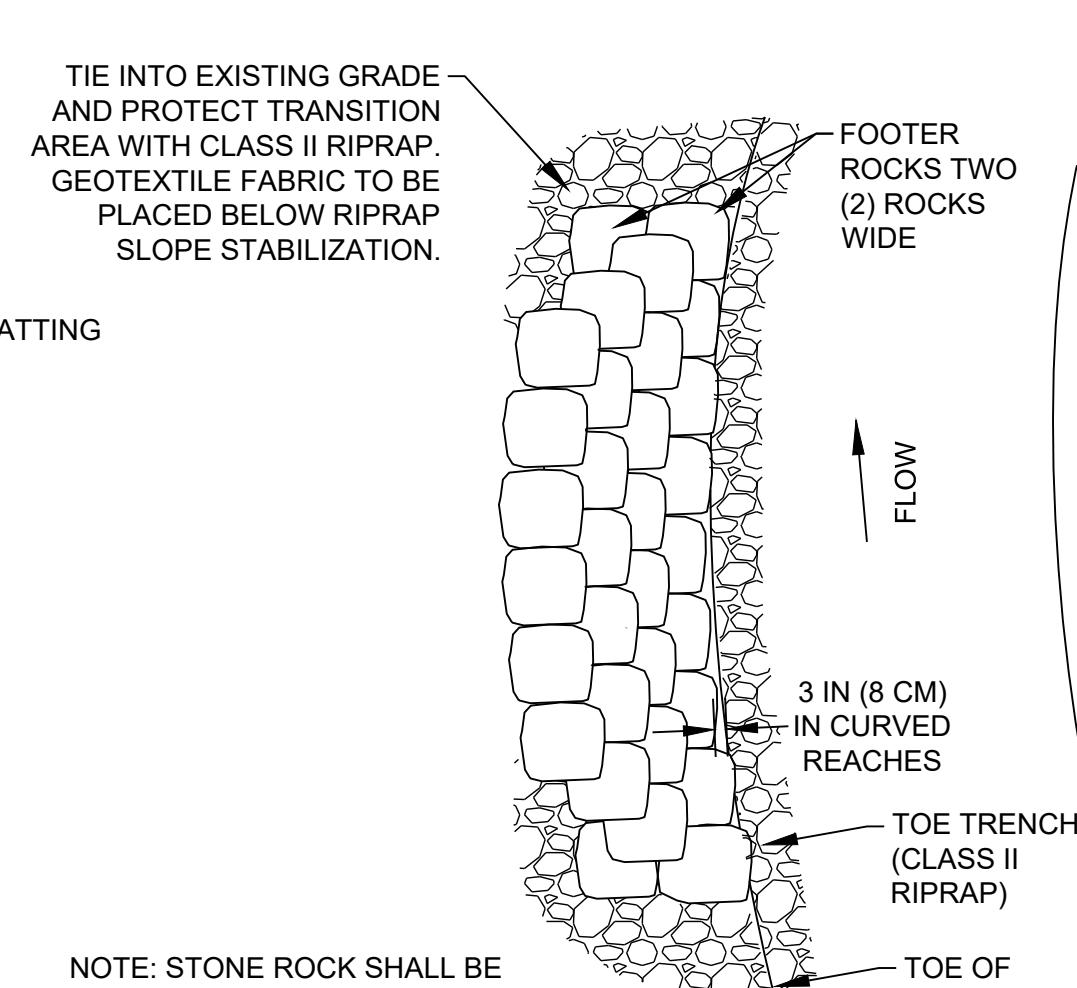


SECTION VIEW
NOT TO SCALE

PLAN VIEW
NOT TO SCALE

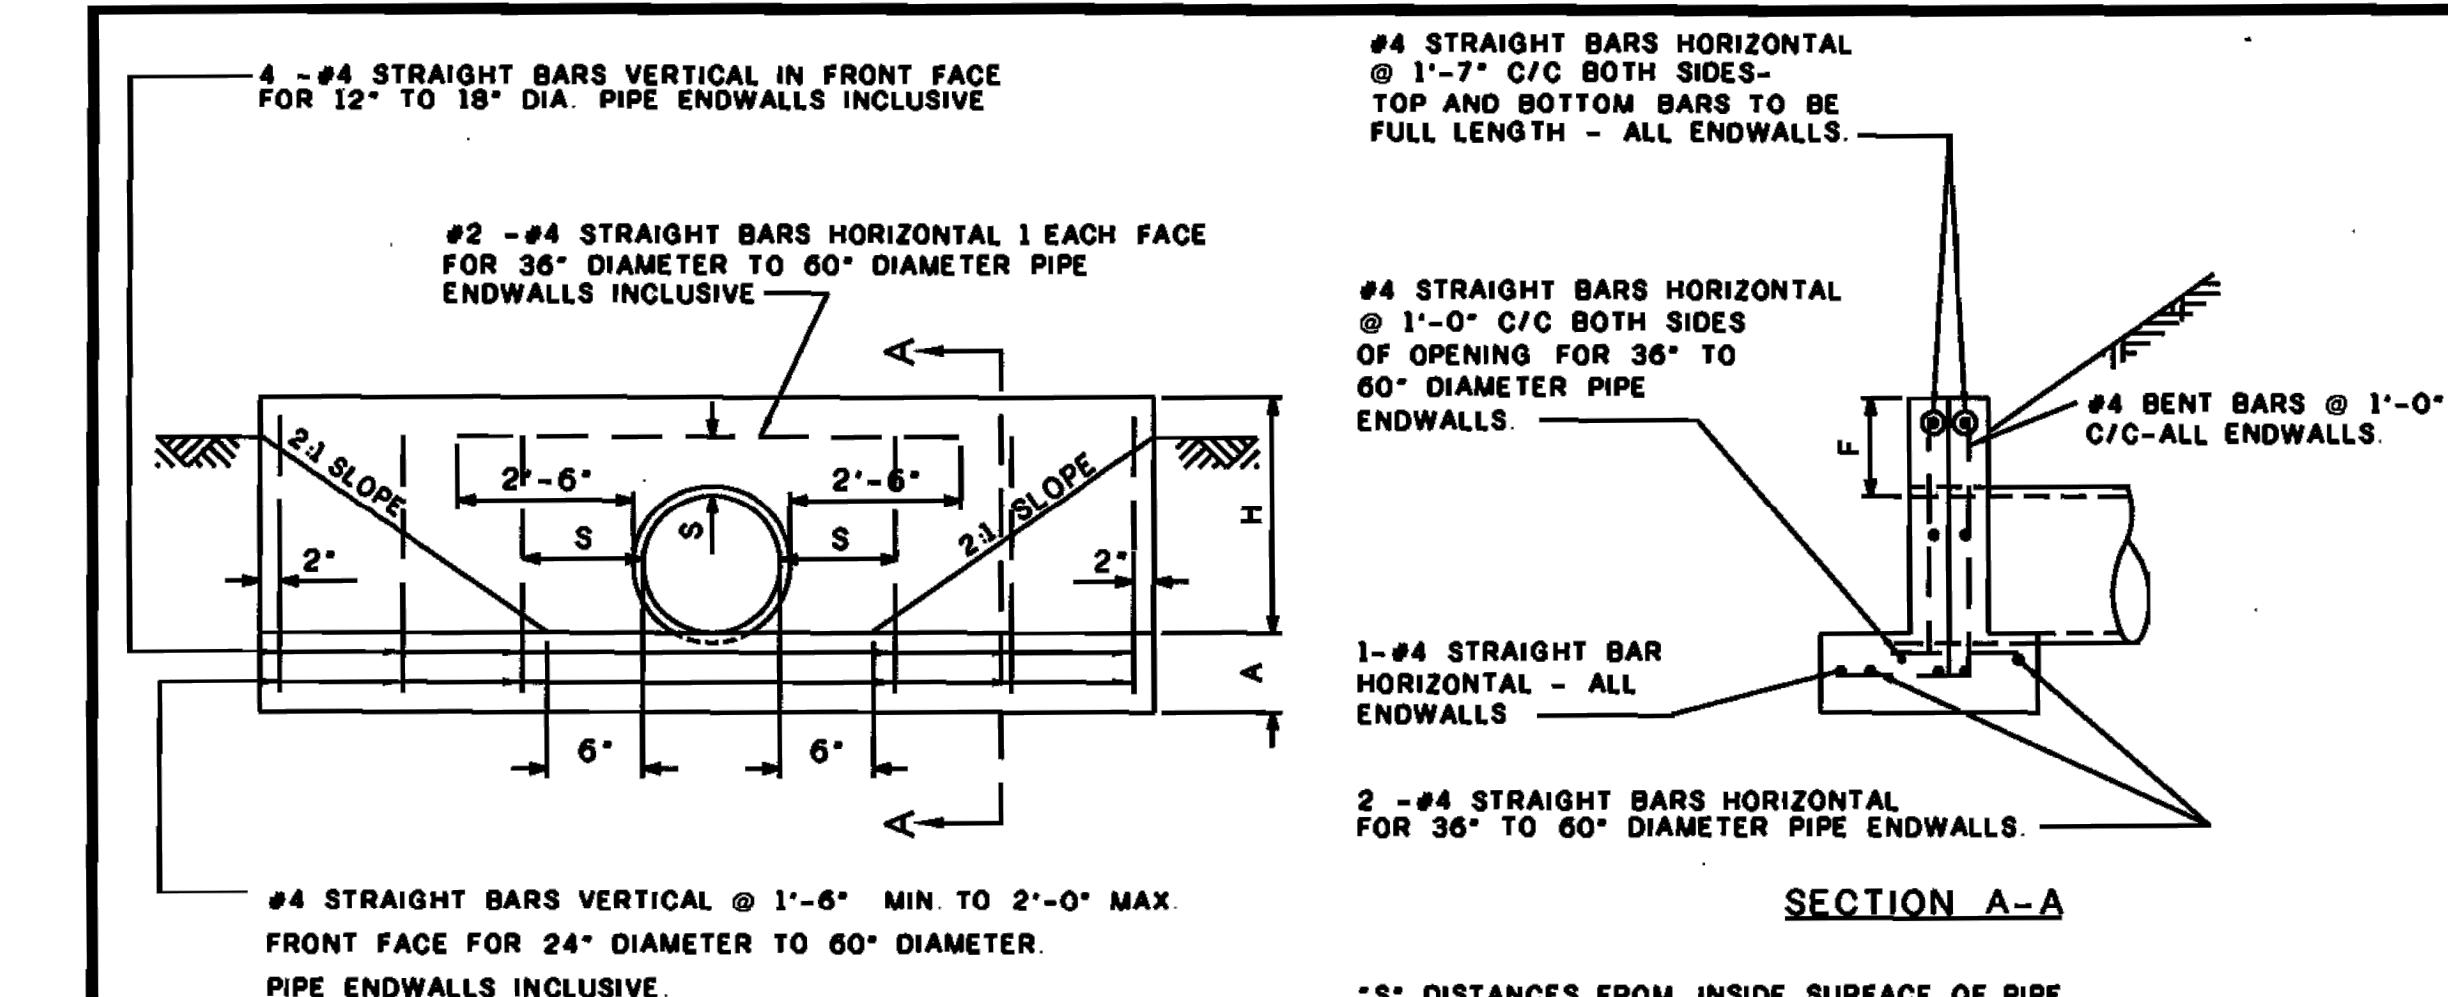

ELEVATION

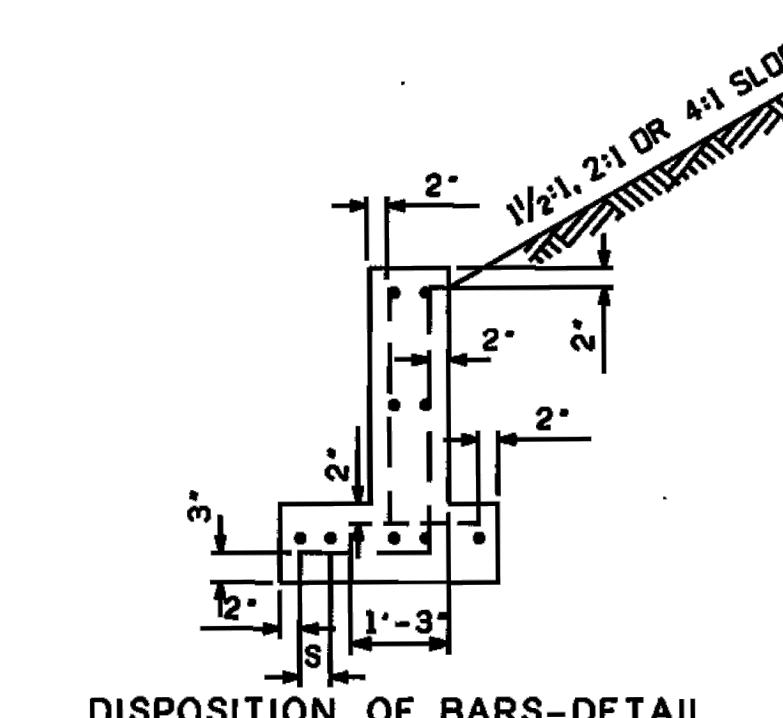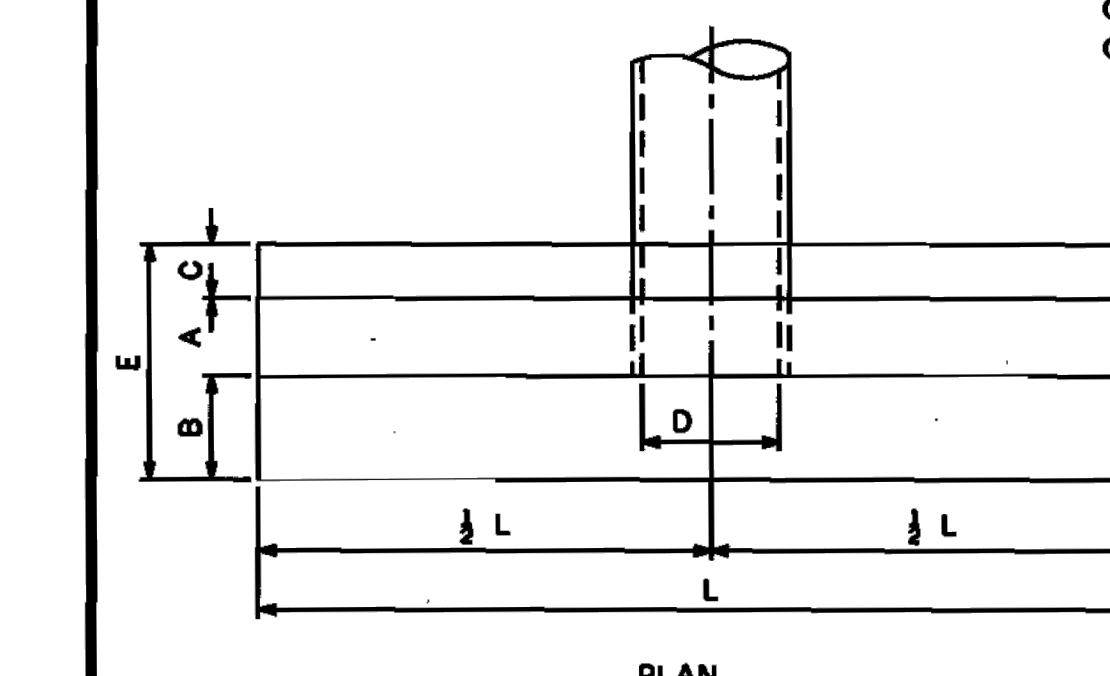

DISPOSITION OF BARS-DETAIL

QUANTITIES IN TABLE TO BE USED FOR EST. ONLY										
OPENINGS		DIMENSIONS							VOLUME	STEEL
D	AREA	A	B	C	E	F	H	L	CONC. C.Y.	LBS.
12	0.79	9"	6"	6"	1'-9"	9"	1'-9"	6"-6"	0.61	38
15	1.23	9"	6"	6"	1'-9"	9"	2'-0"	7"-9"	0.78	55
18	1.78	9"	6"	6"	1'-9"	9"	2'-3"	9"-0"	0.95	62
24	3.14	9"	14"	6"	2'-5"	9"	2'-9"	11"-6"	1.56	91
30	4.91	9"	14"	6"	2'-5"	12"	3"-6"	14"-2"	2.19	136
36	7.07	12"	16"	10"	3"-2"	12"	4"-0"	16"-8"	4.18	222
42	9.62	12"	16"	10"	3"-2"	12"	4"-6"	19"-2"	5.13	265
48	12.57	12"	16"	10"	3"-2"	12"	5"-0"	21"-2"	6.12	326
54	15.90	12"	20"	12"	3"-8"	12"	5"-6"	24"-2"	7.68	384
60	19.64	12"	20"	12"	3"-8"	12"	6"-0"	26"-8"	8.86	428

LL/Cal J 05.02.00
DIRECTOR OF PUBLIC WORKS DATE
J. J. Huber, AIA, PE 04.12.00
DEP. DIRECTOR, PUBLIC WORKS DATE




HARFORD COUNTY, MD
DEPARTMENT OF
PUBLIC WORKS

STANDARD TYPE 'C' ENDWALL
ROUND PIPE

ISSUED 05.02.00
REVISED _____
REVISED _____
PLATE D-11

S/C PLAN # 59914	Revisions	EDGEWATER VILLAGE PARK STREAM RESTORATION STREAM RESTORATION DETAILS		
GRA-004622-2025				
SIGN AND SEAL				
PROFESSIONAL CERTIFICATION		Drown By : CA Designed By : CA Reviewed By : BWA		
I HEREBY CERTIFY THAT THESE DOCUMENTS WERE PREPARED OR APPROVED BY ME, AND THAT I AM A DULY LICENSED PROFESSIONAL ENGINEER UNDER THE LAWS OF THE STATE OF MARYLAND LICENSE NO. XXXXX, EXPIRATION DATE: XX/XX/XXXX.		Drawing No. DE-04 of DE-06 Sheet No. 40 of 65		

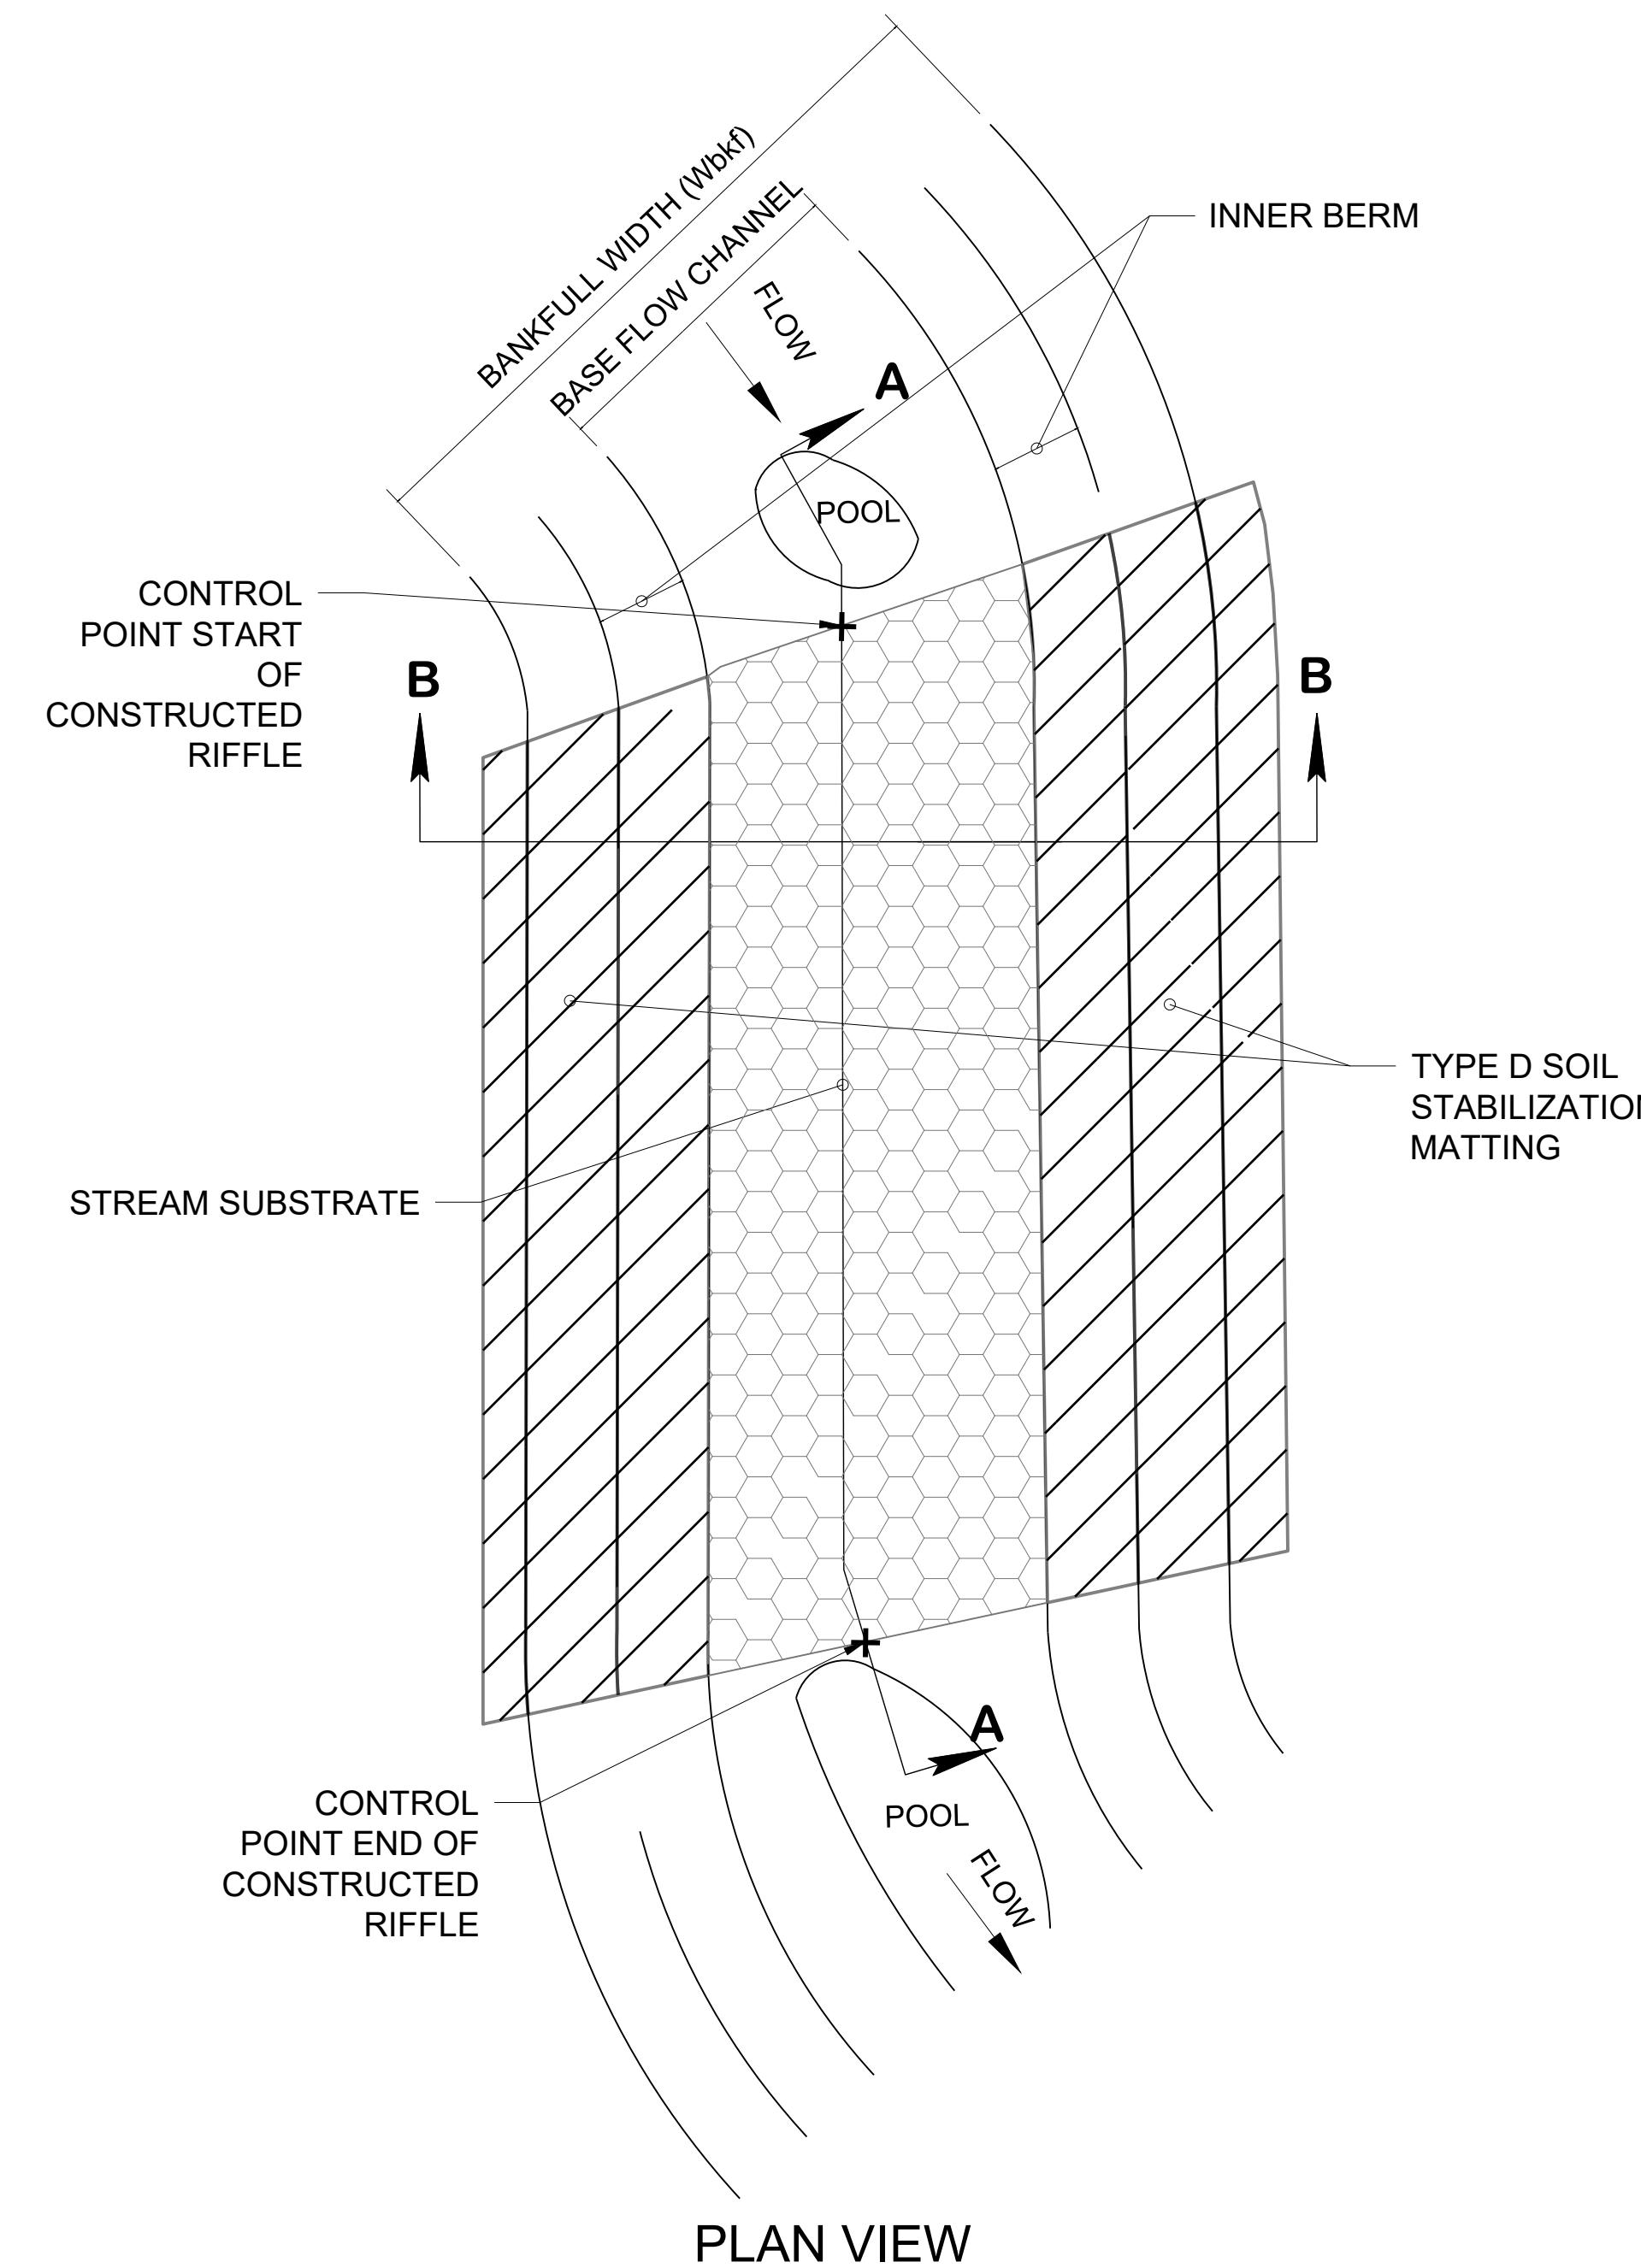

1
DE-04

CONSTRUCTED RIFFLE

NOT TO SCALE

STREAM SUBSTRATE SPECIFICATIONS					
REACH	D50 (IN.)	% CLASS 0 RIPRAP	% CLASS 1 RIPRAP	% CLASS 2 RIPRAP	PLACEMENT DEPTH (FT)
MAINSTEM (REACH 1, 2A, 2B)	11.7	10%	50%	40%	2.0
REACH 3	11.7	10%	50%	40%	2.0
TRIBUTARIES (RT1, LT1, LT2)	8.5	25%	75%	0%	2.0


STREAM SUBSTRATE NOTES

STREAM SUBSTRATE UTILIZED IN THE BED OF THE STREAM WITHIN THE RIFFLE/RUN/GLIDE TRANSITIONS TO PROVIDE A STABLE SUBSTRATE OR FILL AREA. REACHES CLASSIFIED AS STEP-POOLS WILL RECEIVE THE STREAM SUBSTRATE BED IN THE RIFFLE/RUN/POOL/GLIDE TRANSITIONS TO PROVIDE A STABLE SUBSTRATE OR FILL AREA.


THE STREAM SUBSTRATE MUST MEET THE MATERIAL SPECIFICATIONS PROVIDED IN THE TABLE.

NOTES:

1. STREAM SUBSTRATE FOR EACH STREAM REACH SHALL CONTAIN THE PERCENTAGE BY VOLUME OF THE MATERIALS SPECIFIED IN THE TABLES.
2. STREAM SUBSTRATE WILL BE NATURAL IN COLOR (WHITE, BROWN, YELLOW, TAN OR GRAY).
3. STREAM SUBSTRATE SHALL BE FREE OF IMPURITIES AND CONTAMINANTS.
4. STREAM SUBSTRATE SHALL BE NATURAL AND FREE OF SLAG.
5. SIZING IS BASED ON THE INTERMEDIATE B-AXIS OF THE ROCK.
6. FOR MIN. THICKNESS DEPTHS GREATER THAN 1.5 FEET THE BED SHOULD BE PLACED IN LIFTS NO GREATER THAN 12 INCHES. THE CONTRACTOR SHALL INSPECT THE INSTALLATION OF STREAM SUBSTRATE TO ENSURE THE PLACEMENT IS INSTALLED AS HOMOGENEOUS AS POSSIBLE AND VISUALLY FREE OF LARGE VOIDS.
7. ADDITIONAL AVAILABLE ON SITE SALVAGEABLE STREAM BED MATERIAL SHOULD BE BLENDED INTO THE PROPOSED STREAM SUBSTRATE TO FILL Voids.
8. REFER TO THE GRADING PLAN AND PROFILE FOR THE LIMITS OF PLACEMENT OF THE STREAM SUBSTRATE.

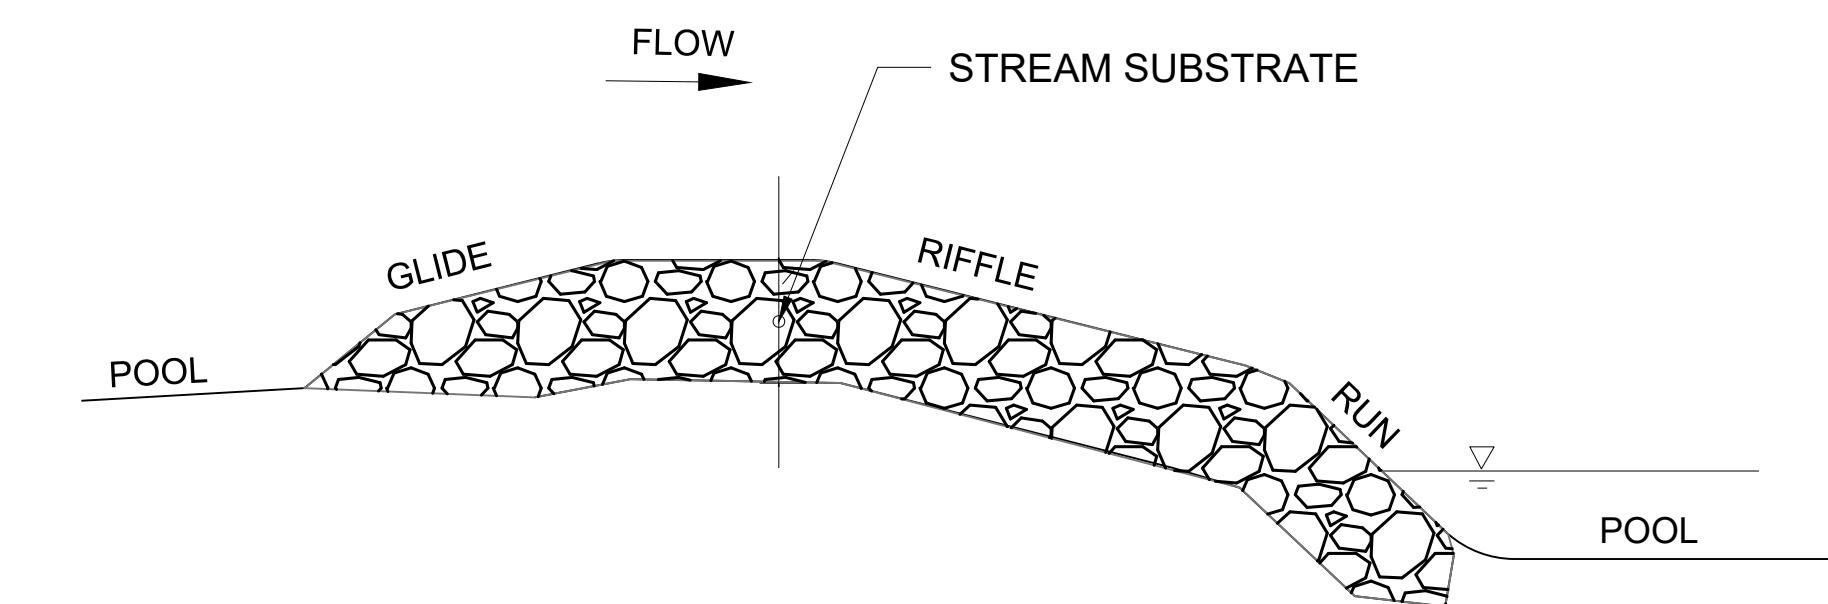

SECTION A-A

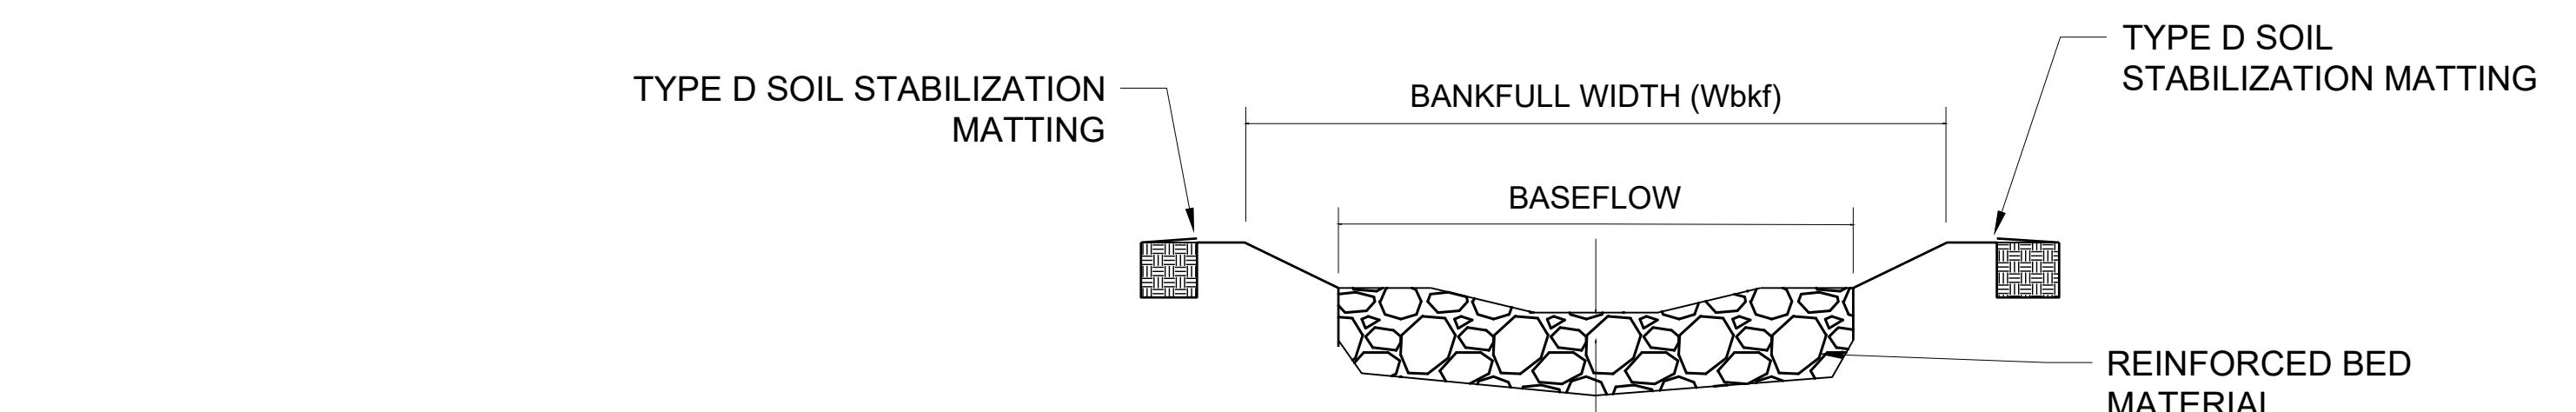

SECTION B-B

S/C PLAN # 59914		Revisions	HARFORD COUNTY, MARYLAND		
GRA-004622-2025		SIGN AND SEAL	EDGEMARSH VILLAGE PARK STREAM RESTORATION		
			STREAM RESTORATION DETAILS		
			Drawn By : _____ CA	Scale : _____ AS NOTED	
			Designed By : _____ CA	Date : SEPTEMBER 2025	
		Reviewed By : _____ BWA			
		Drawing No. DE-05 of DE-06	Sheet No. _____		

PROFESSIONAL CERTIFICATION

I HEREBY CERTIFY THAT THESE DOCUMENTS WERE PREPARED OR APPROVED BY ME, AND THAT I AM A DULY LICENSED PROFESSIONAL ENGINEER UNDER THE LAWS OF THE STATE OF MARYLAND. LICENSE NO. XXXXX, EXPIRATION DATE: XX/XX/XXXX.

SEQUENCE OF CONSTRUCTION

PROJECT INITIATION

- THE CONTRACTOR SHALL OBTAIN ALL REQUIRED PERMITS FROM THE COUNTY AND CONDUCT REQUIRED PRE-CONSTRUCTION MEETINGS AS OUTLINED IN THE CONSTRUCTION SPECIFICATIONS PRIOR TO COMMENCING CONSTRUCTION.
- THE CONTRACTOR SHALL NOTIFY THE PROJECT ENGINEER A MINIMUM OF ONE (1) WEEK PRIOR TO COMMENCING ANY LAND DISTURBING ACTIVITIES FOR VERIFICATION THEY ARE IN ACCORDANCE WITH THE APPROVED PERMITS.
- CONTRACTOR TO FIELD MARK LIMIT OF DISTURBANCE AND TREE PROTECTION FENCING PRIOR TO ANY CLEARING, GRADING, SETTING UP OF STAGING AREA, MARKING STOCKPILE, OR ANY SEDIMENT CONTROL MEASURE INSTALLATION. ONCE ALL TREE PROTECTION DEVICES HAVE BEEN INSTALLED, THE APPLICANT SHALL CONTACT THE COUNTY AND SCHEDULE AN INSPECTION OF THE FOREST PROTECTION DEVICES. A STAFF MEMBER OF THE COUNTY SHALL INSPECT AND APPROVE THE INSTALLATION OF ALL PROTECTION DEVICES BEFORE ANY GRADING ACTIVITIES SHALL BE PERMITTED.
- PLACE CONSTRUCTION CLOSURE AND MAINTENANCE OF TRAFFIC SIGNS AS INDICATED ON THE PLANS TO PREVENT SITE ACCESS DURING ACTIVE CONSTRUCTION.
- THE CONTRACTOR SHALL INSTALL THE EROSION AND SEDIMENT CONTROL MEASURES AND NOTIFY THE PROJECT ENGINEER OF THE COMPLETED INSTALLATION. LIMITED CONSTRUCTION ACCESS ROUTES ARE SPECIFIED ON THE CONSTRUCTION DRAWINGS. ALTERNATIVES OR DEVIATIONS SHALL BE APPROVED BY THE PROJECT ENGINEER AND OWNER PRIOR TO THE COMMENCEMENT OF CONSTRUCTION. CONTRACTOR PROPOSED ALTERNATIVES WITH DELINEATION OF ENTRANCE LOCATIONS AND ACCESS PATHS SHALL BE INCLUDED IN THE PROPOSED WORKFLOW PLAN. DEVIATIONS FROM THE PROVIDED ACCESS ROUTES WILL REQUIRE WRITTEN AGREEMENT WITH THE PROPERTY OWNER.
- THE PROJECT ENGINEER SHALL PROVIDE THE NPDES INSPECTOR 48-HOUR NOTIFICATION TO SCHEDULE AN ONSITE PRE-CONSTRUCTION MEETING TO INSPECT THE INSTALLATION OF EROSION AND SEDIMENT MEASURES, PRIOR TO LAND DISTURBANCE.

BEGIN PHASE 1

- BEGIN CLEARING AND GRUBBING WITHIN THE LOD NECESSARY TO BEGIN CONSTRUCTION OF THE PROJECT AREA FOR TEMPORARY ACCESS ROADS AND STABILIZED CONSTRUCTION ENTRANCES AND STOCKPILE LOCATIONS. ALL TREES THAT MEET THE SPECIFICATIONS FOR IN-STREAM STRUCTURE SALVAGED LOGS SHALL BE STORED OFF THE GROUND TO BE USED FOR FUTURE STREAM RESTORATION STRUCTURES. ALL RIP RAP THAT MEETS SPECIFICATIONS FOR IN STREAM USE SHALL BE STORED ON SITE FOR REUSE.
- DUE TO THE ENVIRONMENTALLY SENSITIVE NATURE OF THE SITE AND EXISTING UTILITIES WITHIN THE LOD ALL TEMPORARY ACCESS ROADS SHALL UTILIZE GROUND PROTECTION MEASURES FOR THE ENTIRE LENGTH OF ROAD. MINIMUM GROUND PROTECTION MEASURES REQUIRED FOR LOW SLOPED AREAS INCLUDE LAMINATED DECK MATS. THE CONTRACTOR MAY COVER MATS WITH A THIN LAYER OF MULCH TO PROTECT MATS AND REDUCE THE RISK OF DAMAGE. IN AREAS OF STEEP SLOPES THAT EXCEED 15% SLOPE ALONG THE PROPOSED TEMPORARY ACCESS ROAD THE GROUND PROTECTION SHOULD INCLUDE INSTALLATION OF CRUSHED AGGREGATE WITH A GEOTEXTILE UNDERLAYERMENT.
- CONSTRUCT NEW SANITARY SEWER UPGRADES PER EDGEWATER VILLAGE SANITARY SEWER REPLACEMENT PLANS.
- CONTRACTOR SHALL SUPPLY AND MAINTAIN AN ONSITE CONCRETE WASHOUT STRUCTURE WHICH SHALL BE ON SITE AND AVAILABLE DURING ALL CONCRETE RELATED WORK ACTIVITIES.
- PROPERLY ENCASE THE SEWER IN CONCRETE PER THE

UTILITY PROTECTION DETAIL.

- TEMPORARILY STABILIZE AREA IMPACTED BY SEWER REPLACEMENT.

BEGIN PHASE 2

- PHASE 2 WORK CAN BEGIN IN CONJUNCTION WITH PHASE 1
- HARVEST AND STOCKPILE SUITABLE FILL MATERIAL AS NEEDED FROM STATION 6+50 - 8+00. TEMPORARILY STABILIZE AREA. ANY TEMPORARY SITE SHALL BE STABILIZED AT A MAXIMUM 3H:1V SLOPE.
- THE CONTRACTOR SHALL CONSTRUCT THE STREAM IN MAXIMUM 150-FOOT DAILY WORK ZONES, THAT CAN BE COMPLETED IN ONE DAY, TO MINIMIZE THE POTENTIAL OF UNNECESSARY OPEN AND UNSTABLE GROUND AT ANY POINT DURING CONSTRUCTION.
- BASED ON A 3-DAY DRY WEATHER FORECAST, PLACE TEMPORARY SANDBAG DIVERSION AT THE UPSTREAM AND DOWNSTREAM ENDS OF THE WORK AREA, AS INDICATED ON THE PLANS. WHERE INDICATED, STREAM FLOW SHOULD BE PUMPED AROUND THE WORK AREA AND THE PUMP SHOULD BE DISCHARGED ONTO A STABLE VELOCITY DISSIPATOR MADE OF RIPRAP OR SANDBAGS.
- INSTALL DEWATERING PUMP AROUND PRACTICE FOR THE DAILY WORK ZONE AS SHOWN IN THE EROSION & SEDIMENT CONTROL PLANS.
- WATER FROM THE WORK AREA SHOULD BE PUMPED TO A SEDIMENT FILTERING DEVICE, SUCH AS A DEWATERING BASIN, FILTER BAG, OR OTHER APPROVED SOURCE. THE MEASURE SHOULD BE LOCATED SUCH THAT THE WATER DRAINS INTO THE EXISTING CHANNEL. APPROXIMATE LOCATIONS FOR DEWATERING MEASURES ARE INDICATED ON THE PLANS AND THE CONTRACTOR IS RESPONSIBLE FOR ADJUSTING THE LOCATION AS NEEDED TO ENSURE THE WORK AREA IS MAINTAINED IN DRY CONDITION.
- THE CONTRACTOR STAKEOUT SHALL INCLUDE AT MINIMUM PROPOSED CENTERLINE, POINT OF CURVATURE (PC), POINT OF TANGENCY (PT), IN-STREAM STRUCTURE LOCATIONS, AND LOCATIONS OF INVERTS FOR RIFFLE, RUN, POOL, AND GLIDE FEATURES AS APPROPRIATE.
- THE CONTRACTOR SHALL BEGIN ALL INSTREAM STREAM RESTORATION WORK STARTING UPSTREAM AND PROCEED DOWNSTREAM, UNLESS OTHERWISE SPECIFIED OR APPROVED BY THE PROJECT ENGINEER.
- COMMENCE ROUGH CHANNEL GRADING UNTIL EITHER THE STATION OF A PROPOSED IN-STREAM STRUCTURE (AS NOTED ON THE STRUCTURE TABLES IN THE PLANS) OR THE LIMITS OF THE DAILY WORK ZONE ARE REACHED. PROCEED WITH INSTALLATION OF THE IN-STREAM STRUCTURE PER THE STRUCTURE SPECIFICATIONS AND AS SHOWN IN THE PLAN DETAILS.
- FINALIZE THE FLOODPLAIN GRADING WITHIN THE MAXIMUM 150-FOOT DAILY WORK ZONES. AT NO TIME MAY THE STREAM OR FLOODPLAIN CONSTRUCTION OR STABILIZATION BE MORE THAN 2 DAILY WORK ZONES BEHIND SYNC.
- FINALIZE GRADING, EXCAVATE TRENCH, AND PROPERLY INSTALL COIR MATTING ON STREAM BANK TOE OF SLOPE. ADD SPECIFIED STREAM SUBSTRATE MIX FOR CHANNEL BOTTOM TO SPECIFIED DEPTH FOR ALL ROUGH GRADED AREAS TO BRING THE CHANNEL TO FINAL GRADE.
- ONCE FINAL GRADING HAS BEEN ACHIEVED, APPLY TEMPORARY SEEDING, PERMANENT SEEDING, AND MULCH PRIOR TO FINALIZING INSTALLATION OF COIR MATTING BY SECURING WITH STAKES AND KEYING IN FABRIC PER MANUFACTURER RECOMMENDATIONS AND AS SHOWN IN THE PLANS.
- CONTINUE STREAM GRADING AND STRUCTURE INSTALLATION UNTIL ALL GRADING AND IN-STREAM STRUCTURES ARE INSTALLED. IF BEDROCK CONDITIONS ARE ENCOUNTERED WITHIN THE WORK AREA DURING CONSTRUCTION, CONSULT THE OWNER AND PROJECT ENGINEER FOR INVERT ELEVATION ADJUSTMENTS.
- STREAM GRADING AND STRUCTURE CONSTRUCTION SHALL PROCEED AS FOLLOWS:
 - MAINSTEM STA 0+00 - 0+32

II. RT-1 STA 500+00-500+31

III. MAINSTEM STA 0+32-2+31

IV. INSTALL ARMORED UTILITY PROTECTION WITH PIPE ENCASEMENT FROM STATION 2+31-2+50

V. LT-1 HEADWALL - INSTALL FORMWORK, REBAR, AND POUR CONCRETE FOR PROPOSED HEADWALL AS SHOWN ON THE PLANS

VI. LT-1 STA 100+00 - 100+91

VII. MAINSTEM STATION 2+55 - 5+84

IV. INSTALL ARMORED UTILITY PROTECTION WITHOUT PIPE ENCASEMENT FROM STATION 5+84-5+98

IX. MAINSTEM STATION 5+98- 7+46

IV. DEMOLISH AND REMOVE 20 LINEAR FEET OF STORM DRAIN AT APPROXIMATELY STA 6+00.

X. CAP UPSTREAM AND DOWNSTREAM END OF REMAINING STORM DRAIN.

X. LT-2 STA 300+00- 300+75.

XI. MAINSTEM STA 7+46-9+20

XII. CONSTRUCT PLUNGE POOL 4

XIJ. REACH 3 STATION 400+30- 402+13.87

PROJECT CLOSEOUT

25. AS THE WORK FOR EACH REACH COMPLETED, E&SC MEASURES CAN BE REMOVED WITH APPROVAL FROM PROJECT OWNER, ENGINEER, AND THE EROSION AND SEDIMENT CONTROL INSPECTOR.

26. ONCE CONSTRUCTION OF PROJECT AREA HAS BEEN COMPLETED, THE CONTRACTOR SHALL PROCEED WITH ARRANGEMENT OF COMPOSING APPROVED RECORD DRAWINGS. CONTRACTOR SHALL FIELD SURVEY ALL INSTALLED WORK. FORWARD THE ELECTRONIC SURVEY TO THE PROJECT ENGINEER FOR VERIFICATION THAT THE PROJECT HAS BEEN CONSTRUCTED IN ACCORDANCE WITH THE PLAN. ELECTRONIC COPY OF THE SURVEY MUST BE ACCOMPANIED BY A HARD COPY OF RECORD DRAWINGS SIGNED AND SEALED BY A MARYLAND REGISTERED LAND SURVEYOR.

27. ONCE CONSTRUCTION OF ALL PROJECT AREAS AT THE PROJECT SITE HAVE BEEN COMPLETED, MAINTENANCE OF TRAFFIC DEVICES SHALL BE REMOVED.

28. CONTRACTOR SHALL ARRANGE FOR AND OBTAIN ANY REQUIRED FINAL SITE INSPECTIONS AND CERTIFICATIONS FOR PROJECT CLOSEOUT.


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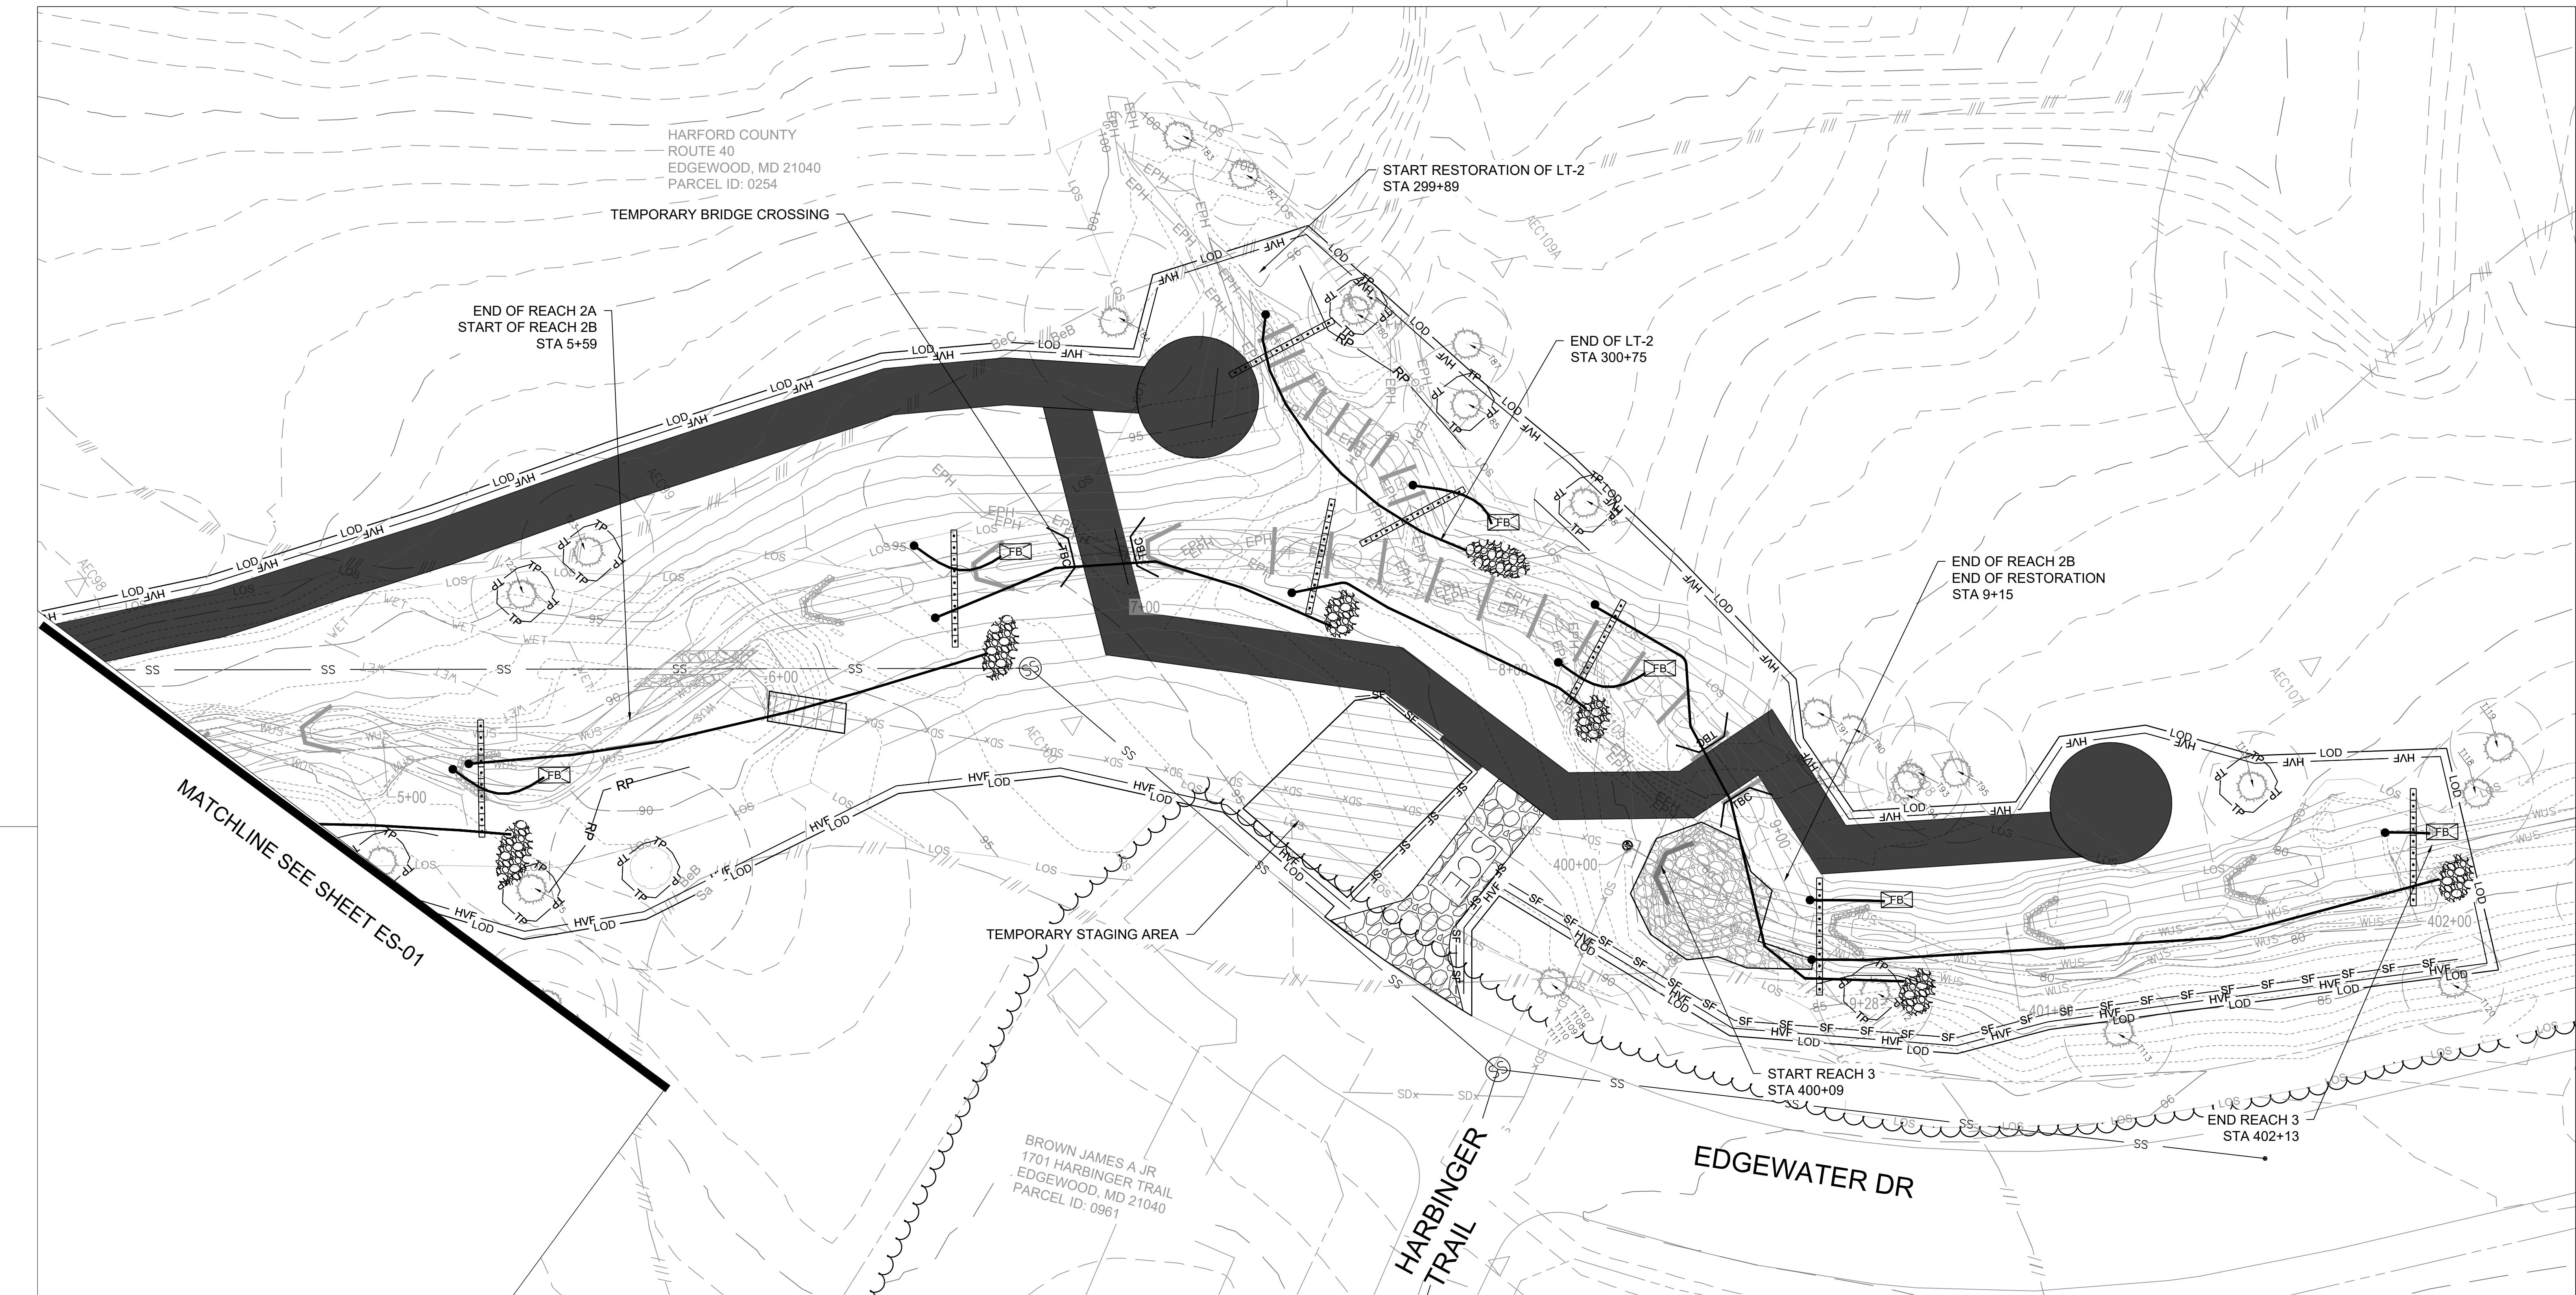
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SCALE : 1 inch

HARFORD COUNTY, MARYLAND	
EDGEWATER VILLAGE PARK	
STREAM RESTORATION	
SEQUENCE OF CONSTRUCTION	
Drawn By : _____ CA	Revisions
Designed By : _____ CA	
Reviewed By : _____ BWA	
Drawing No. SC-01	of SC-01
Sheet No.	43 of 65

S/C PLAN # 59914	Revisions
GRA-004622-2025	
SIGN AND SEAL	
PROFESSIONAL CERTIFICATION	
I HEREBY CERTIFY THAT THESE DOCUMENTS WERE PREPARED OR APPROVED BY ME, AND THAT I AM A DULY LICENSED PROFESSIONAL ENGINEER UNDER THE LAWS OF THE STATE OF MARYLAND LICENSE NO. XXXXX, EXPIRATION DATE: XX/XX/XXXX.	



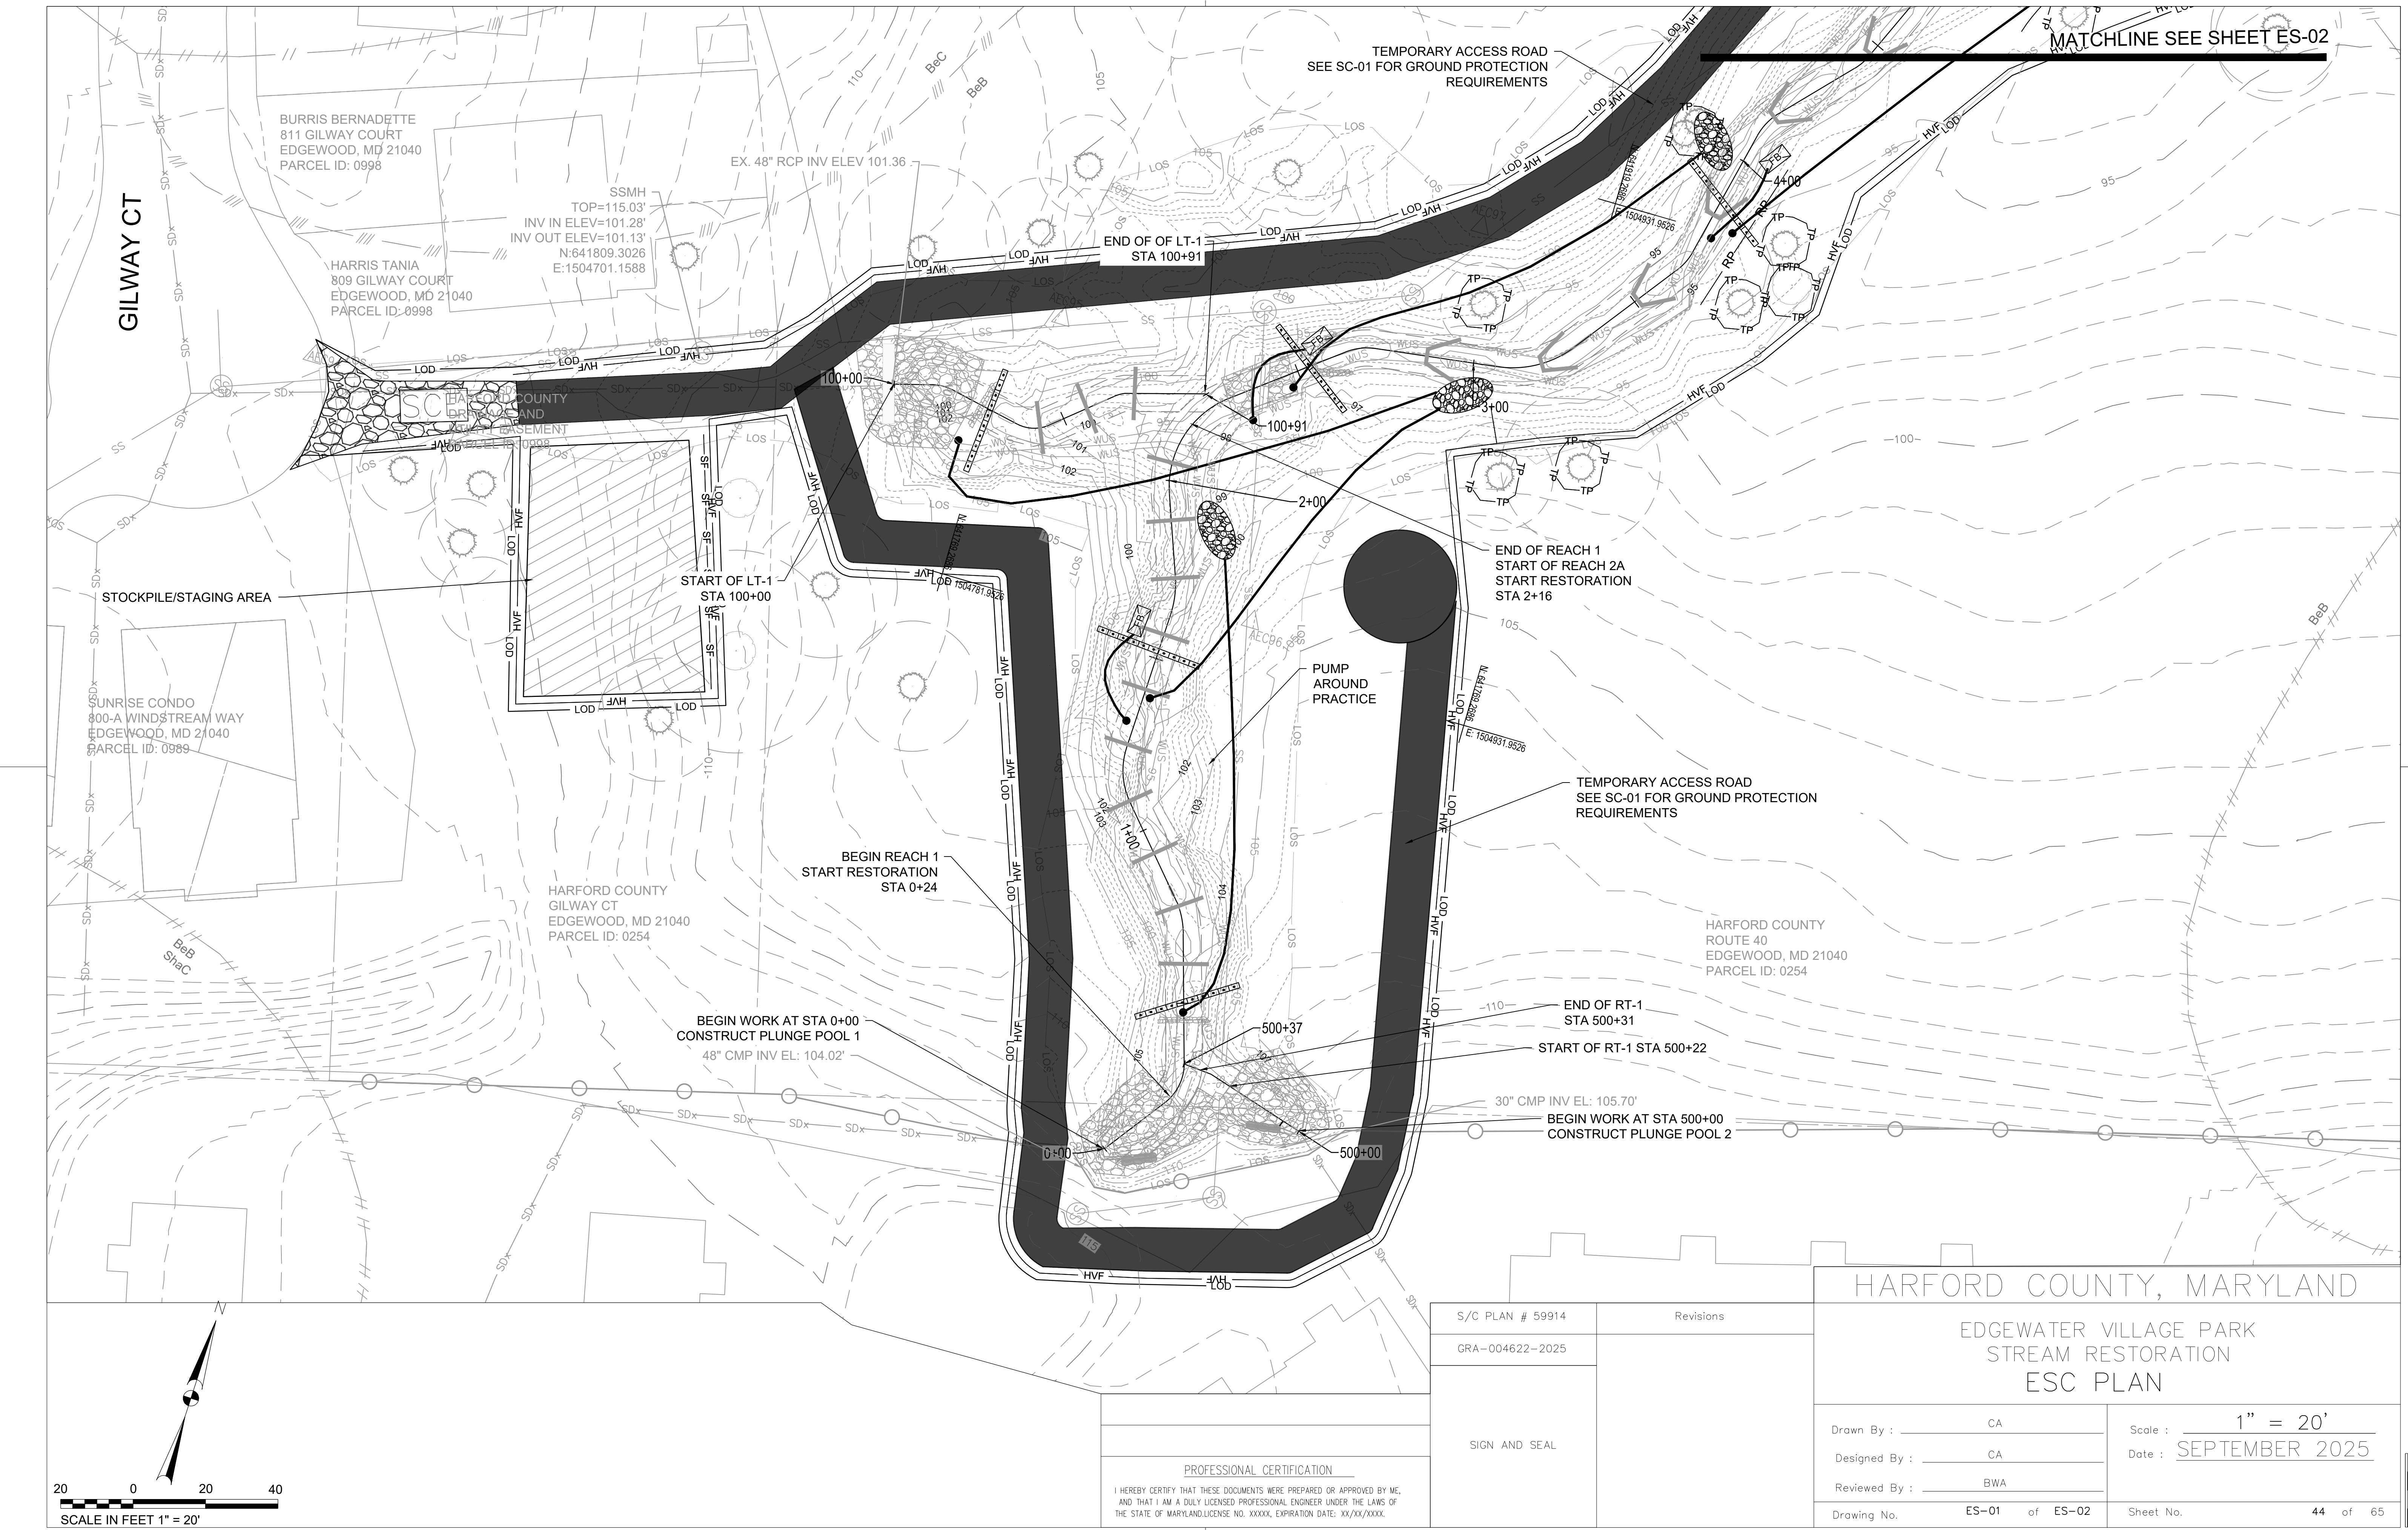

S/C PLAN # 59914

Revisions

GRA-004622-2025

SIGN AND SEAL


HARFORD COUNTY, MARYLAND

EDGEWATER VILLAGE PARK STREAM RESTORATION ESC PLAN

Drawn By : CA	Scale : 1" = 20'
Designed By : CA	Date : SEPTEMBER 2025
Reviewed By : BWA	
Drawing No. ES-02 of ES-02	Sheet No. 45 of 65


PROFESSIONAL CERTIFICATION

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THE STATE OF MARYLAND, LICENSE NO. XXXXX, EXPIRATION DATE: XX/XX/XXXX.

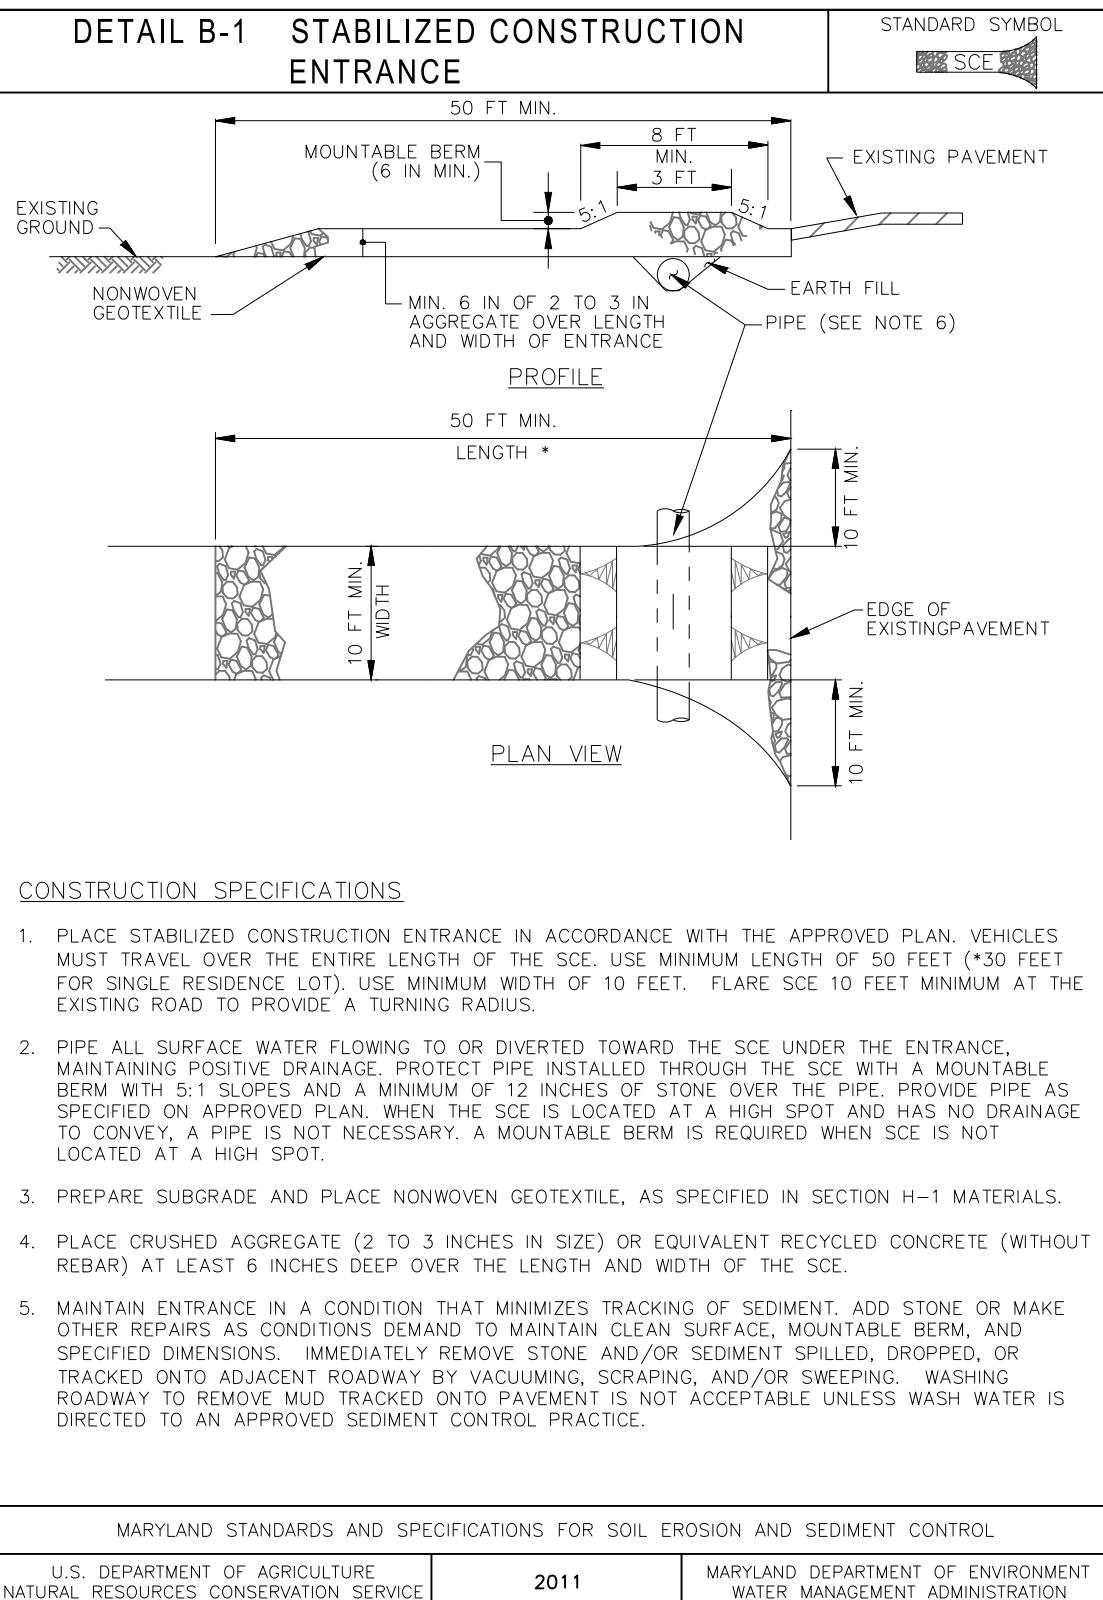


1 STABILIZED CONSTRUCTION ENTRANCE

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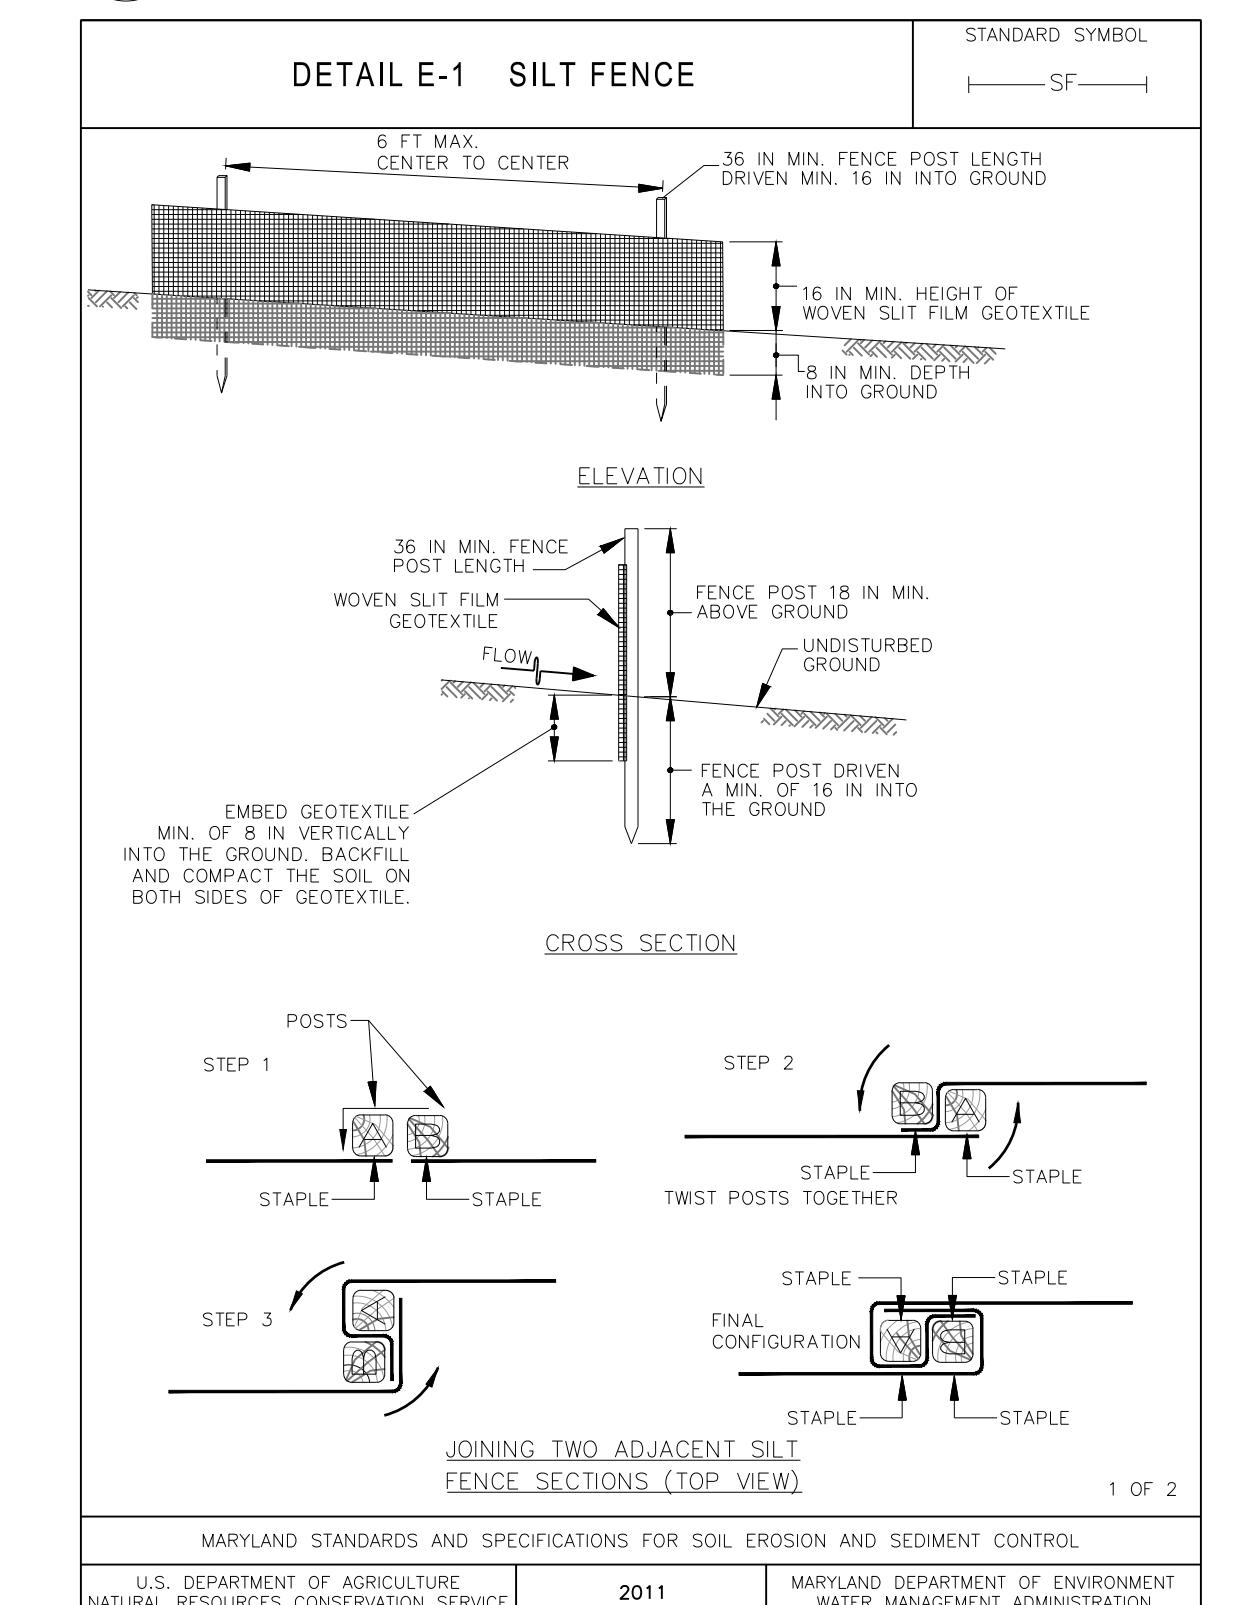
5 PERMANENT SOIL STABILIZATION MATTING - SLOPE
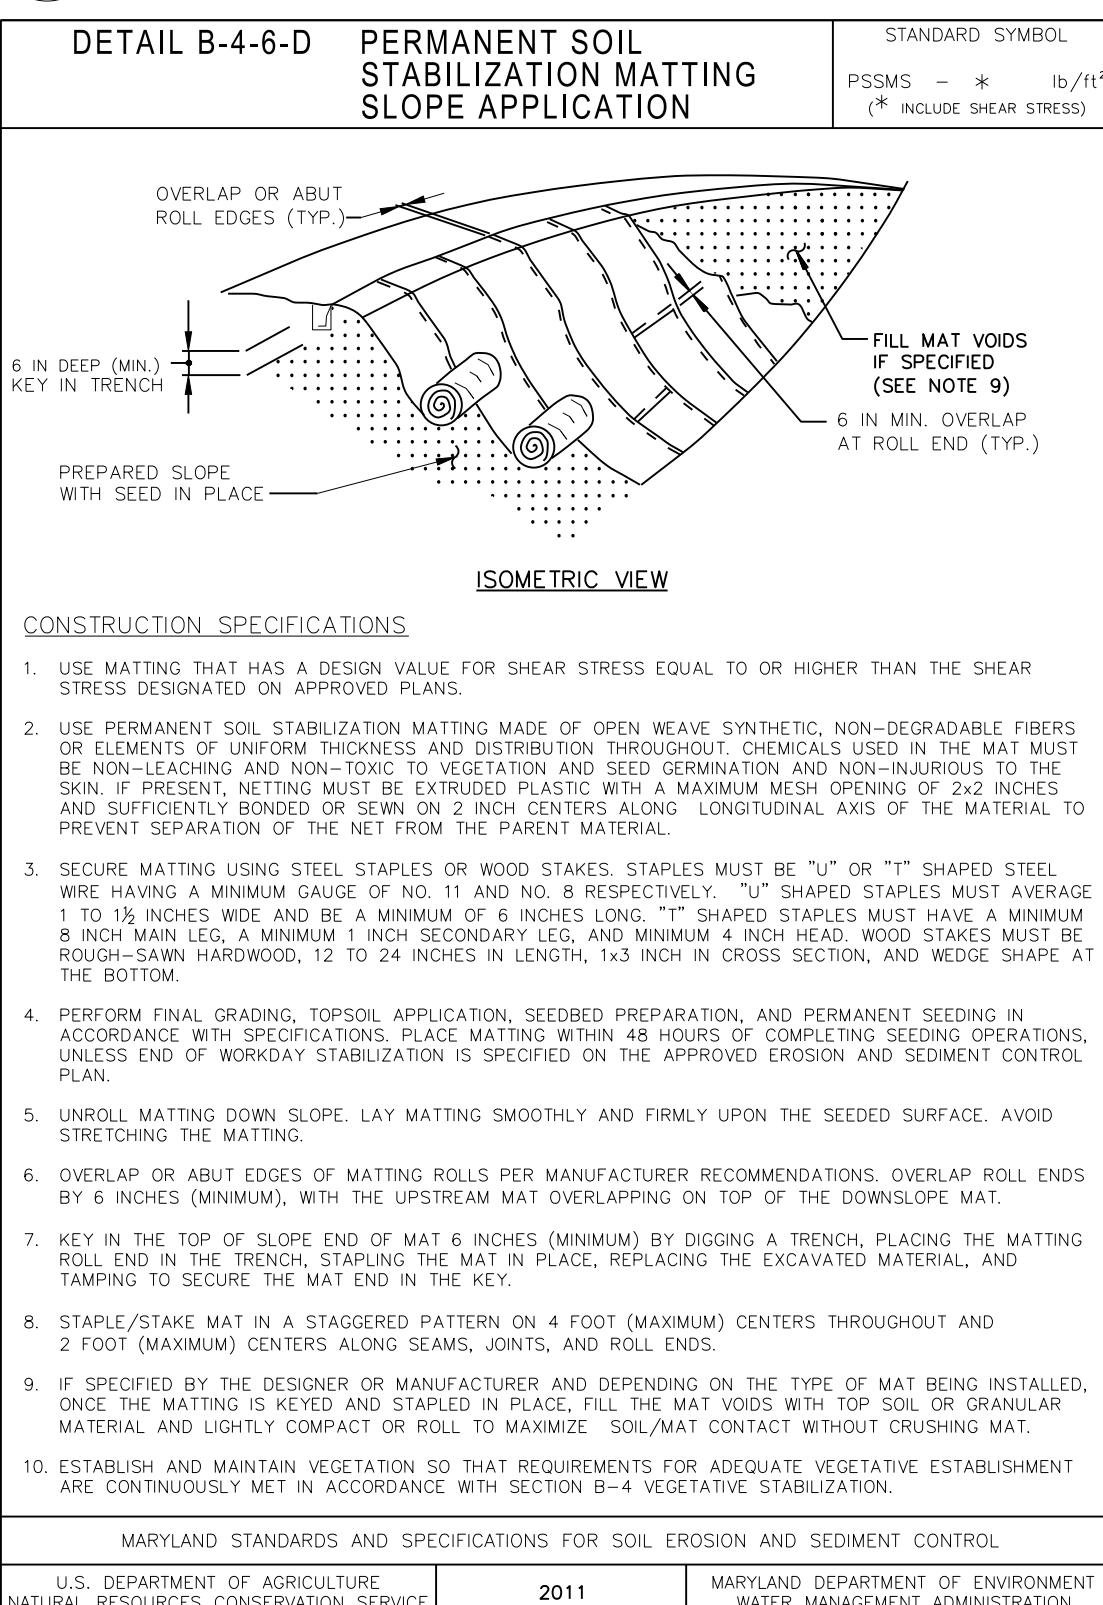
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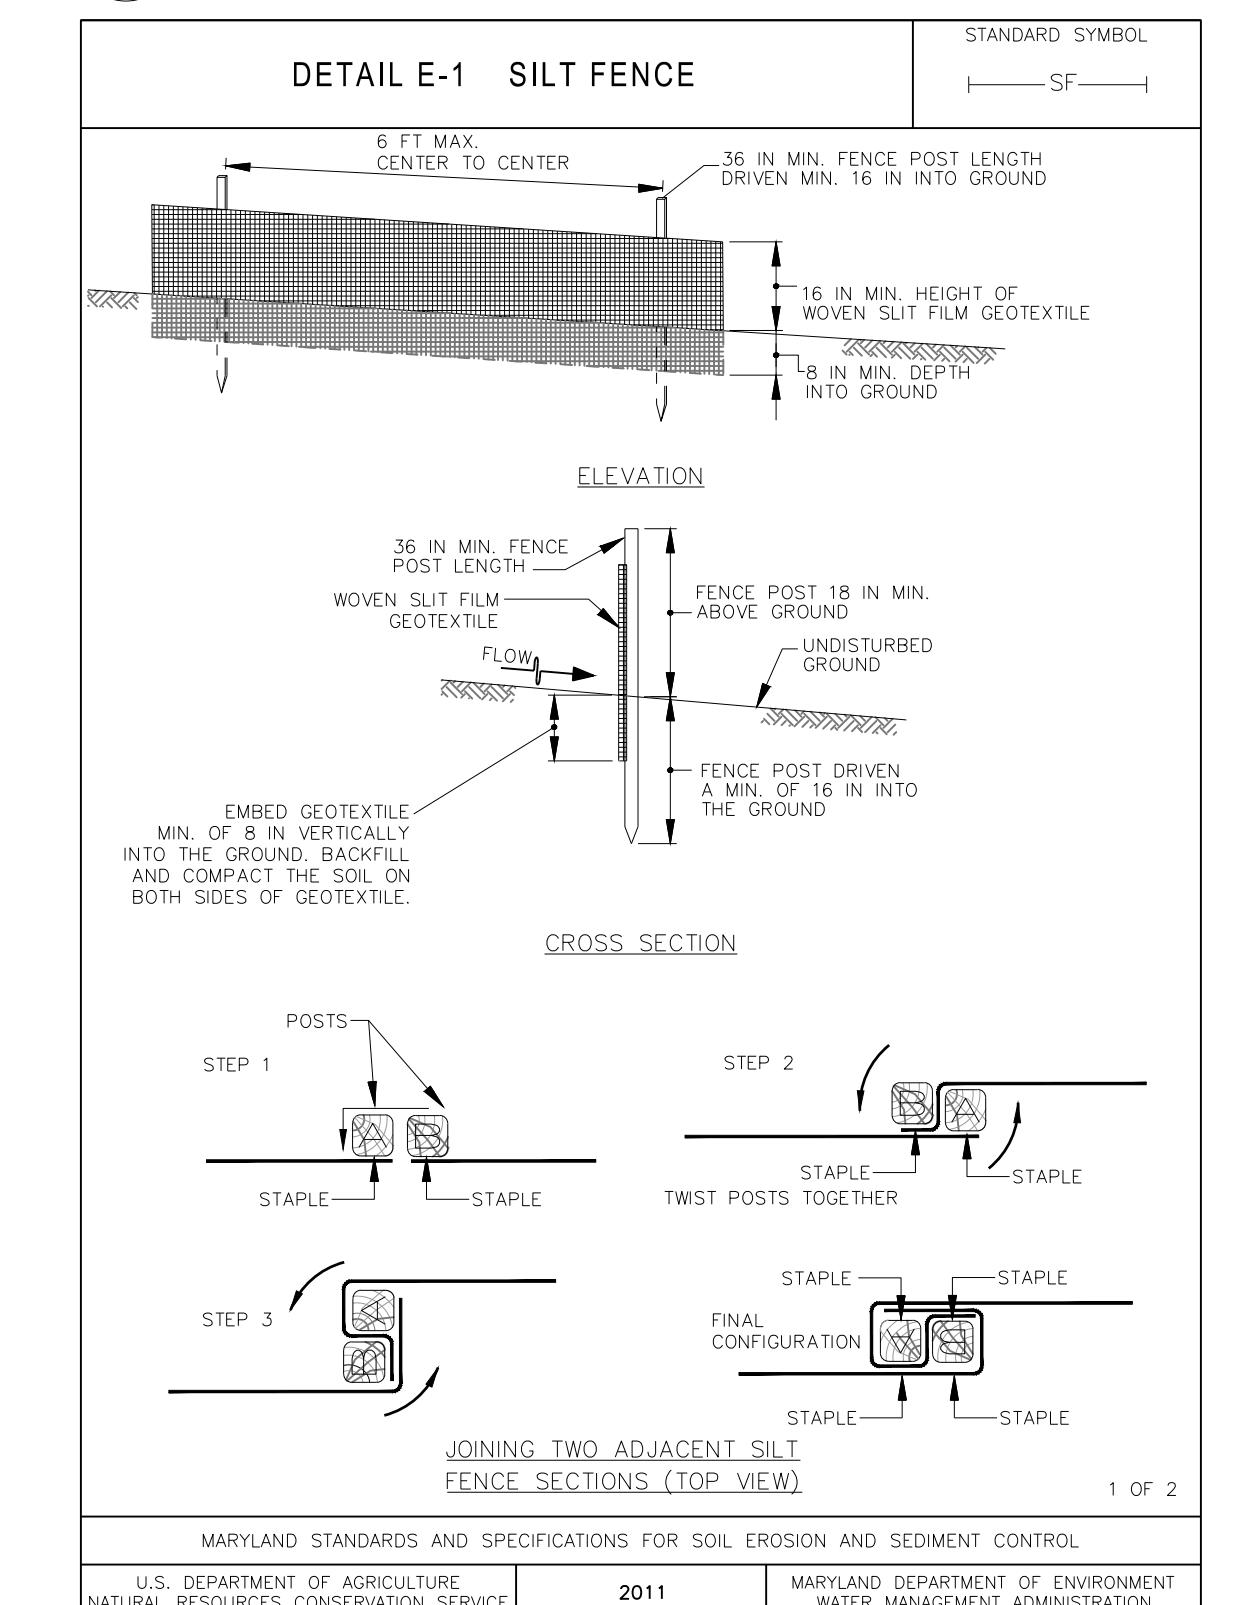
2 TEMPORARY SOIL STABILIZATION MATTING - CHANNEL

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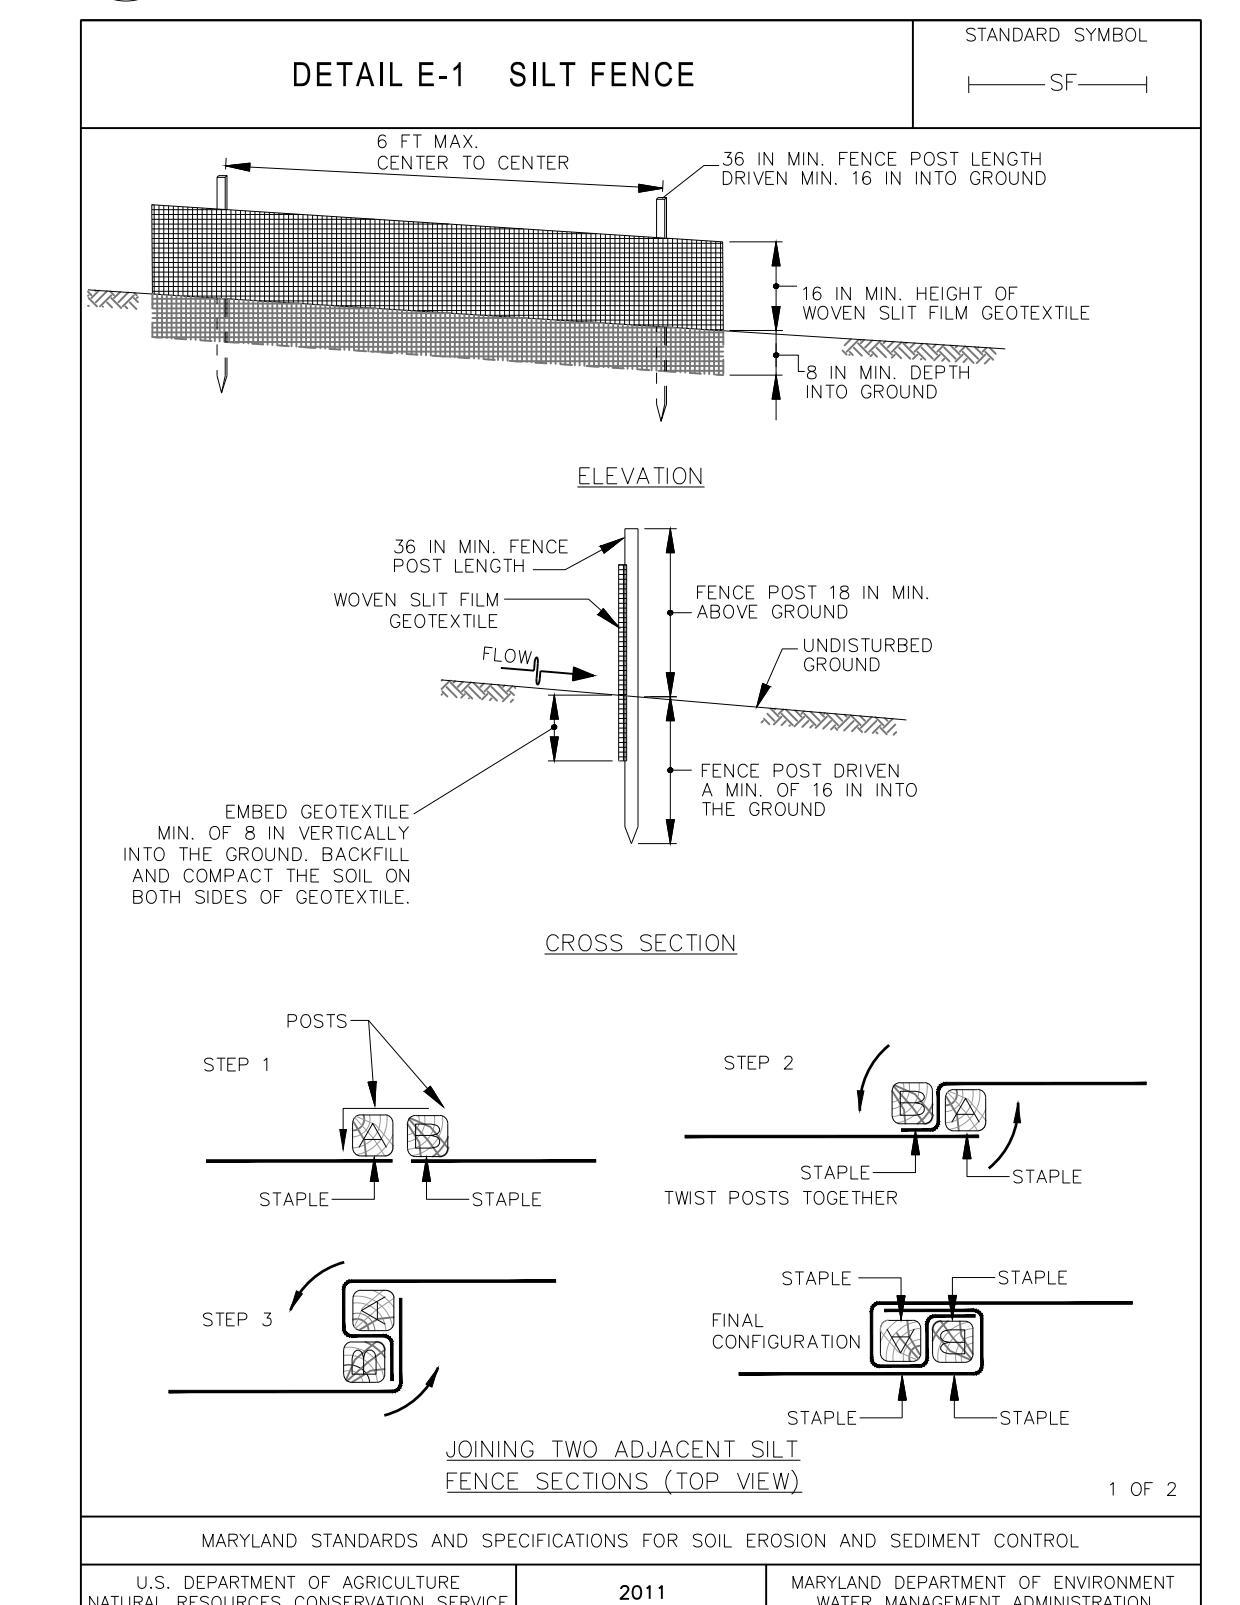
3 TEMPORARY SOIL STABILIZATION MATTING - SLOPE

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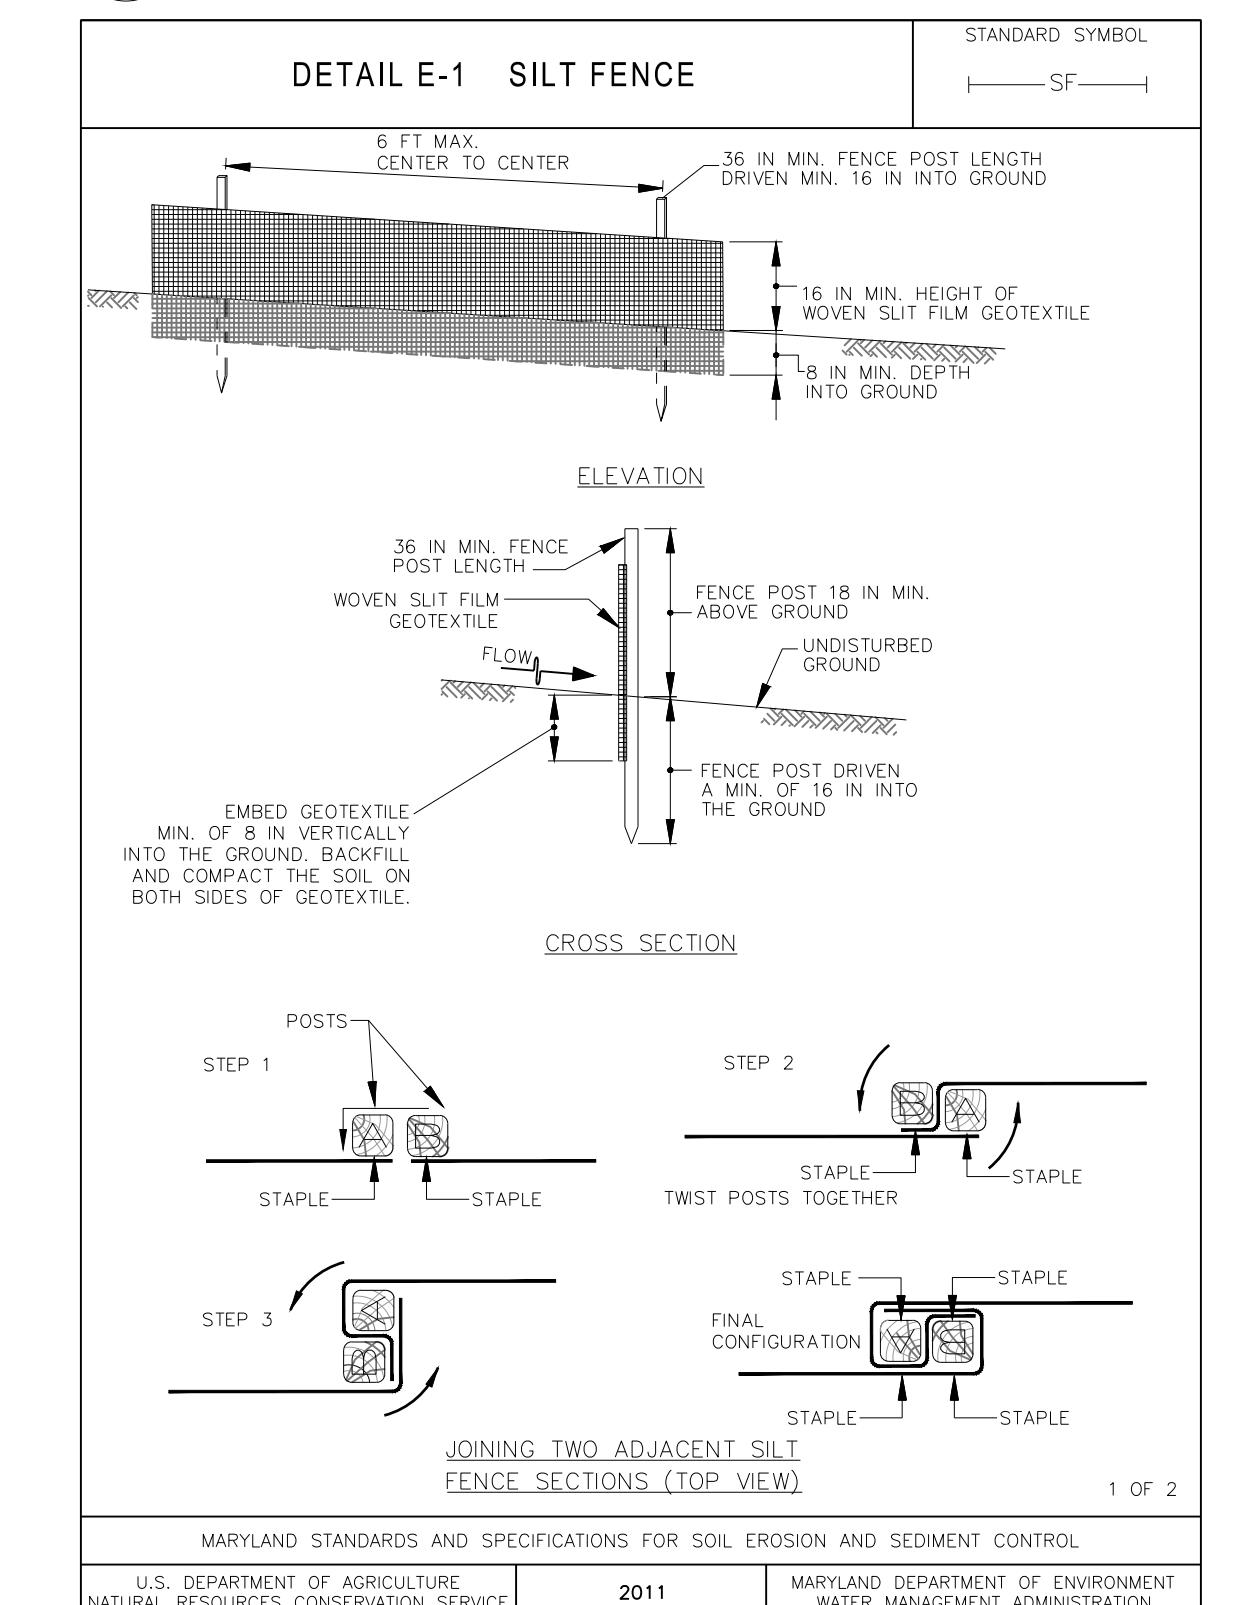
4 PERMANENT SOIL STABILIZATION MATTING - CHANNEL
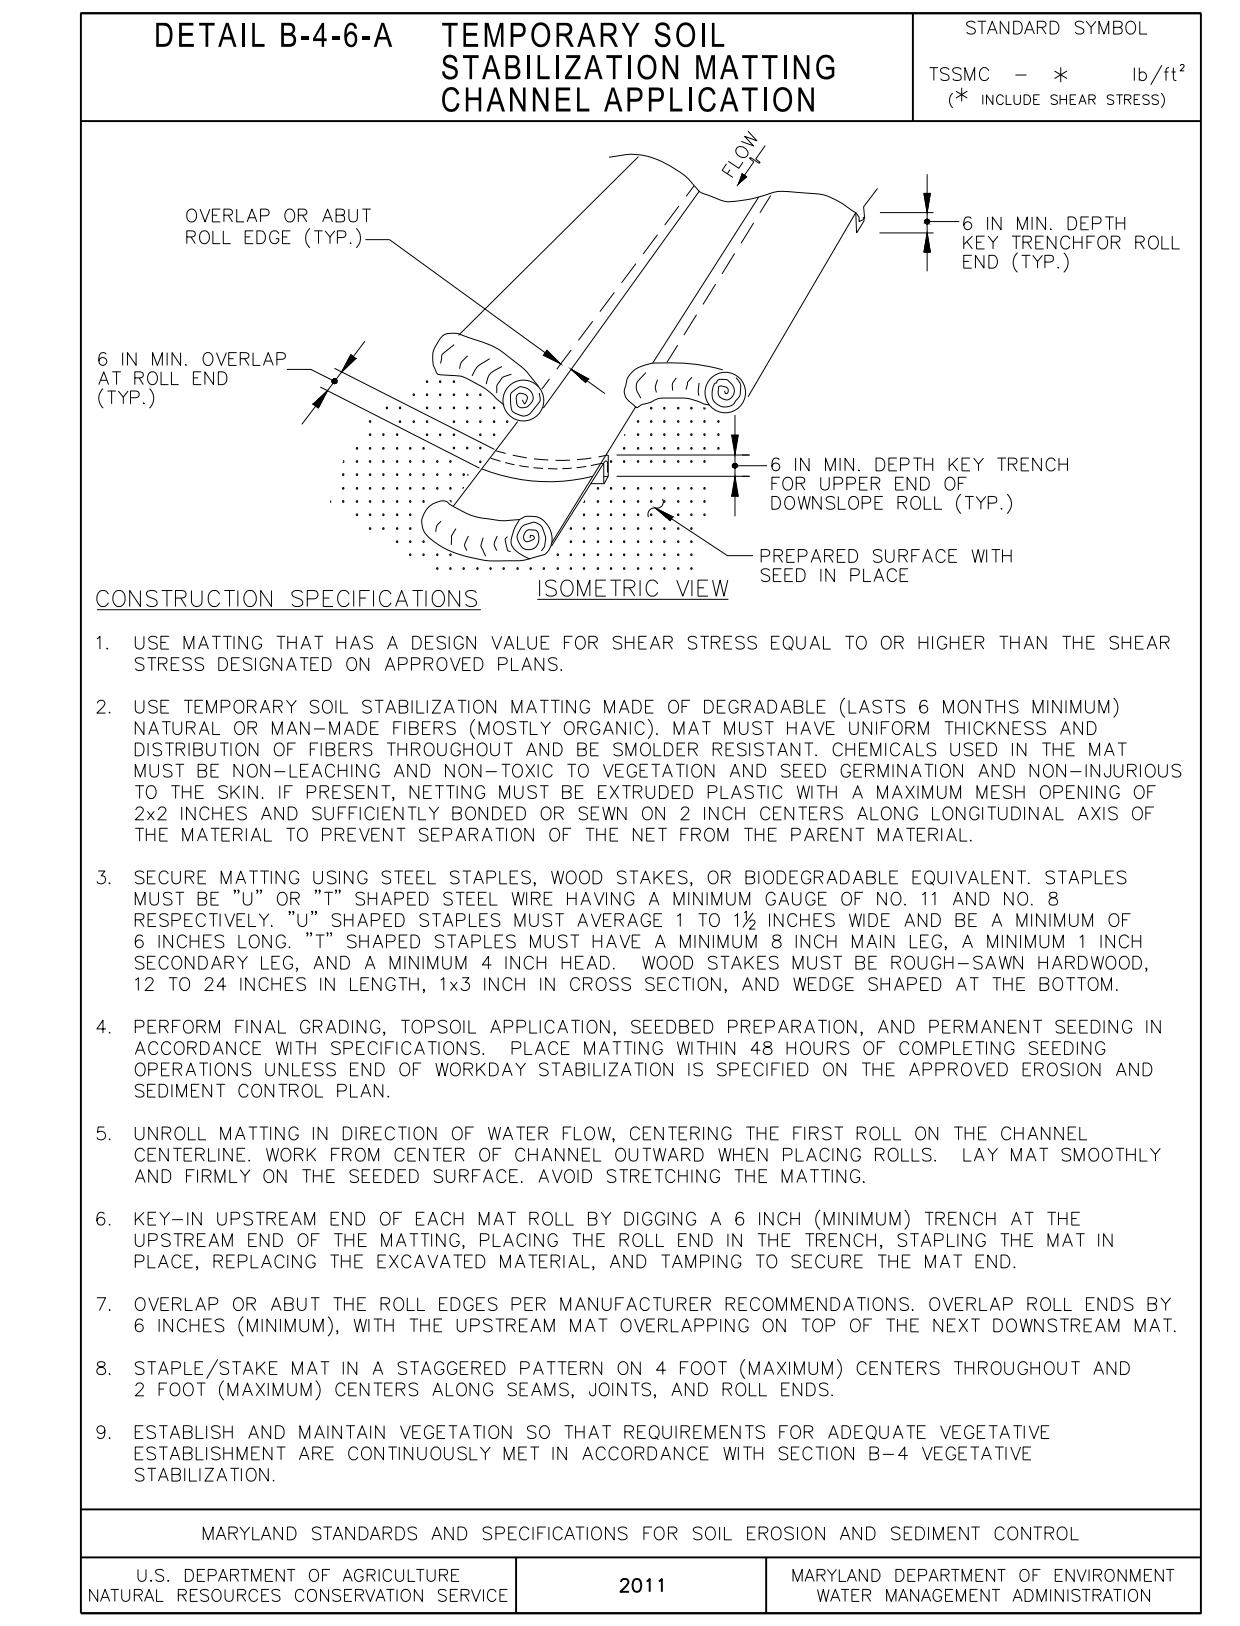
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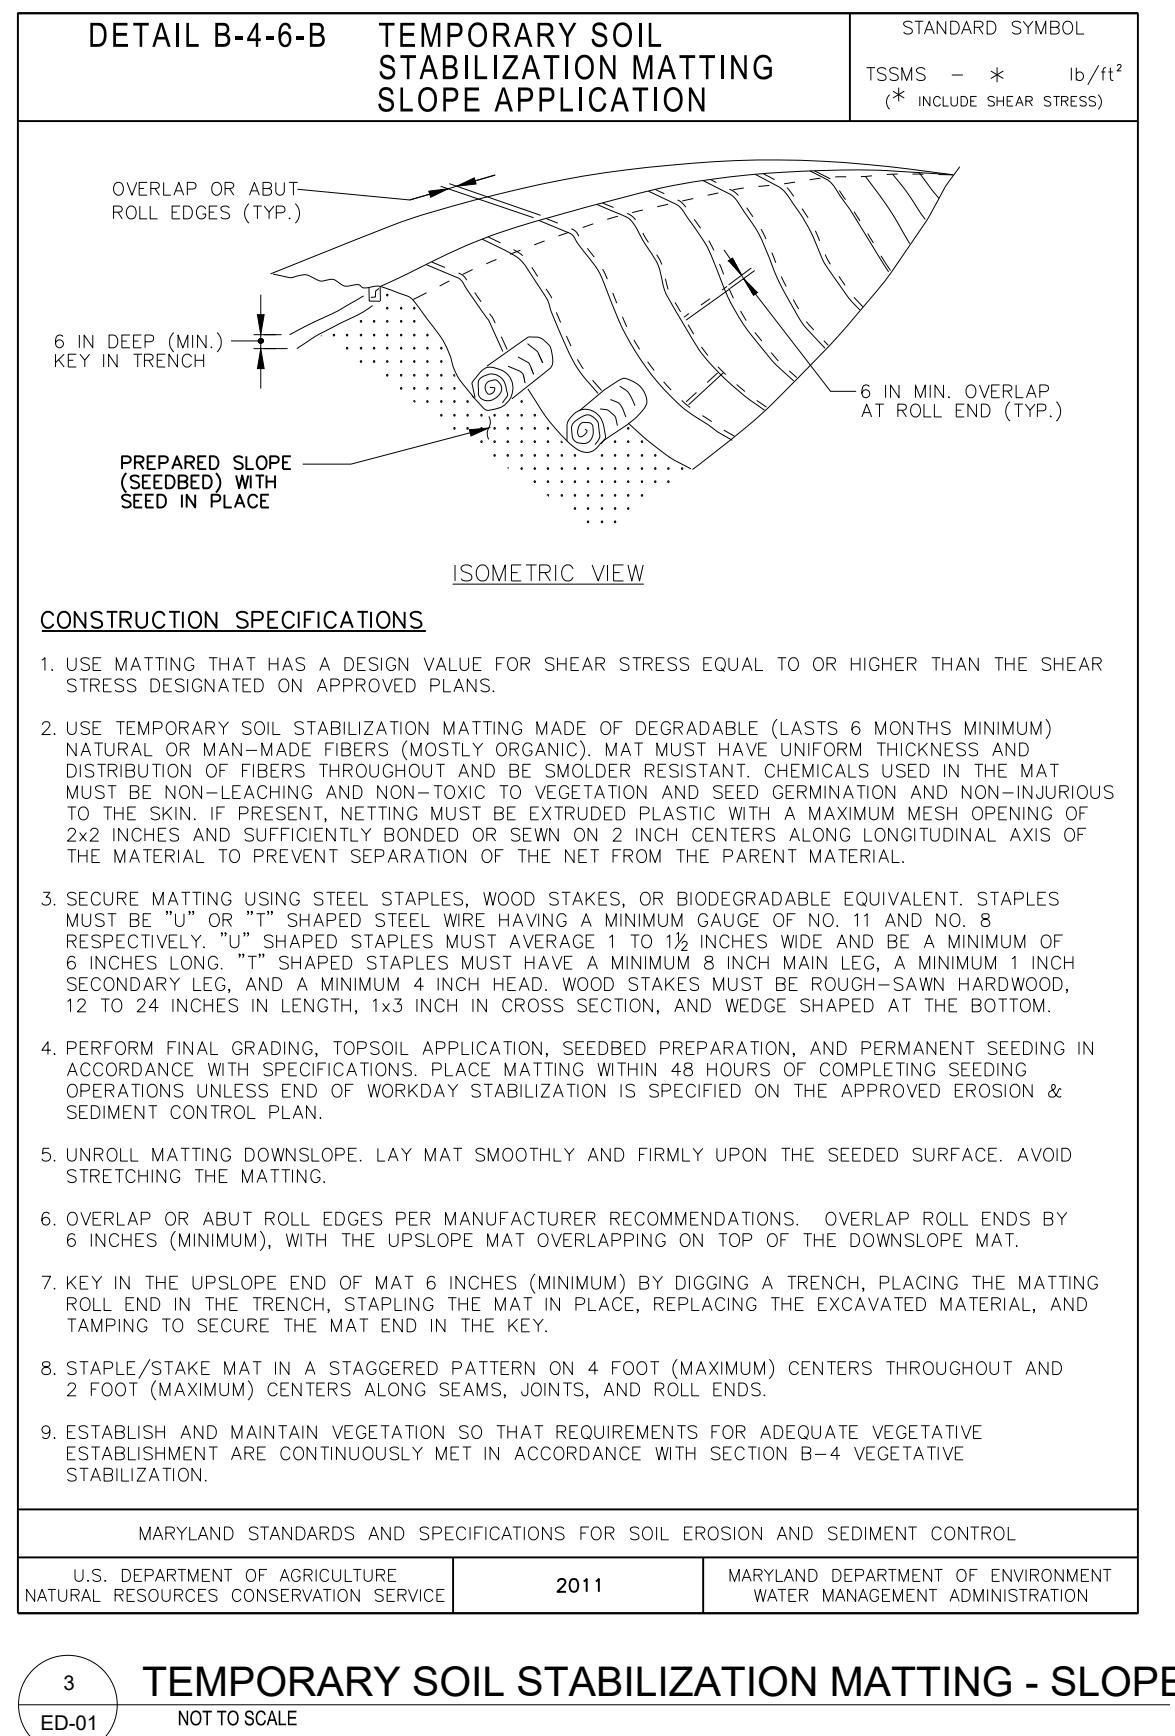
5 SILT FENCE







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6 SILT FENCE

ED-01 NOT TO SCALE






7 MOT TRAFFIC SYMBOLS

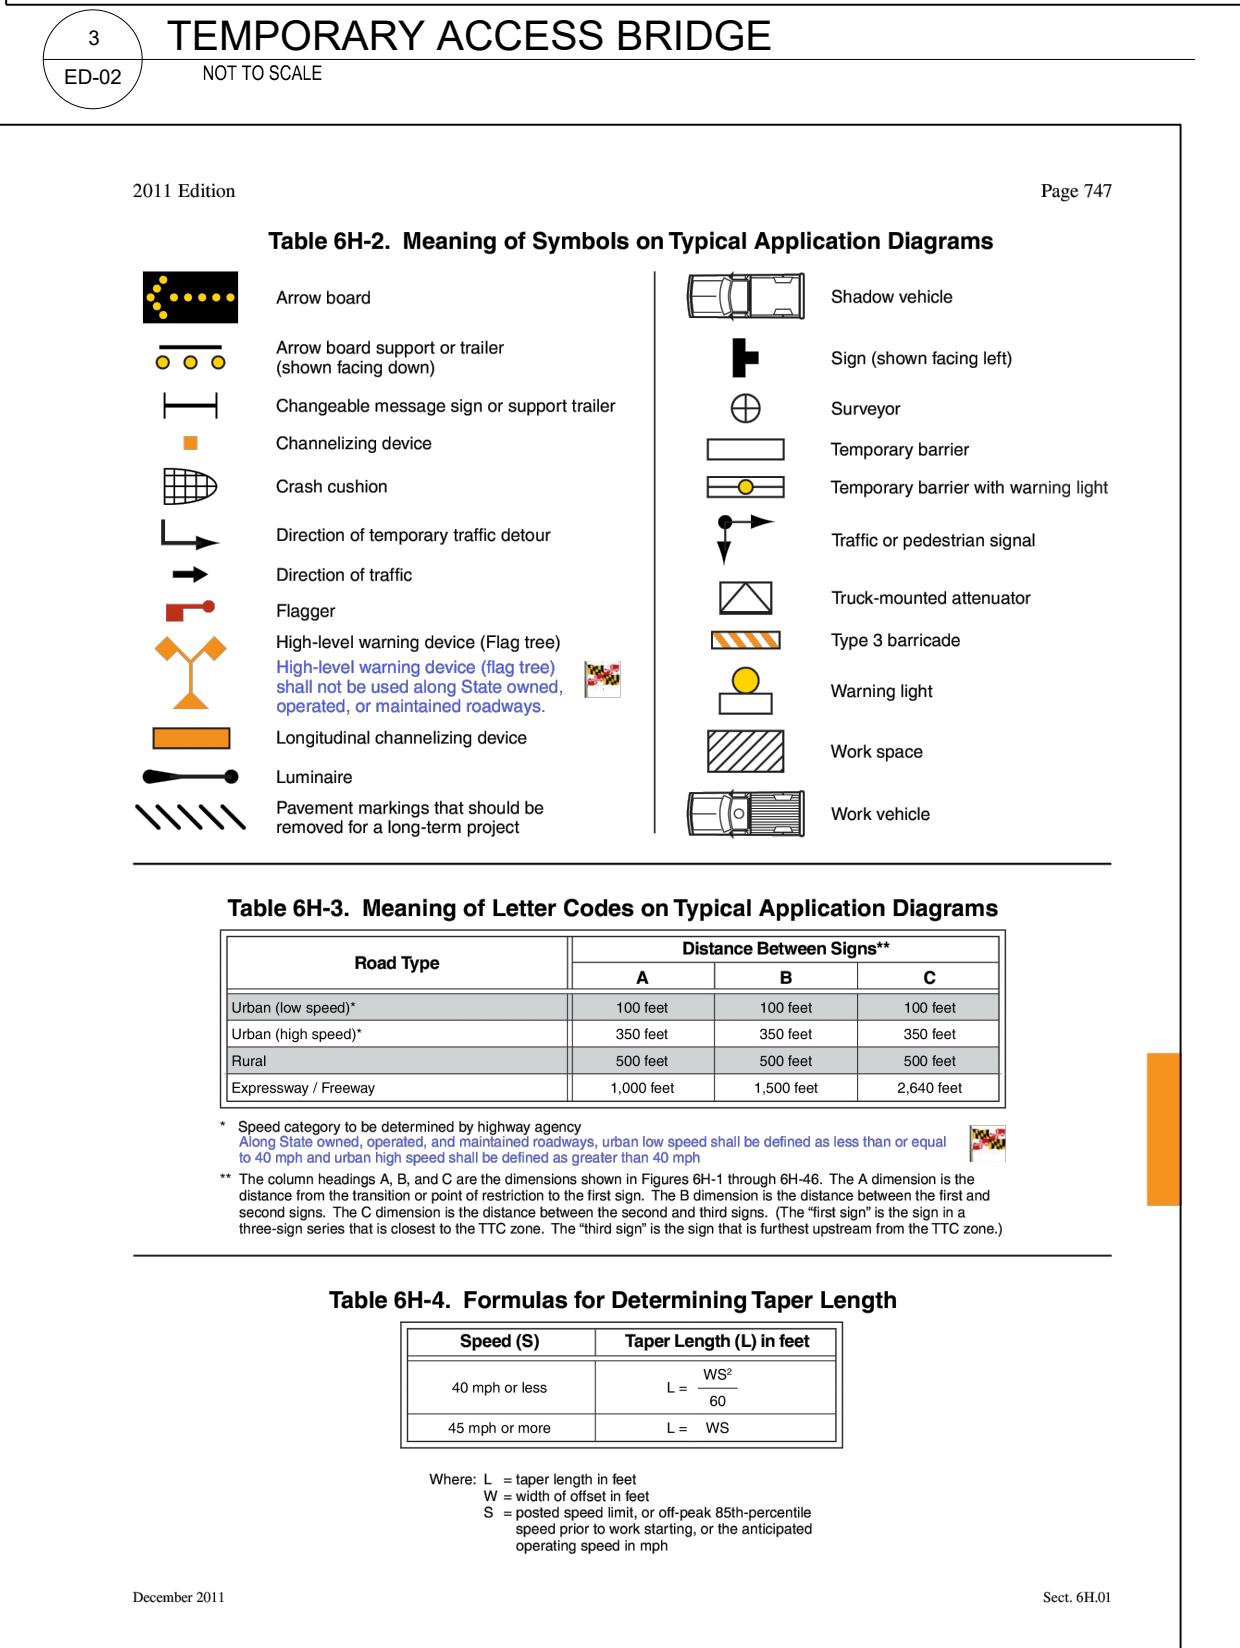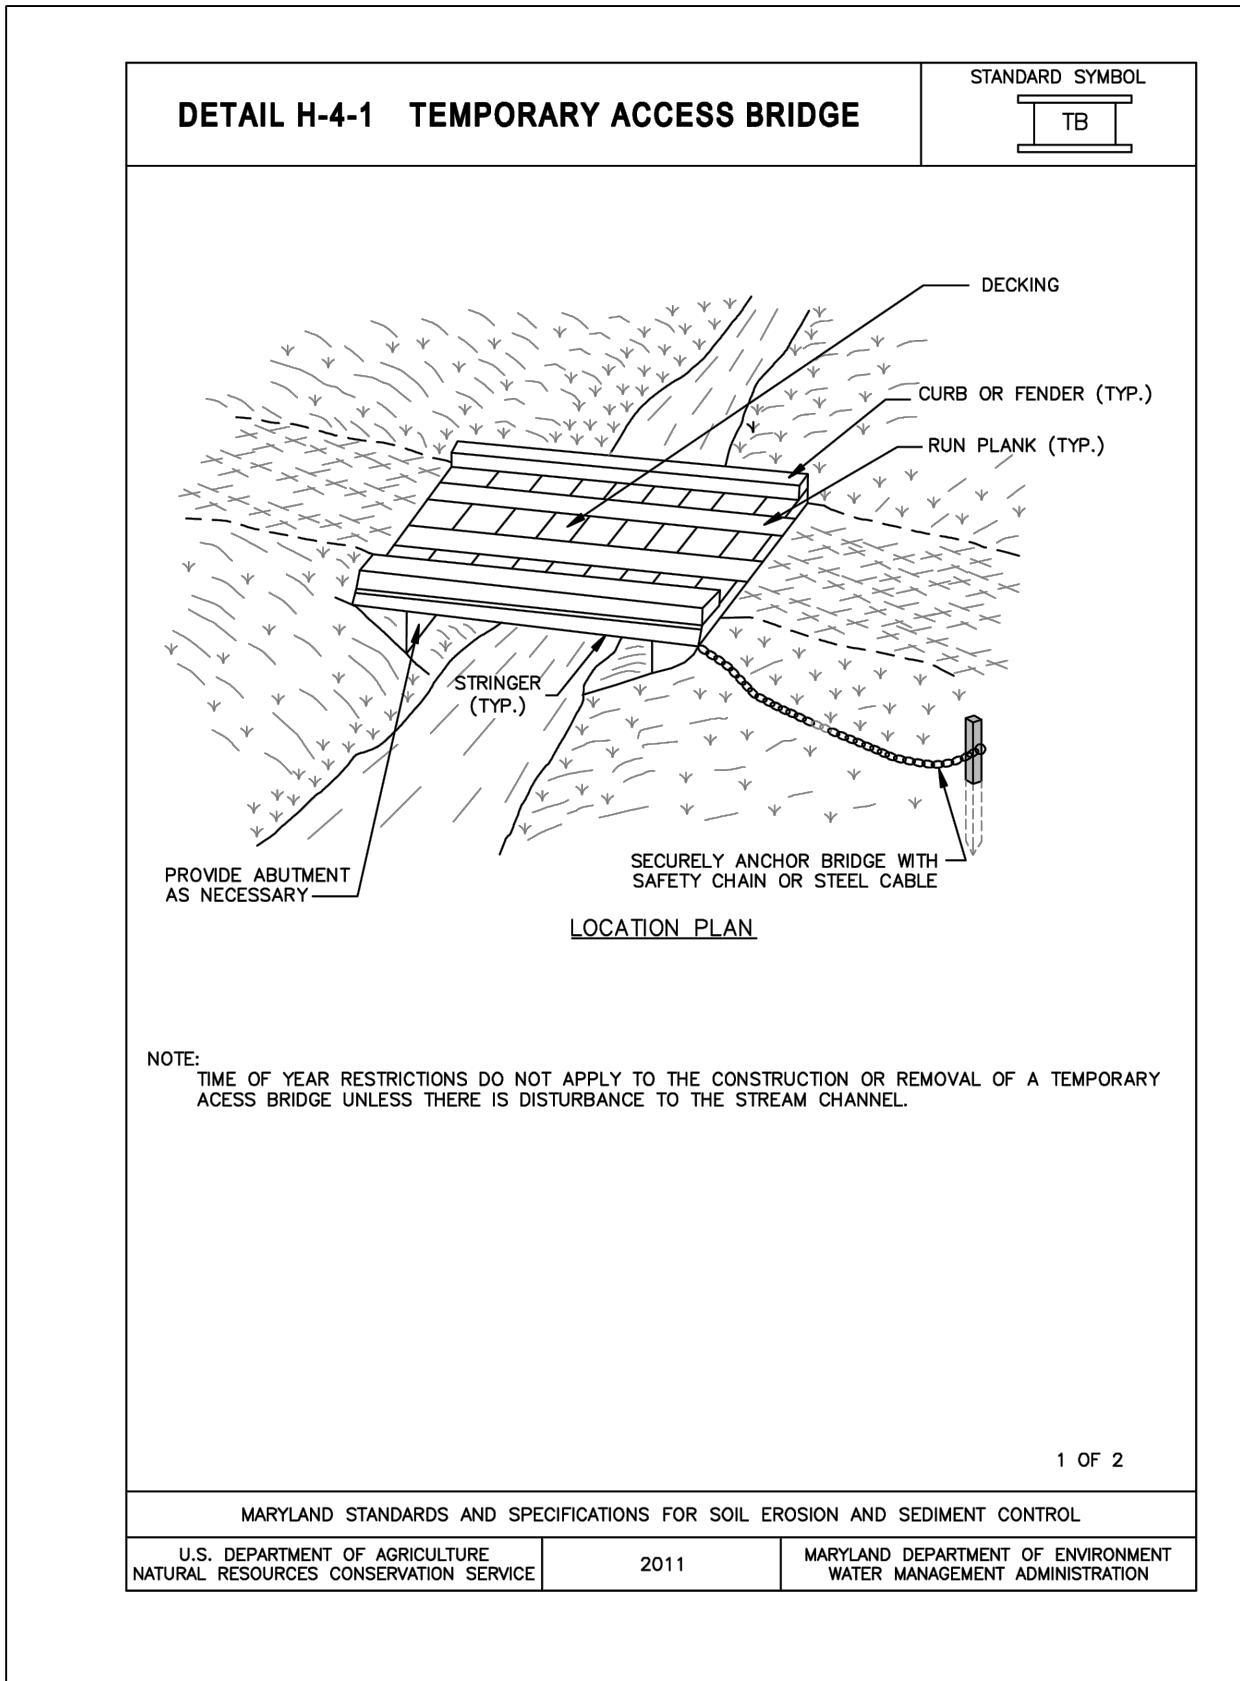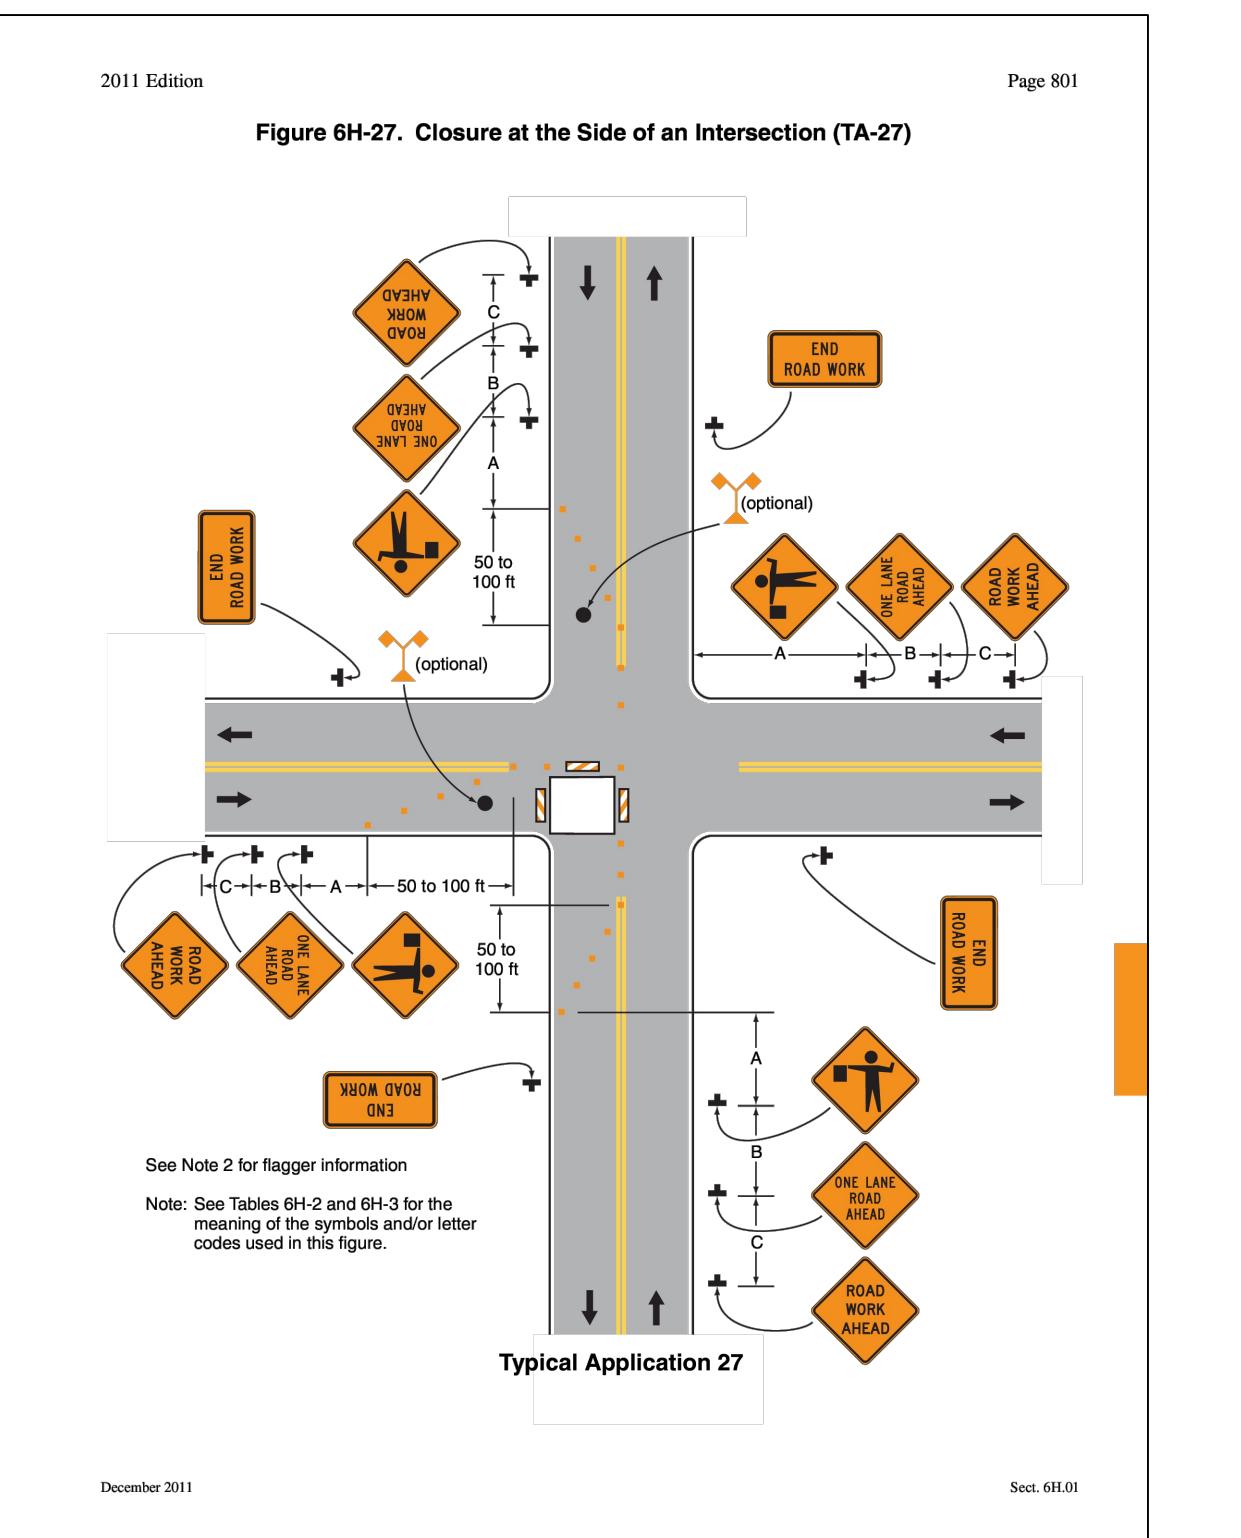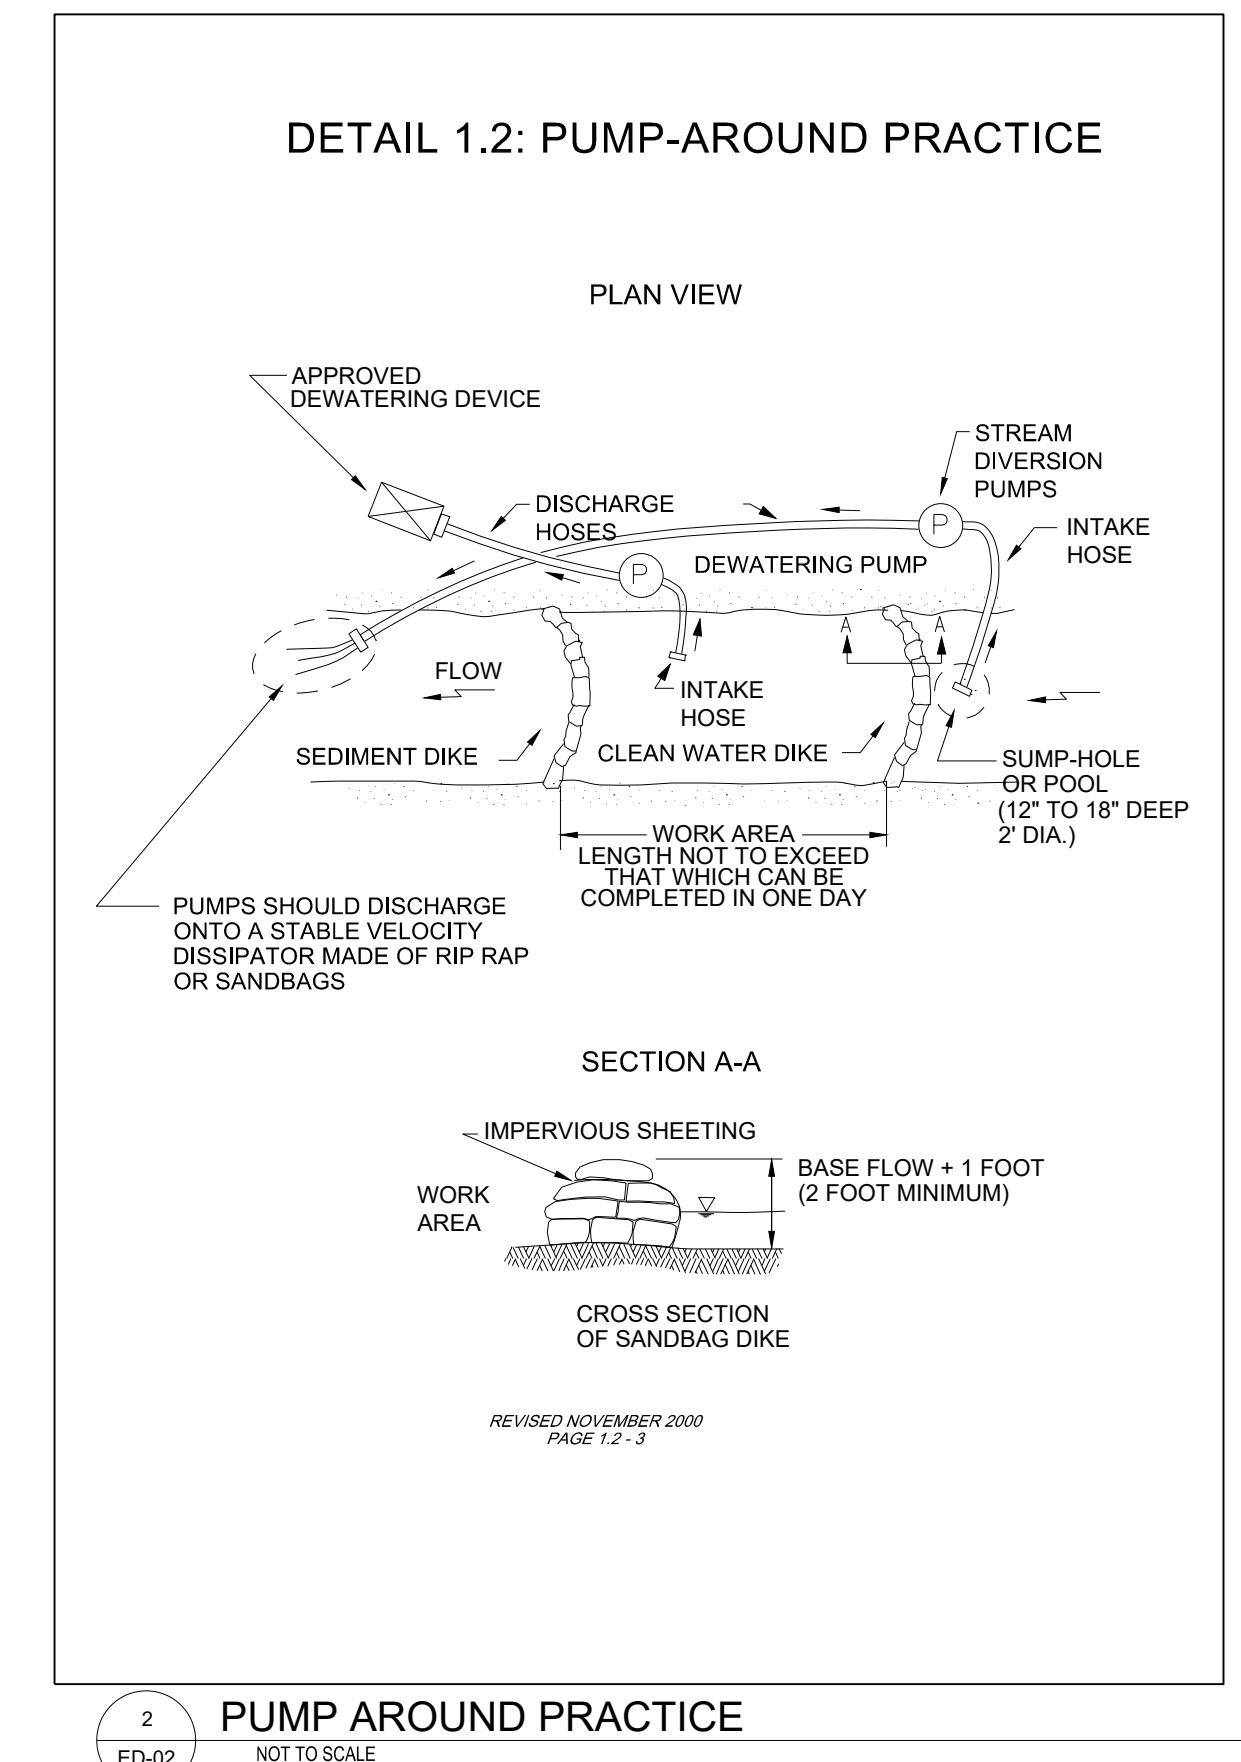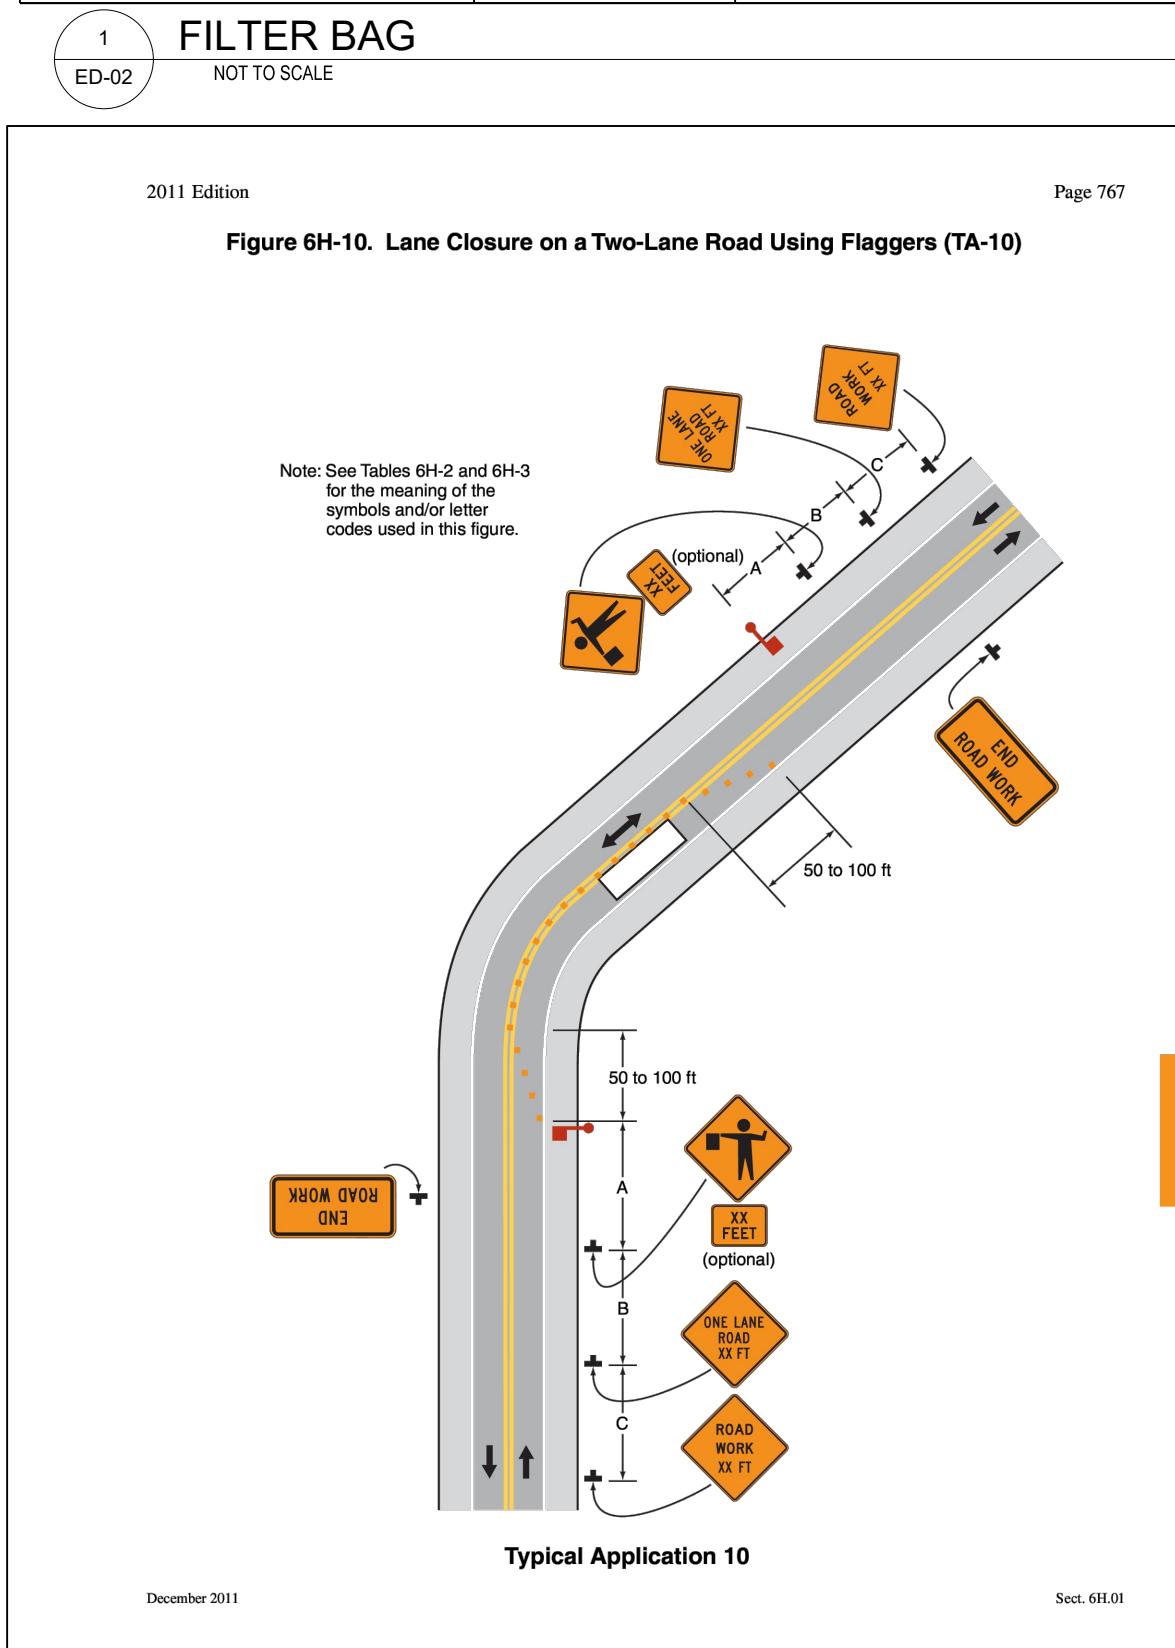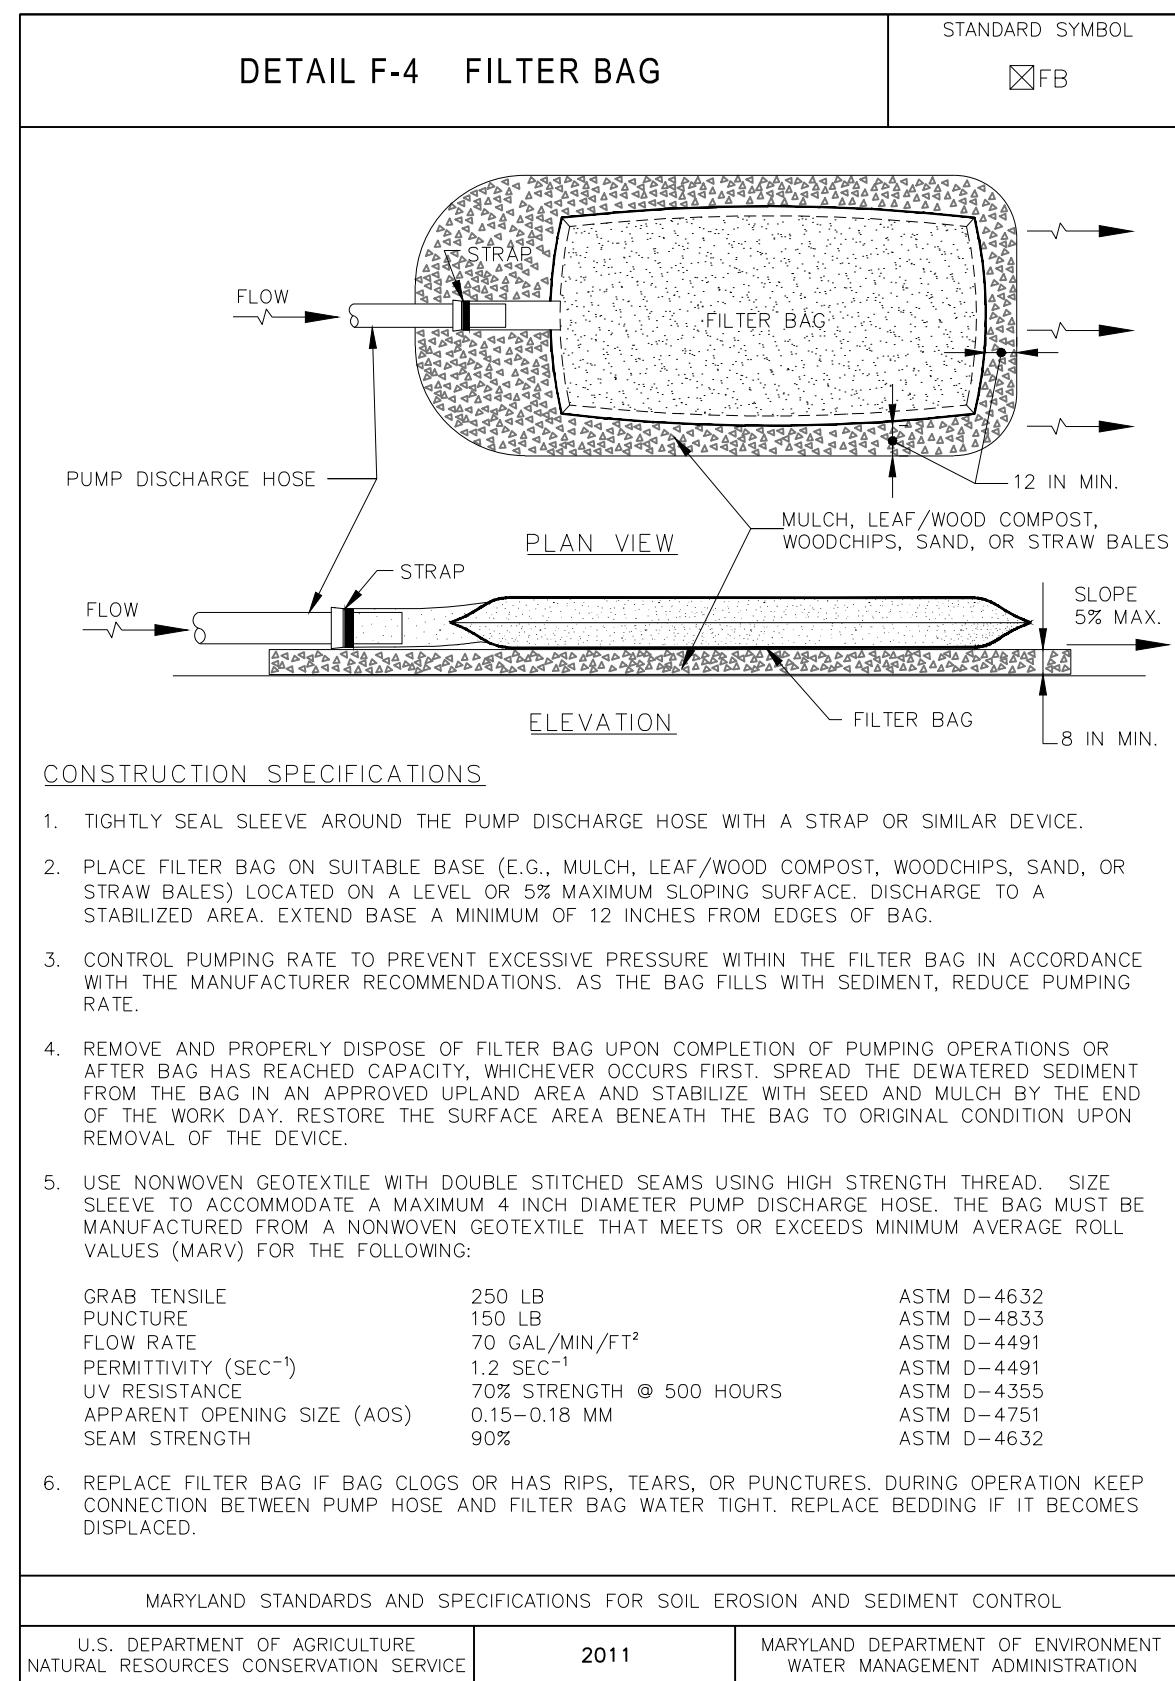ED-02 NOT TO SCALE

S/C PLAN # 59914	Revisions
GRA-004622-2025	
SIGN AND SEAL	

PROFESSIONAL CERTIFICATION

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4 CONCRETE WASHOUT STRUCTURE

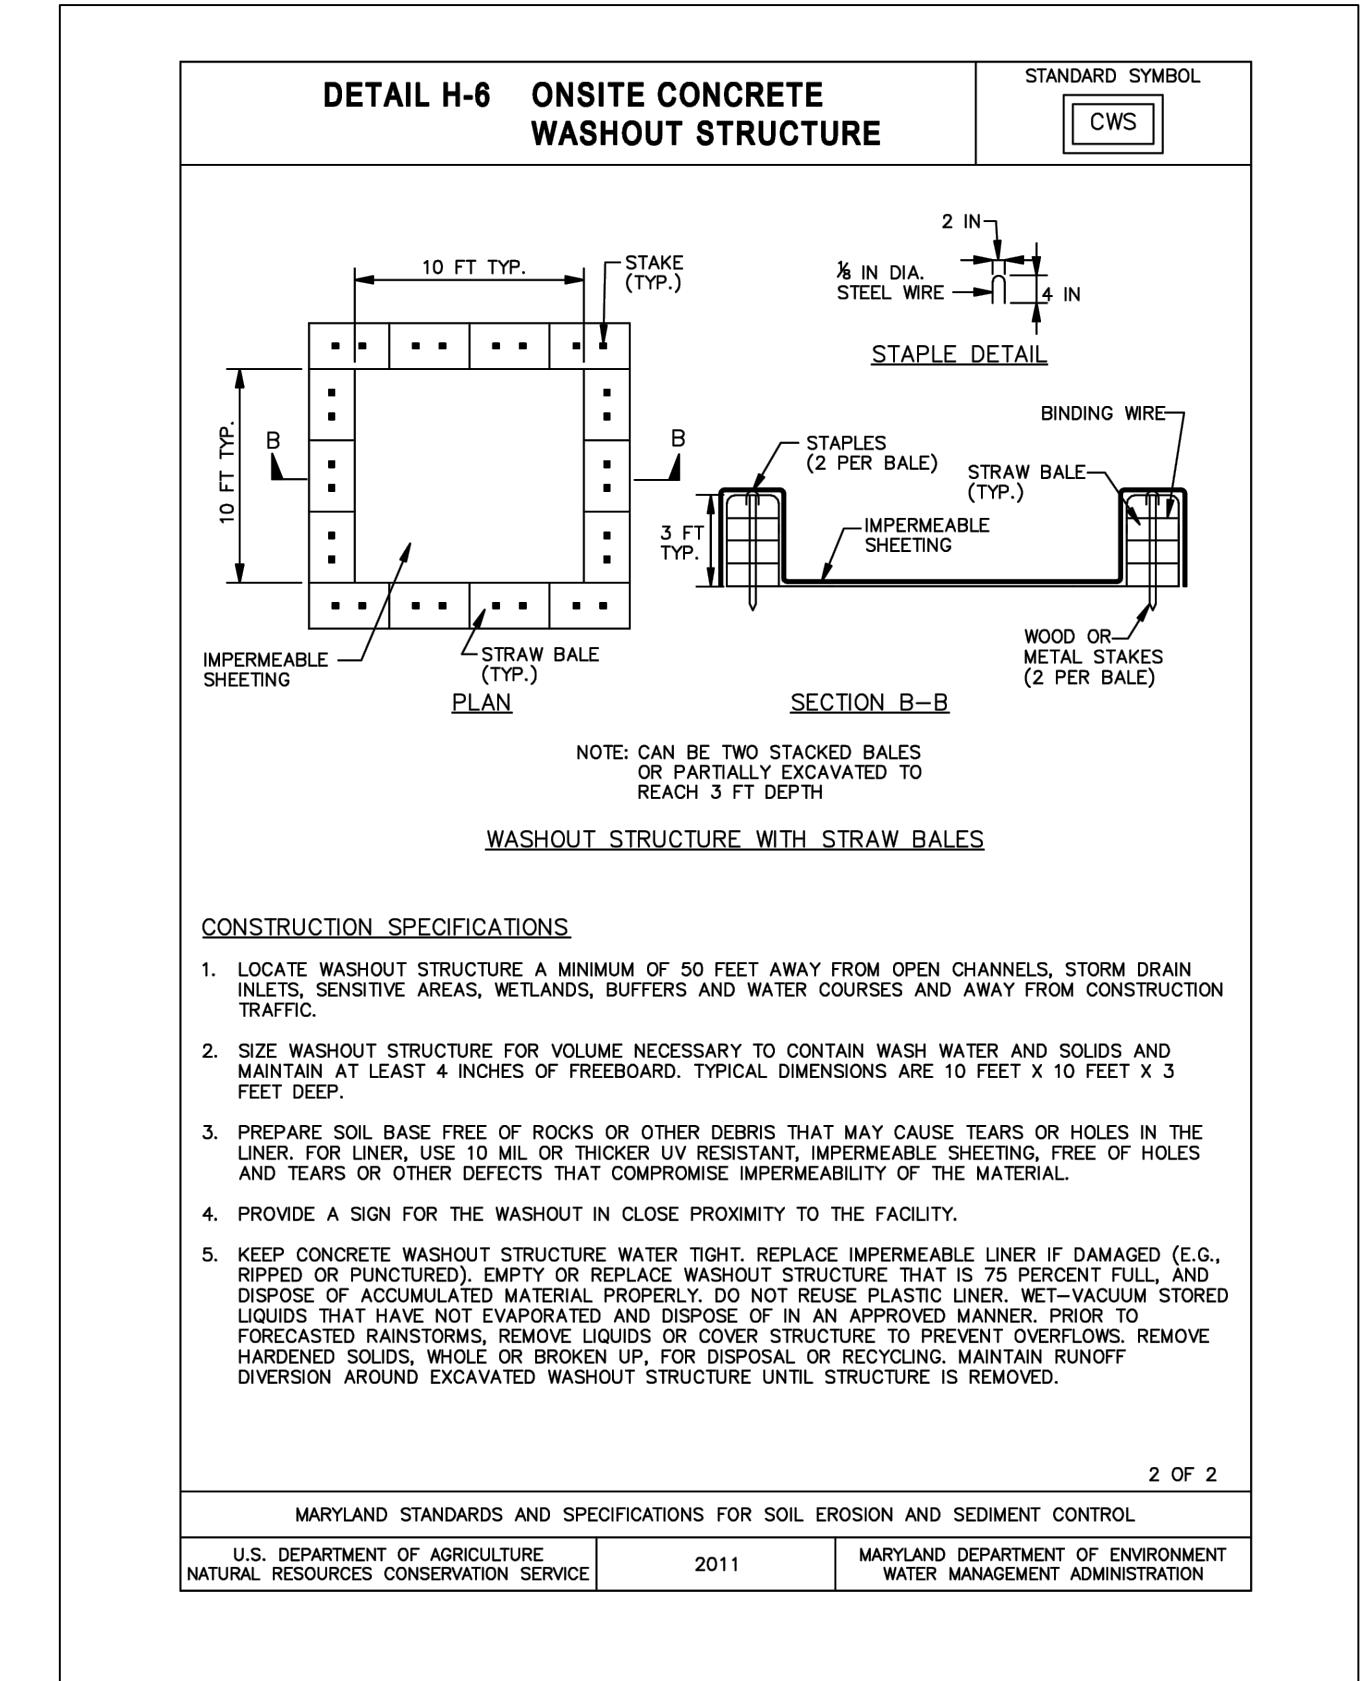ED-02 NOT TO SCALE

HARFORD COUNTY, MARYLAND

EDGEMARSH VILLAGE PARK STREAM RESTORATION ESC DETAILS

Drawn By: CA	Scale: AS NOTED
Designed By: CA	Date: SEPTEMBER 2025
Reviewed By: BWA	
Drawing No. ED-02 of ED-03	Sheet No. 47 of 65

HGC DWG ID No.: HGC DWG ID No.: 1 inch

SEDIMENT CONTROL NOTES

- THE CONTRACTOR/OWNER IS RESPONSIBLE FOR OBTAINING ALL NECESSARY PERMITS. FURTHER, NO CONSTRUCTION ACTIVITY SHALL TAKE PLACE UNTIL ALL REQUIRED PERMITS HAVE BEEN OBTAINED.
- THE LIMITS OF DISTURBANCE SHALL BE CLEARLY DELINEATED IN THE FIELD PRIOR TO GRADING OF THE SITE TO ENSURE COMPLIANCE WITH APPROVED PLANS. ALL FOREST RETENTION AREAS WILL BE DELINEATED WITH BLAZE ORANGE FENCE AS WELL AS ANY SWM INFILTRATION PRACTICE PRIOR TO ANY CLEARING. WORK BEYOND THE LIMITS OF DISTURBANCE AND IN ANY AREA INSIDE THE FOREST RETENTION AND SWM INFILTRATION AREA IS CONSIDERED A VIOLATION OF THIS PLAN.
- ALL SEDIMENT CONTROL PRACTICES MUST BE INSTALLED PRIOR TO ANY CONSTRUCTION ACTIVITY. UPON COMPLETION OF THE INSTALLATION OF PERIMETER SEDIMENT CONTROL PRACTICES THE SITE MUST BE INSPECTED BY THE DEPARTMENT OF PUBLIC WORKS (DPW). NO ADDITIONAL CONSTRUCTION ACTIVITY WILL BE AUTHORIZED WITHOUT THE APPROVAL OF DPW.
- ALL POINTS OF INGRESS AND EGRESS SHALL BE PROTECTED TO PREVENT TRACKING OF MUD INTO PUBLIC WAYS. DURING CONSTRUCTION, EVERY MEANS WILL BE TAKEN TO CONTROL SOIL EROSION AND SILTATION. IF NECESSARY A WASH RACK MAY NEED TO BE ESTABLISHED.
- EARTH DIKES, SEDIMENT TRAPS, ETC. WILL BE LOCATED AS SHOWN ON THESE DRAWINGS. FIELD CHANGES AND MINOR ADJUSTMENTS ARE PERMISSIBLE AS LONG AS THE INSTALLATION FUNCTIONS AND CONFORMS TO SPECIFICATIONS. THE SITE INSPECTOR PRIOR TO INSTALLATION MUST APPROVE ALL SUCH CHANGES. MAJOR CHANGES TO THE APPROVED PLAN WILL REQUIRE RE-APPROVAL BY THE HARFORD SOIL CONSERVATION DISTRICT.
- FOLLOWING INITIAL SOIL DISTURBANCE OR RE-DISTURBANCE PERMANENT OR TEMPORARY STABILIZATION SHALL BE COMPLETED WITHIN:
 - THREE CALENDAR DAYS ON SLOPES GREATER THAN 3:1, ALL WATERWAYS AND TO THE SURFACE OF ALL PERIMETER CONTROLS.
 - SEVEN CALENDAR DAYS AS TO ALL OTHER DISTURBED OR GRADED AREAS OF THE PROJECT SITE.
- DUST CONTROL MUST BE MANAGED AS PART OF ALL SEDIMENT CONTROL PLANS. FAILURE TO DO SO IS A VIOLATION OF THIS PLAN.
- SEDIMENT BASINS MUST BE BUILT TO DESIGN SPECIFICATION AS SHOWN ON THE PLAN. IF THE BASIN IS TO BE USED AT A FUTURE SWM FACILITY, THE BASIN WILL BE BUILT IN ACCORDANCE WITH THE LATEST MD-378 STANDARDS AND SPECIFICATIONS. SPECIFIED MATERIALS MUST BE USED. NO CHANGED OR MODIFICATIONS WILL BE MADE WITHOUT WRITTEN AUTHORIZATION OF THE HARFORD COUNTY SOIL CONSERVATION DISTRICT.
- TEMPORARY FENCING SHALL BE PLACED AROUND ALL SEDIMENT BASINS, TRAPS, AND PONDS DURING CONSTRUCTION AND SITE GRADING.
- AT THE END OF EACH WORKING DAY ALL SEDIMENT CONTROL PRACTICES WILL BE INSPECTED AND LEFT OPERATION. A WEEKLY LOG WILL BE KEPT IN ACCORDANCE WITH NOI/NPDES REGULATIONS. A COPY OF THE APPROVED SEDIMENT CONTROL PLANS SHALL BE AVAILABLE AT THE SITE AT ALL TIMES.
- ENSURE POSITIVE DRAINAGE TO ALL ROAD INLETS DURING ALL PHASES OF ROAD CONSTRUCTION TO ENSURE POSITIVE FLOW TO TRAPS AND OR BASINS.
- CUT AND/OR FILL SHALL BE DONE IN CONFORMANCE WITH 2011 EROSION AND SEDIMENT CONTROL STANDARD AND SPECIFICATIONS FOR LAND GRADING.
- SURFACE FLOWS OVER CUT AND FILL SLOPES SHALL BE CONTROLLED BY EITHER REDIRECTING FLOWS FROM TRAVERSING THE SLOPES OR BY INSTALLING MECHANICAL DEVICES TO SAFELY CONVEY WATER DOWN SLOPES WITHOUT CAUSING EROSION.
- OFF-SITE WASTE OR BORROW AREAS SHALL HAVE AN APPROVED EROSION AND SEDIMENT CONTROL PLAN PRIOR TO THE IMPORT OR EXPORT OF MATERIAL TO/FROM THE PROJECT SITE.
- ALL MATERIAL ORIGINATING FROM THE DEVELOPMENT OF THE PROPERTY AND DEPOSITED ON THE PUBLIC RIGHT-OF-WAY SHALL BE IMMEDIATELY REMOVED.
- STORM DRAIN INLETS AND OUTLETS SHALL BE PROTECTED PER 2011 EROSION AND SEDIMENT CONTROL STANDARDS AND SPECIFICATIONS
- TOPSOIL, LIMING, FERTILIZING, SEEDING, MULCHING, SOD, ETC. ARE ALL AN ESSENTIAL PART OF THE SEDIMENT CONTROL PLAN AND MUST BE COMPLETED ALONG WITH ALL OTHER PRACTICES
- TRAPS TO BE REMOVED SHALL BE Dewatered AS PER THE 2011 EROSION AND SEDIMENT AND EROSION CONTROL STANDARDS AND SPECIFICATIONS.
- PRIOR TO REMOVAL OF TRAPS OR CONVERSION OF SEDIMENT BASINS TO SWM FACILITIES, THE STORM DRAINS WILL BE FLUSHED.
- SEDIMENT CONTROL PRACTICES WILL BE MAINTAINED UNTIL ALL DISTURBED AREAS FOR WHICH THE PRACTICES WERE INSTALLED HAVE BEEN STABILIZED. SEDIMENT CONTROL PRACTICES MAY BE REMOVED ONLY WITH THE AUTHORIZATION OF THE DPW INSPECTOR. ALL DISTURBED AREAS RESULTING FROM THE REMOVAL OF SEDIMENT CONTROL DEVICES SHALL BE STABILIZED IMMEDIATELY. REMOVAL PRIOR TO INSPECTOR'S APPROVAL CONSTITUTES A VIOLATION.

PERMANENT VEGETATIVE STABILIZATION NOTES

ALL DISTURBED AREAS WHICH ARE NOT BE PAVED, SHALL BE PERMANENTLY STABILIZED AS FOLLOWS:

- SEED BED PREPARATION: LOOSEN UPPER THREE INCH BY RAKING, DISCING, OR OTHER ACCEPTABLE MEANS AFTER SPREADING FOUR INCHES OF TOP SOIL
- SEEDING*:

FOR PERIODS OF MARCH 1 TO MAY 15 AND AUGUST 15 TO OCTOBER 15: SEED WITH 60 LBS. PER ACRE OF TALL FESCUE, 40 LBS. PER ACRE OF KENTUCKY BLUEGRASS, AND 20 LBS. PER ACRE OF PERENNIAL RYEGRASS.

FOR PERIOD OF MAY 16 TO AUGUST 14: SEED WITH 100 LBS. PER ACRE OF TALL

FESCUE AND 3 LBS. PER ACRE OF WEEPING LOVEGRASS OR 5 LBS. OF PEARL OR FOXTAIL MILLET.

FOR PERIOD OF OCTOBER 16 TO FEBRUARY 28:

OPTION 1: PROTECT THE SITE BY APPLYING TWO (2) TONS PER ACRE OF WELL ANCHORED STRAW MULCH AND SEED AS SOON AS POSSIBLE IN THE SPRING.

OPTION 2: USE SOD, PROVIDED THE GROUND IS SUITABLE AND THAWED; COMPLY WITH THE 2011 MARYLAND STANDARD AND SPECIFICATION ADDRESSING "SOD" (PAGES B.23 & B.24).

MULCHING SPECIFICATIONS:

MULCH SHALL BE APPLIED TO ALL SEEDED AREAS IMMEDIATELY AFTER SEEDING.

APPLY TWO (2) TONS PER ACRE OF STRAW OVER ALL SEEDED AREAS. IF A MULCH ANCHORING TOOL IS TO BE USED, THE RATE SHALL BE INCREASED TO 2.5 TONS PER ACRE. **

MULCH ANCHORING SHALL BE PERFORMED IMMEDIATELY FOLLOWING MULCH APPLICATION TO MINIMIZE LOSS BY WIND AND WATER. THE TYPE OF MULCH ANCHORING USED MUST COMPLY WITH THE 2011 MARYLAND STANDARD AND SPECIFICATIONS.

* IF OTHER SEED MIXES ARE TO BE SUBSTITUTED, THEY MUST COMPLY WITH THE 2011 MARYLAND STANDARD AND SPECIFICATIONS, B-4-5: "PERMANENT SEEDING", TABLE B-3 (PAGES B.26 TO B.31)

** IF A DIFFERENT TYPE OF MULCH IS TO BE SUBSTITUTED, THEY MUST COMPLY WITH THE 2011 MARYLAND STANDARD AND SPECIFICATIONS, B-4-3: "SEEDING AND MULCHING" (PAGES B.15 B.17)

TEMPORARY VEGETATIVE STABILIZATION

ALL DISTURBED AREAS WHICH ARE NOT BE PAVED, SHALL BE TEMPORARILY STABILIZED AS FOLLOWS:

A.) SEEDBED PREPARATION:

LOOSEN A MINIMUM OF THREE INCHES ALONG UPPER SOIL BY DISCING, RAKING OR OTHER ACCEPTABLE MEANS

B.) SEEDING*:

FOR PERIODS OF MARCH 1 TO APRIL 30 AND AUGUST 15 TO NOVEMBER 15: SEED WITH 2.5 BU. PER ACRE OF CEREAL RYE OR 40 LBS. PER ACRE OF ANNUAL RYEGRASS.

FOR PERIOD OF MAY 1 TO AUGUST 14:

SEED WITH 3 LBS. PER ACRE OF WEEPING LOVEGRASS OR 30 LBS. PER ACRE OF PEARL OR FOXTAIL MILLET.

FOR THE PERIOD OF NOVEMBER 16 TO FEBRUARY 28: PROTECT THE SITE BY APPLYING TWO (2) TONS PER ACRE OF WELL ANCHORED STRAW MULCH AND SEED AS SOON AS POSSIBLE IN THE SPRING

C.) MULCHING SPECIFICATIONS:

MULCH SHALL BE APPLIED TO ALL SEEDED AREAS IMMEDIATELY AFTER SEEDING.

APPLY TWO (2) TONS PER ACRE OF STRAW OVER ALL SEEDED AREAS. IF A MULCH ANCHORING TOOL IS TO BE USED, THE RATE SHALL BE INCREASED TO 2.5 TONS PER ACRE. **

MULCH ANCHORING SHALL BE PERFORMED IMMEDIATELY FOLLOWING MULCH APPLICATION TO MINIMIZE LOSS BY WIND AND WATER. THE TYPE OF MULCH ANCHORING USED MUST COMPLY WITH THE 2011 MARYLAND STANDARD AND SPECIFICATIONS.

* IF OTHER SEED MIXES ARE TO BE SUBSTITUTED, THEY MUST COMPLY WITH THE 2011 MARYLAND STANDARD AND SPECIFICATIONS, B-4-4: "TEMPORARY SEEDING", TABLE B-1 (PAGE B.20).

** IF A DIFFERENT TYPE OF MULCH IS TO BE USED, IT MUST COMPLY WITH THE 2011 MARYLAND STANDARD AND SPECIFICATION, B-4-3: "SEEDING AND MULCHING" (PAGES B.15 - B.17).

BEST MANAGEMENT PRACTICES FOR WORKING IN NONTIDAL WETLANDS, WETLAND BUFFERS, AND 100 YEAR FLOODPLAINS

- EXCESS FILL, CONSTRUCTION MATERIAL, OR DEBRIS SHALL BE STOCKPILED OR STORED IN NONTIDAL WETLANDS, NONTIDAL WETLAND BUFFERS, WATERWAYS, OR THE 100-YEAR FLOODPLAIN.
- PLACE MATERIALS IN A LOCATION AND MANNER WHICH DOES NOT ADVERSELY IMPACT SURFACE OR SUBSURFACE WATER FLOW INTO OR OUT OF NONTIDAL WETLANDS, NONTIDAL WETLAND BUFFERS, WATERWAYS, OR THE 100-YEAR FLOODPLAIN.
- DO NOT USE THE EXCAVATED MATERIAL AS BACKFILL IF IT CONTAINS WASTE METAL PRODUCTS, UNSIGHTLY DEBRIS, TOXIC MATERIAL, OR ANY OTHER DELETERIOUS SUBSTANCE.
- PLACE HEAVY EQUIPMENT ON MATS OR SUITABLY OPERATE THE EQUIPMENT TO PREVENT DAMAGE TO NONTIDAL WETLANDS, NONTIDAL WETLAND BUFFERS, WATERWAYS, OR THE 100-YEAR FLOODPLAIN.
- REPAIR AND MAINTAIN ANY SERVICABLE STRUCTURE OR FILL SO THERE IS NO PERMANENT LOSS OF NONTIDAL WETLANDS, NONTIDAL WETLAND BUFFERS, OR WATERWAYS, OR PERMANENT MODIFICATION OF THE 100-YEAR FLOODPLAIN IN EXCESS OF THAT LOST UNDER THE ORIGINALLY AUTHORIZED STRUCTURE OR FILL.
- RECTIFY ANY NONTIDAL WETLANDS, WETLAND BUFFERS, WATERWAYS, OR 100-YEAR FLOODPLAIN TEMPORARILY IMPACTED BY ANY CONSTRUCTION.
- ALL STABILIZATION IN THE NONTIDAL WETLAND AND NONTIDAL WETLAND BUFFER SHALL CONSIST OF THE FOLLOWING SPECIES: ANNUAL RYEGRASS (LOLIUM MULTIFLORUM), MILLET (SETARIA ITALICA), BARLEY (HORDEUM SP.), OATS (UNIOLA SP) AND/OR RYE (SECALE CEREALE). THESE SPECIES WILL ALLOW FOR THE STABILIZATION OF THE SITE WHILE ALSO ALLOWING FOR THE VOLUNTARY REVEGETATION OF NATURAL WETLAND SPECIES. OTHER NON-PERSISTENT VEGETATION MAY BE ACCEPTABLE, BUT MUST BE APPROVED BY THE NONTIDAL WETLANDS AND WATERWAYS DIVISION. KENTUCKY 31 FESCUE SHALL NOT BE UTILIZED IN WETLAND OR BUFFER AREAS. THE AREA SHOULD BE SEEDED AND MULCHED TO REDUCE EROSION AFTER CONSTRUCTION ACTIVITIES HAVE BEEN COMPLETED.
- AFTER INSTALLATION HAS BEEN COMPLETED, MAKE POST CONSTRUCTION GRADES AND ELEVATIONS THE SAME AS THE ORIGINAL GRADES AND ELEVATIONS IN TEMPORARILY IMPACTED AREAS.
- TO PROTECT AQUATIC SPECIES, IN-STREAM WORK IS PROHIBITED AS DETERMINED BY THE CLASSIFICATION OF THE STREAM:
 - USE I WATERS (WITHOUT YELLOW PERCH): IN-STREAM WORK SHALL NOT BE CONDUCTED DURING THE PERIOD MARCH 1 THROUGH JUNE 15, INCLUSIVE DURING ANY YEAR.
 - USE I WATERS (WITH YELLOW PERCH): IN-STREAM WORK SHALL NOT BE CONDUCTED DURING THE PERIOD FEBRUARY 15 THROUGH JUNE 15, INCLUSIVE DURING ANY YEAR.
 - USE II WATERS: IN-STREAM WORK SHALL NOT BE CONDUCTED DURING THE PERIOD OCTOBER 1 THOROUGH APRIL 30, INCLUSIVE, DURING ANY YEAR.
 - USE IV WATERS: IN-STREAM WORK SHALL NOT BE CONDUCTED DURING THE PERIOD MARCH 1 THROUGH MAY 31, INCLUSIVE, DURING ANY YEAR.
- STORMWATER RUNOFF FROM IMPERVIOUS SURFACES SHALL BE CONTROLLED TO PREVENT THE WASHING OF DEBRIS INTO THE WATERWAY.
- CULVERTS SHALL BE CONSTRUCTED AND ANY RIPRAP PLACED SO AS NOT TO OBSTRUCT THE MOVEMENT OF AQUATIC SPECIES, UNLESS THE PURPOSE OF THE ACTIVITY IS TO IMPOUND WATER.

STANDARD NOTES FOR WORKING IN FLOODPLAIN

4
ED-03
NOT TO SCALE

ENGINEER'S CERTIFICATION

I CERTIFY THAT THIS PLAN FOR EROSION AND SEDIMENT CONTROL AND STORMWATER MANAGEMENT REPRESENTS A PRACTICAL AND WORKABLE PLAN BASED ON MY PERSONAL KNOWLEDGE OF THE SITE CONDITIONS AND THAT IT WAS PREPARED IN ACCORDANCE WITH THE 2011 MARYLAND STANDARD AND SPECIFICATIONS FOR SOIL EROSION AND SEDIMENT CONTROL.

ENGINEER DATE

OWNER'S CERTIFICATION



I WE CERTIFY THAT ALL DEVELOPMENT AND CONSTRUCTION WILL BE DONE ACCORDING TO THIS PLAN OF DEVELOPMENT AND PLAN FOR EROSION AND SEDIMENT CONTROL AND THAT ANY RESPONSIBLE PERSONNEL INVOLVED IN THE CONSTRUCTION PROJECT WILL HAVE A CERTIFICATION OF ATTENDANCE AT A DEPARTMENT OF NATURAL RESOURCES APPROVED TRAINING PROGRAM FOR THE CONTROL OF SEDIMENT AND EROSION BEFORE BEGINNING THE PROJECT. I ALSO AUTHORIZE PERIODIC ONSITE INSPECTION BY THE HARFORD SOIL CONSERVATION DISTRICT OR THEIR AUTHORIZED AGENTS, OR AS DEEMED NECESSARY.

OWNER DATE

SITE ANALYSIS
 TOTAL SITE AREA: 118957 SF / 2.73 ACRES
 TOTAL DISTURBED AREA: 118957 SF / 2.73 ACRES
 TOTAL AREA TO BE PAVED: 0.0 SF / 0.0 ACRES
 AREA TO BE STABILIZED: 118957 SF / 2.73 ACRES
 TOTAL CUT*: 2191 CU YD
 TOTAL FILL: 1801 CU YD
 TOPSOIL: 614 CU YD
 NPDES I.D. POINT N: 641669.2051 E: 1504880.4859'

* ANY EXCESS MATERIAL SHALL BE REMOVED TO A SITE WITHIN CURRENT ENS PLAN AND PERMIT

S/C PLAN # 59914	Revisions	HARFORD COUNTY, MARYLAND	
GRA-004622-2025		EDGEWATER VILLAGE PARK	STREAM RESTORATION
		ESC DETAILS	
		Drawn By : CA	AS NOTED
		Designed By : CA	Date : SEPTEMBER 2025
		Reviewed By : BWA	
Drawing No.	ED-03	of	Sheet No.

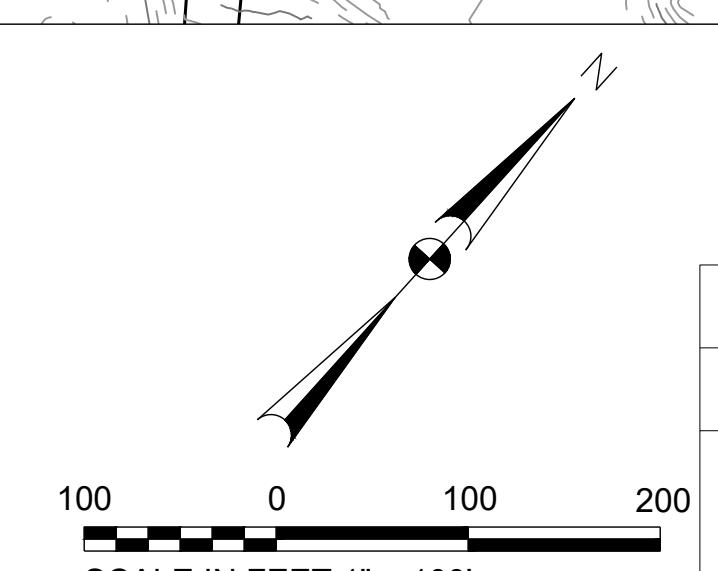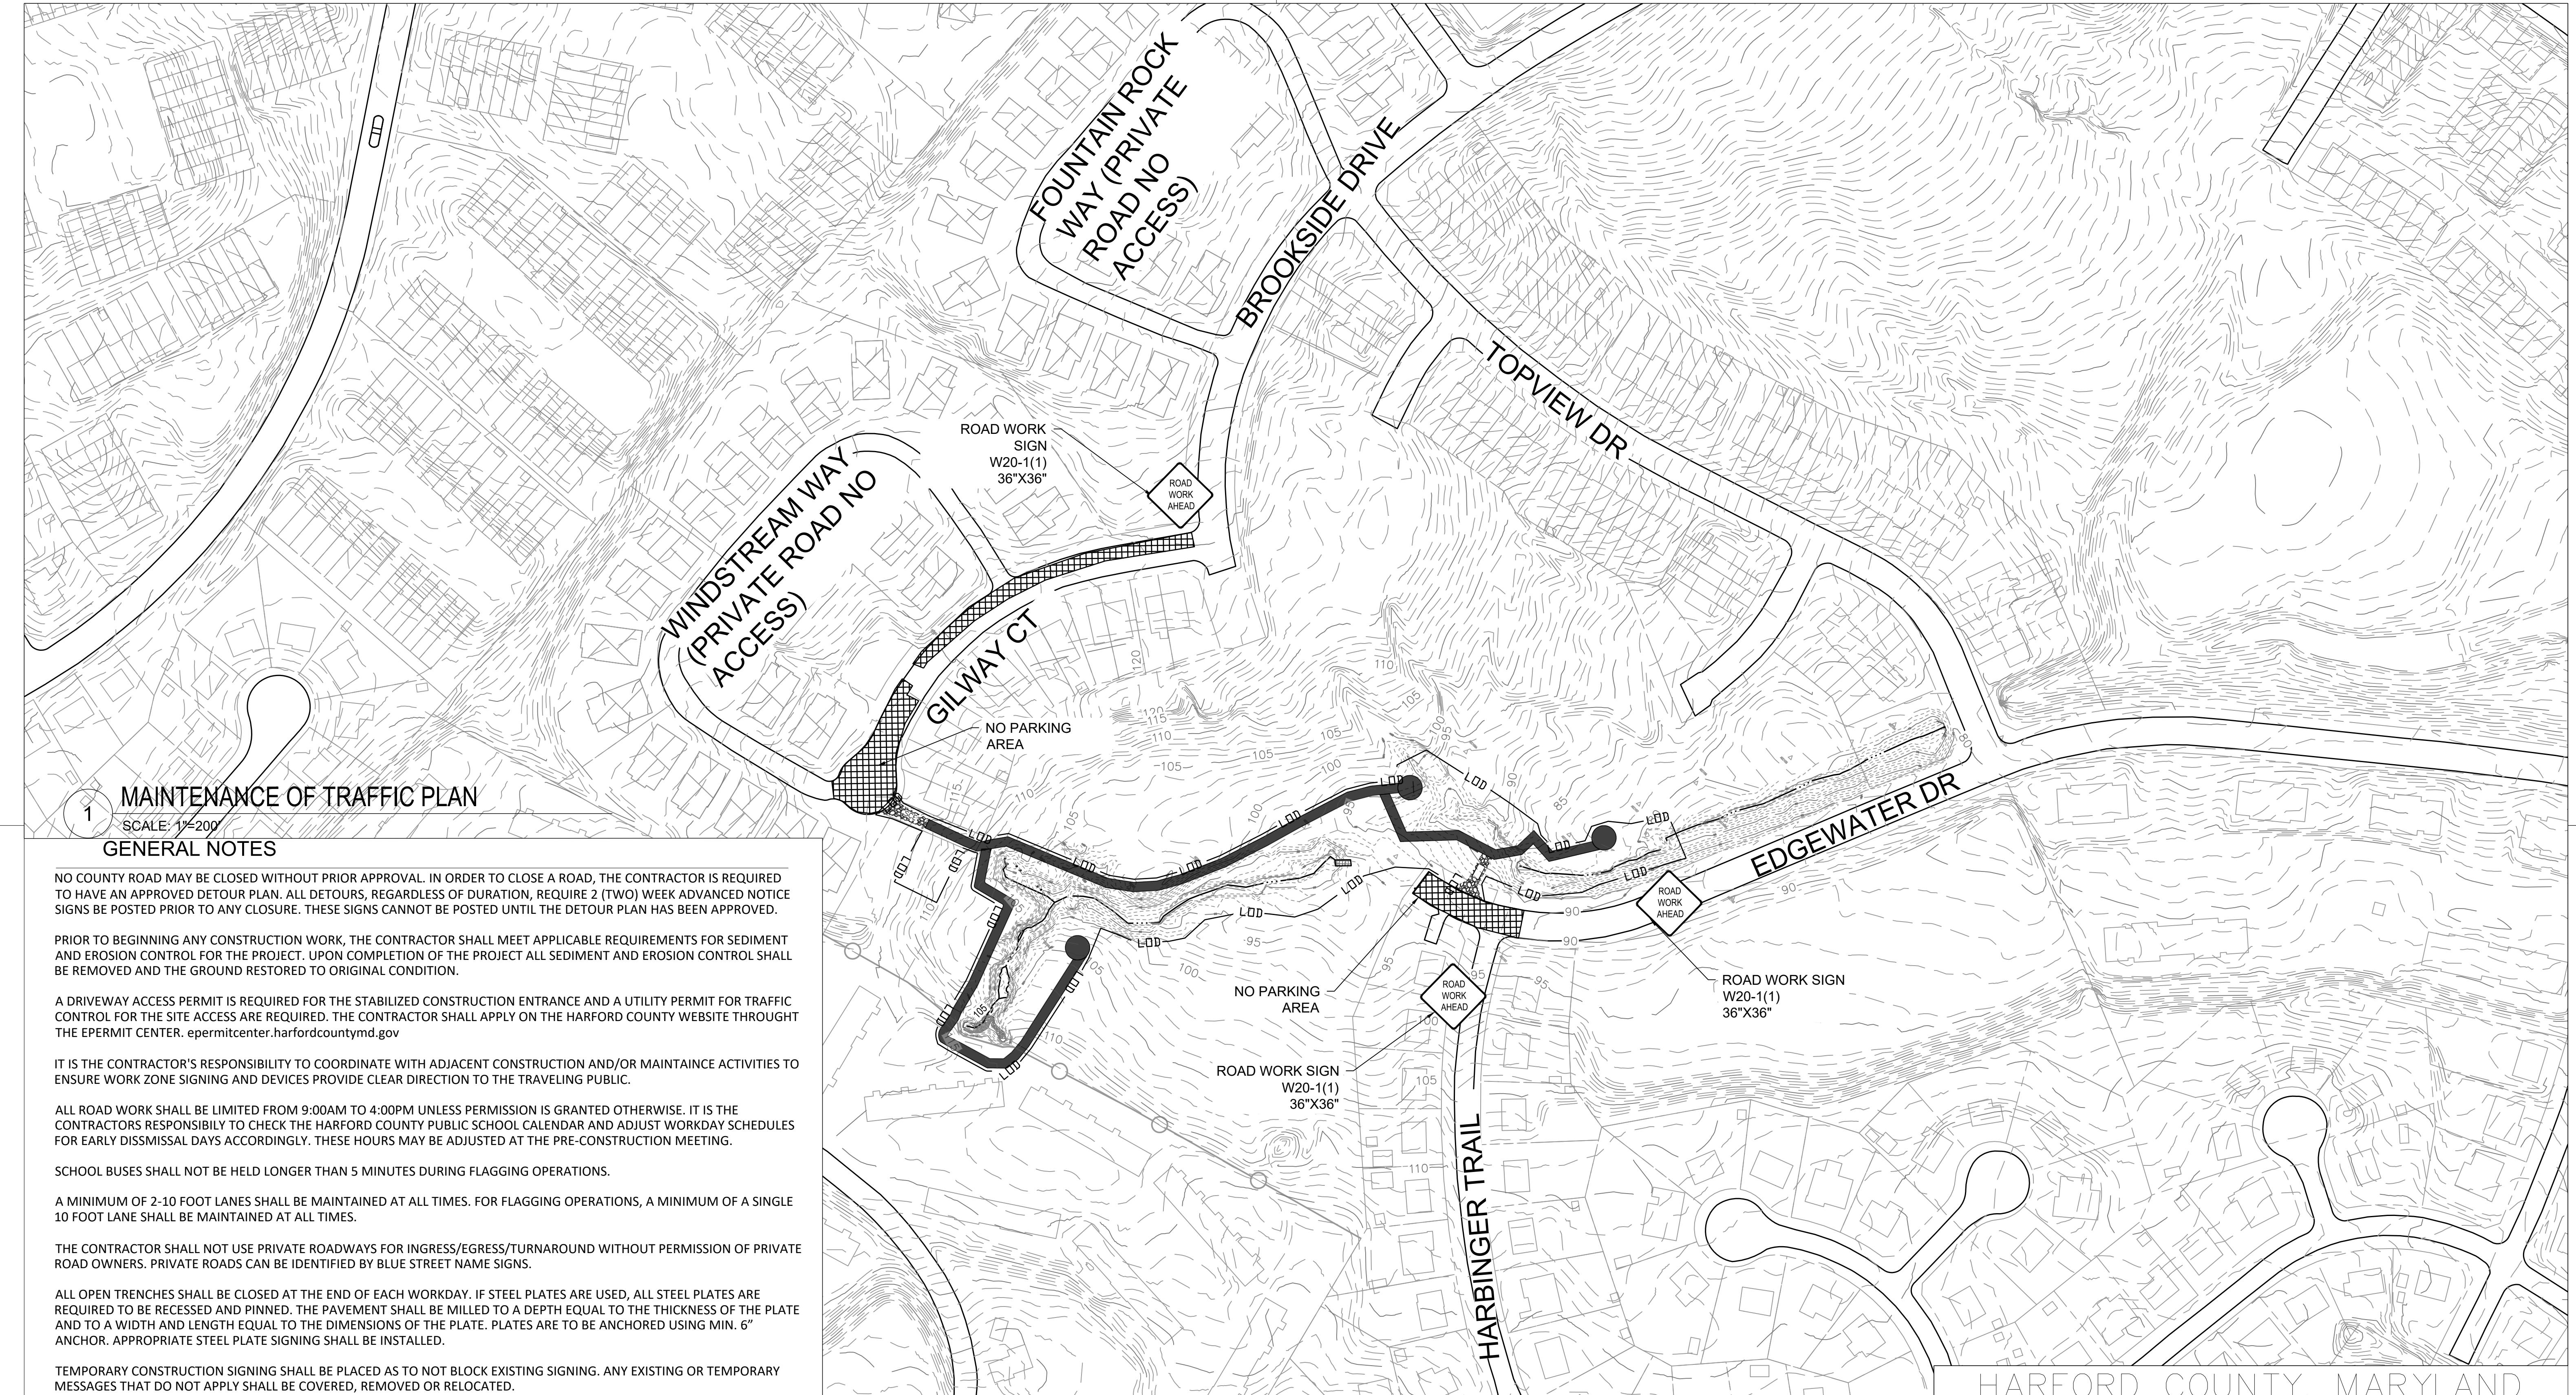


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S/C PLAN # 59914	Revisions
GRA-004622-2025	
SIGN AND SEAL	


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Designed By : CA	Date : SEPTEMBER 2025
Reviewed By : BWA	
Drawing No. MT-01	of MT-01
Sheet No.	49 of 65





HARFORD COUNTY MARYLAND

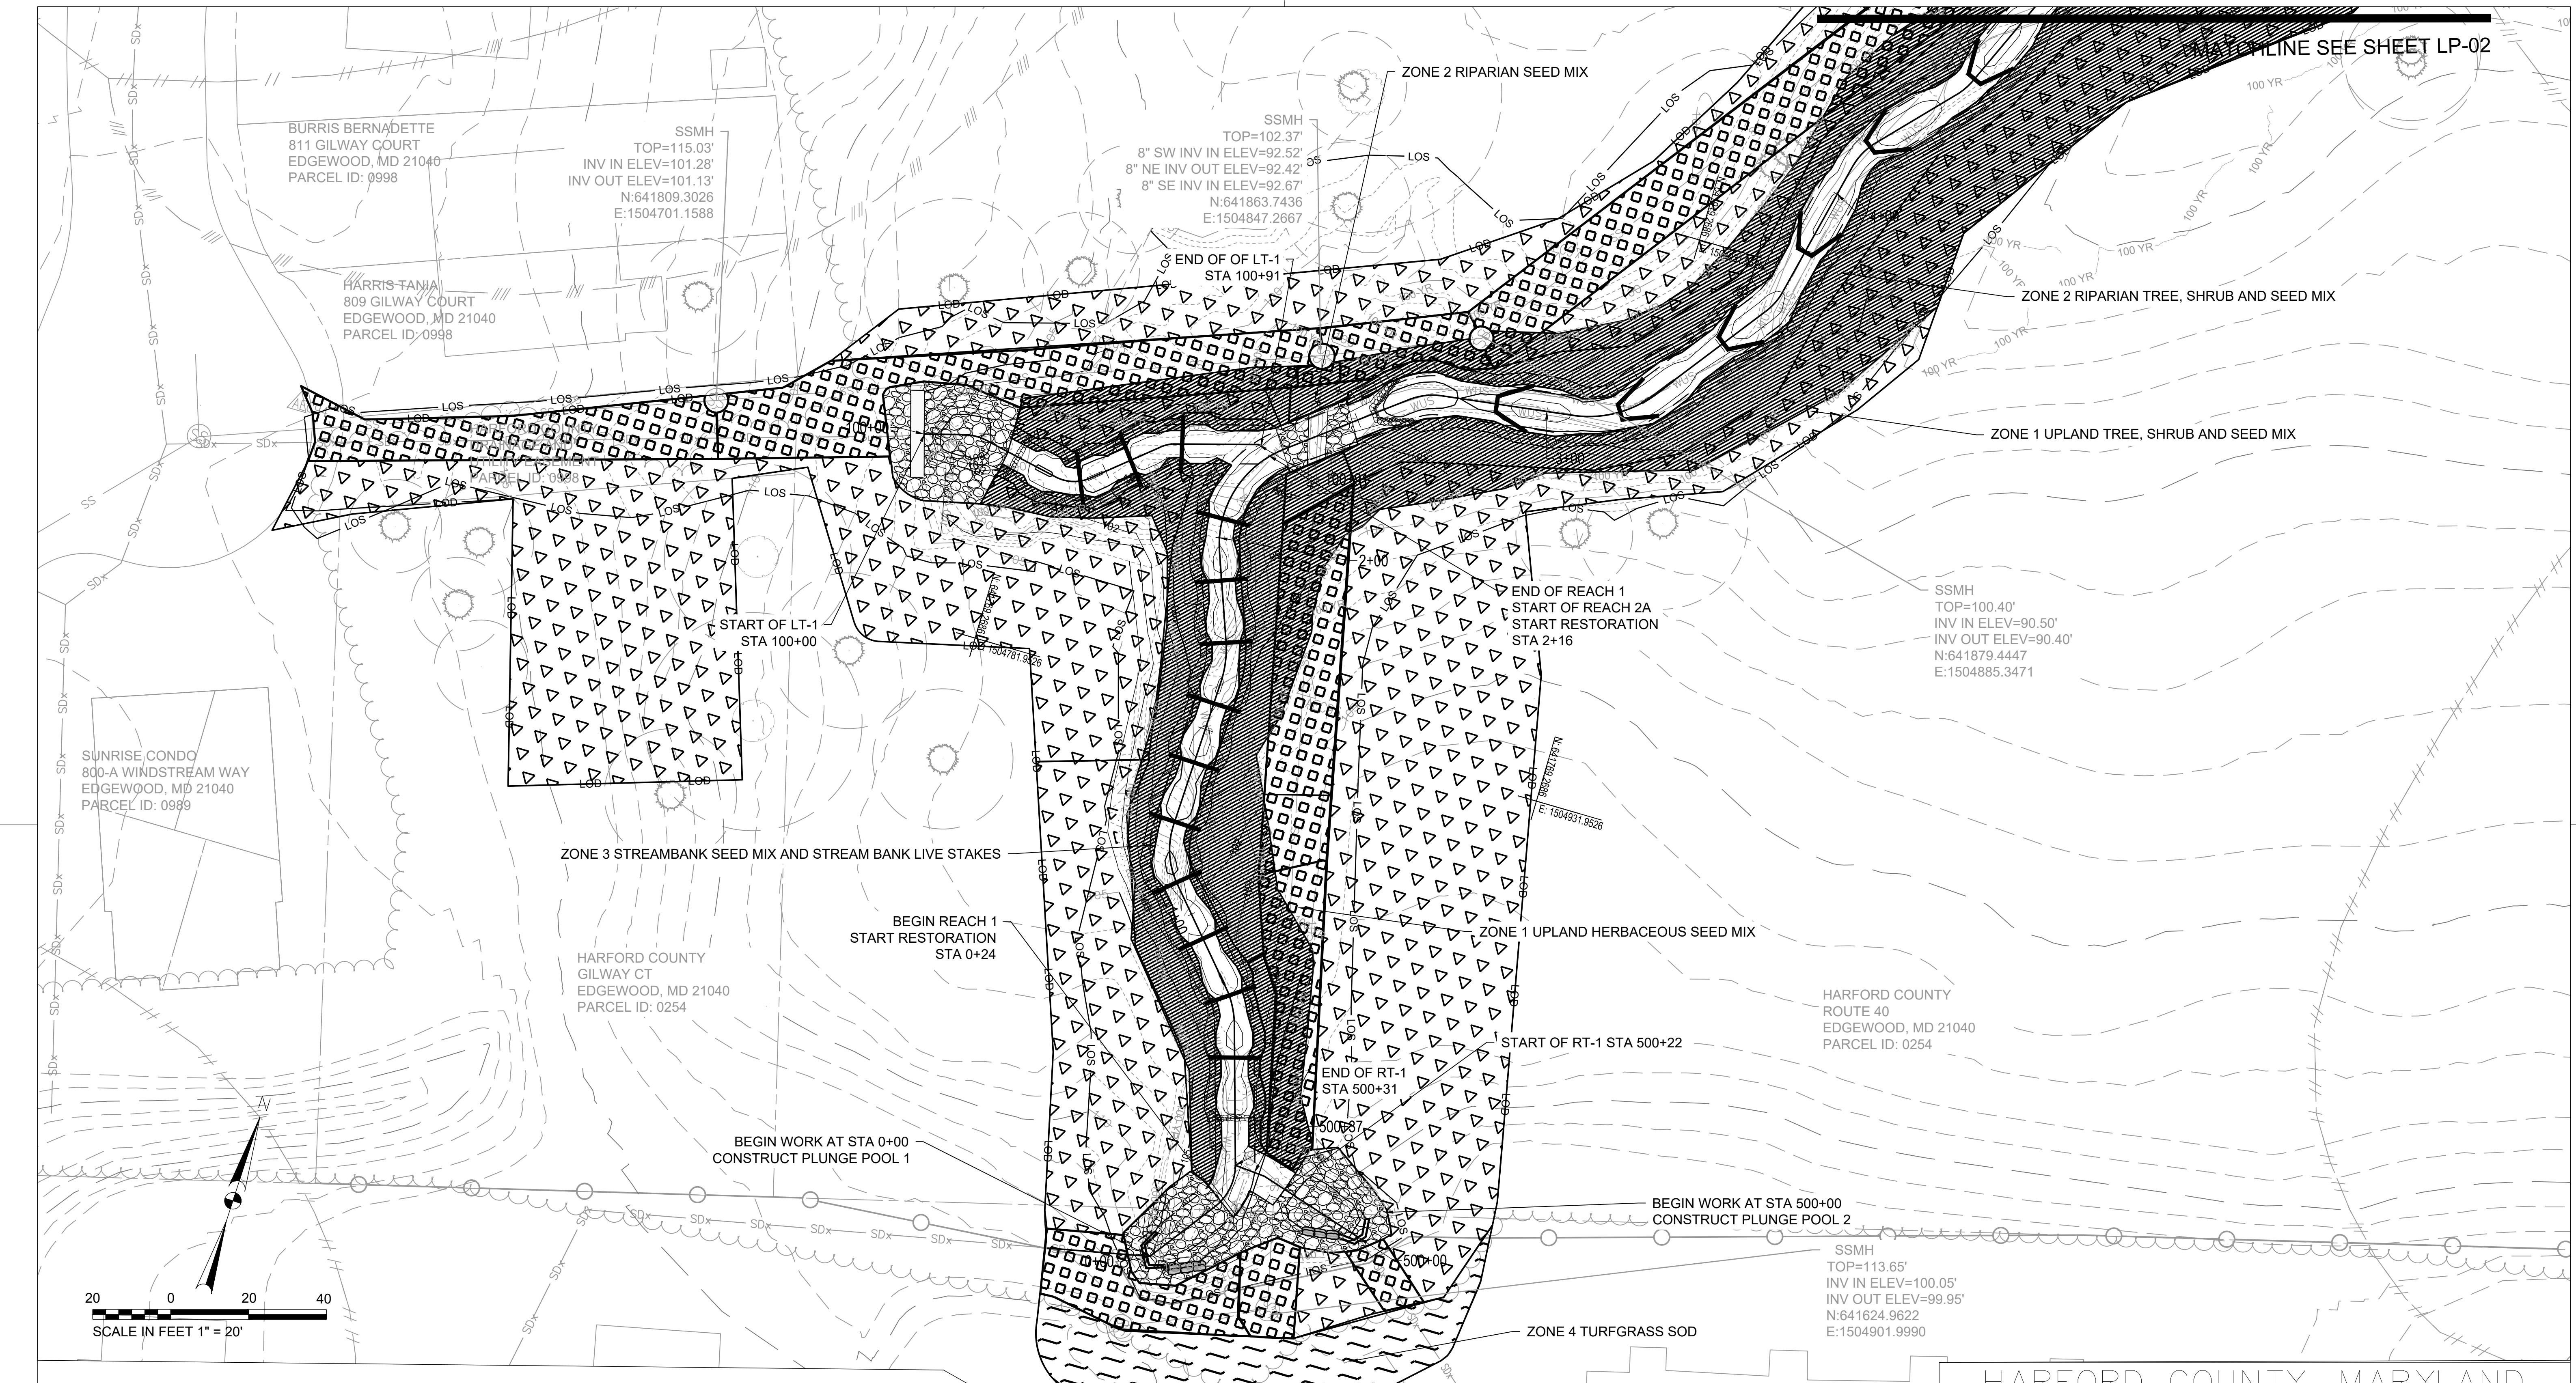EDGEWATER VILLAGE PARK STREAM RESTORATION LANDSCAPING PLAN


Drawn By : CA	Scale : 1" = 20'
Designed By : CA	Date : SEPTEMBER 2025
Reviewed By : BWA	
Drawing No. LP-01 of LP-02	Sheet No. 50 of 65

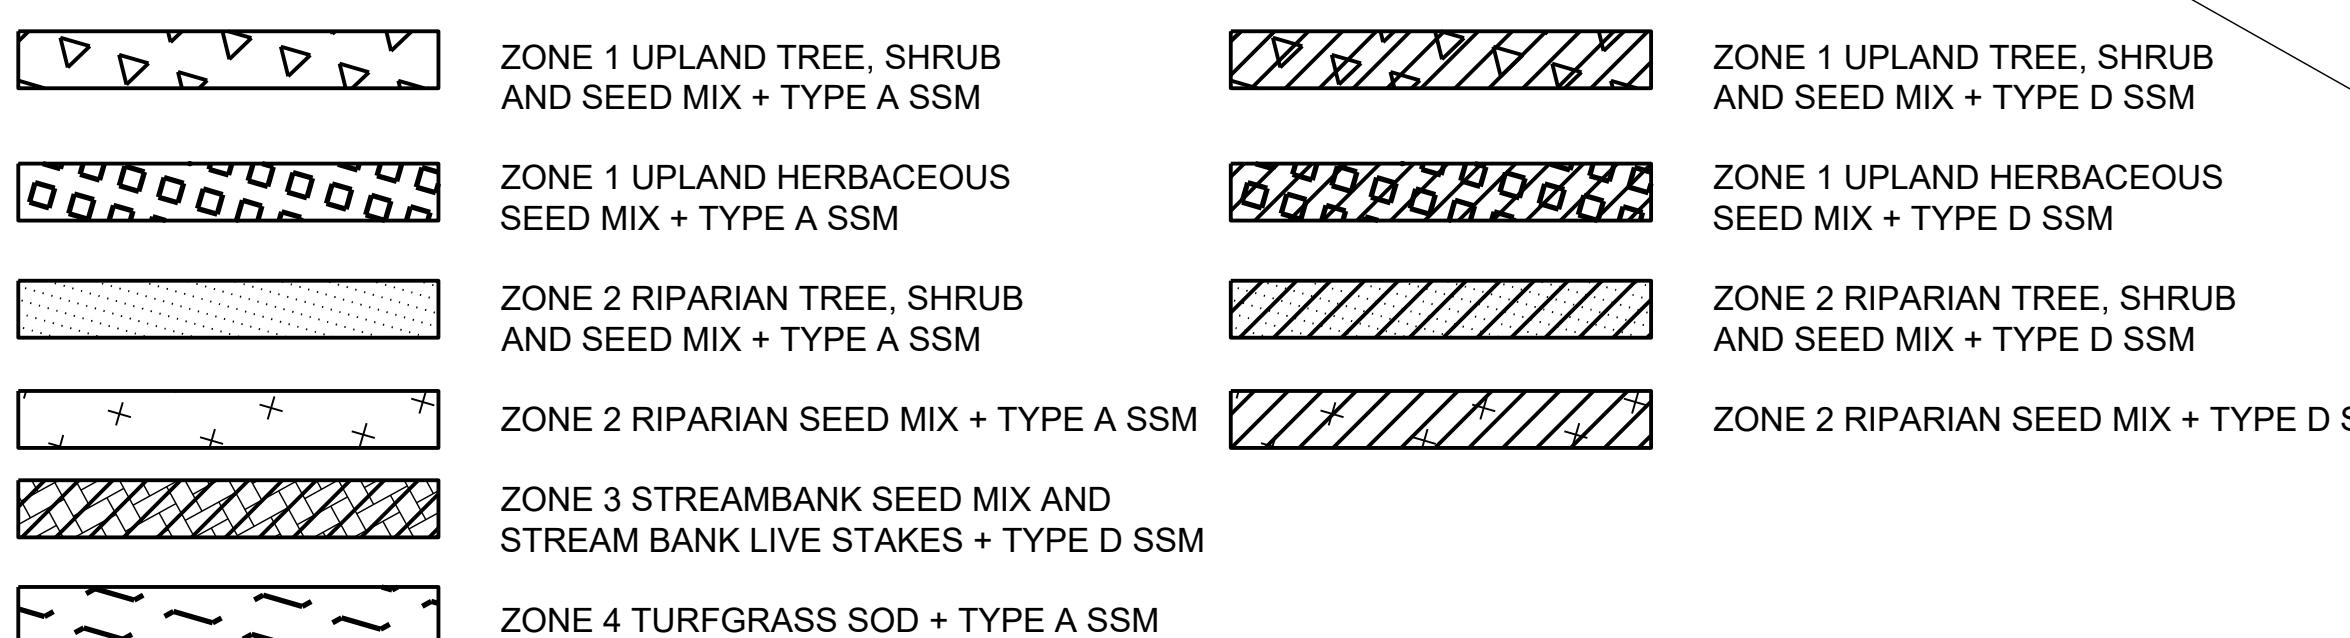

PROFESSIONAL CERTIFICATION

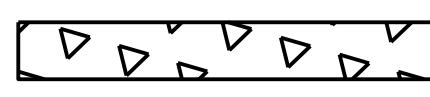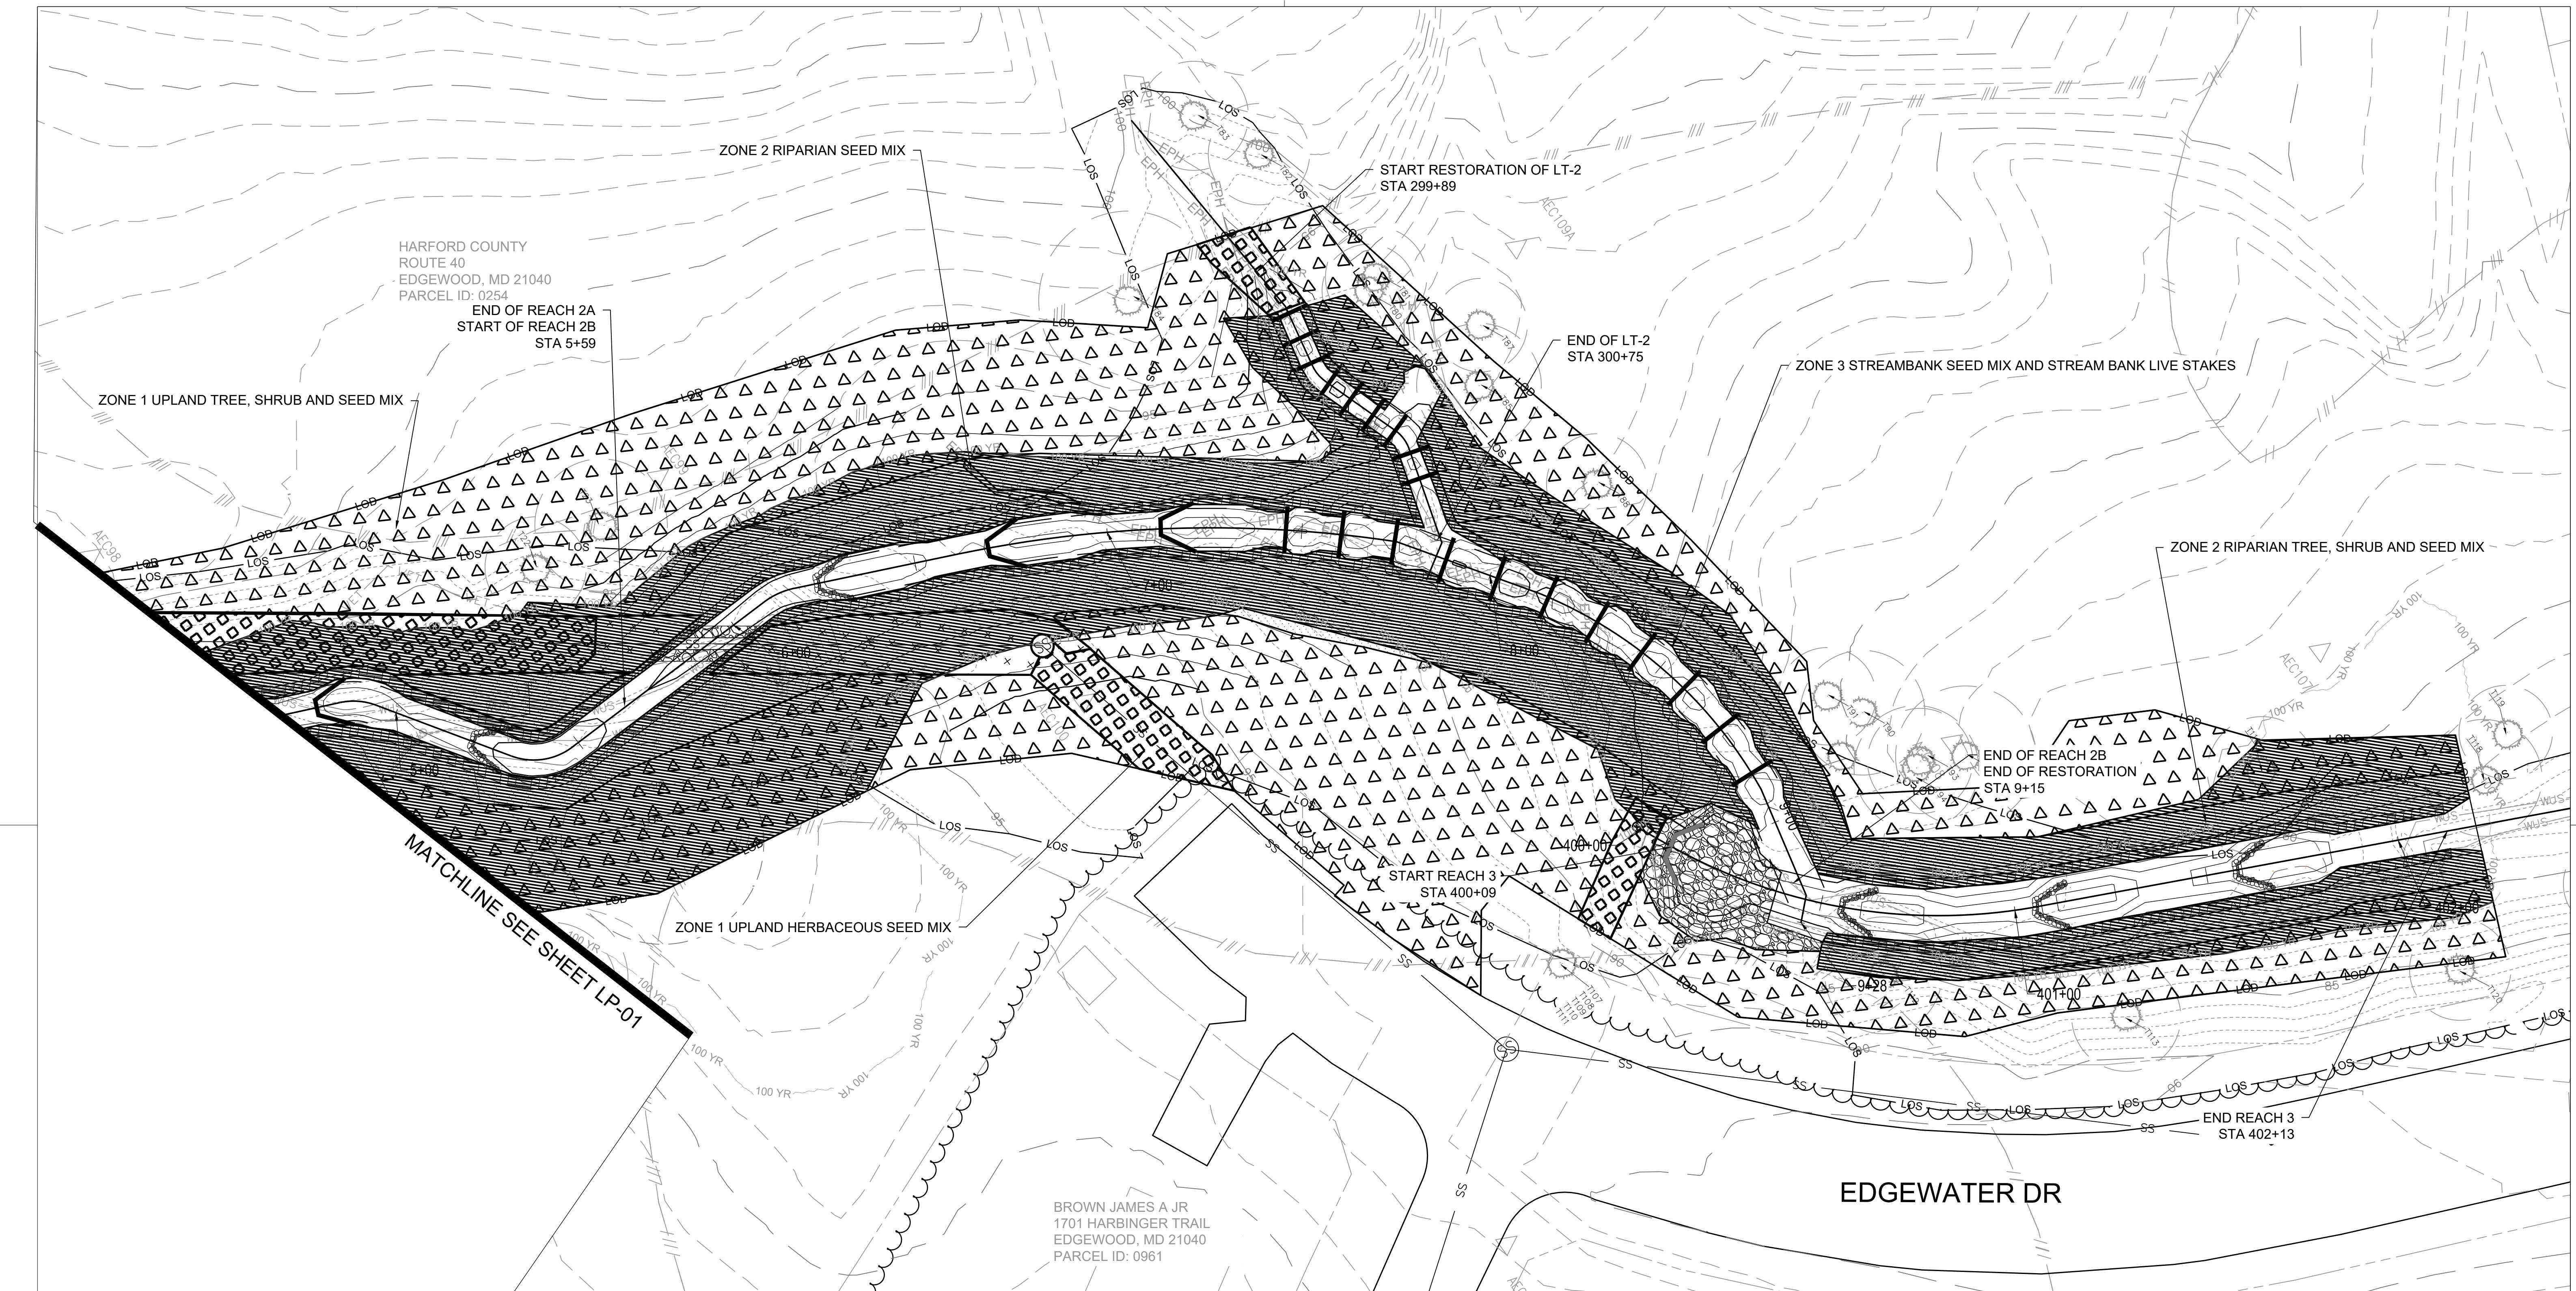

ZONE 1 UPLAND TREE, SHRUB AND SEED MIX + TYPE A SSM

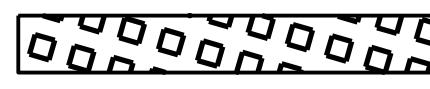


ZONE 1 UPLAND HERBACEOUS SEED MIX + TYPE A SSM



ZONE 2 RIPARIAN TREE, SHRUB AND SEED MIX + TYPE A SSM



ZONE 3 STREAMBANK SEED MIX AND STREAM BANK LIVE STAKES + TYPE D SSM

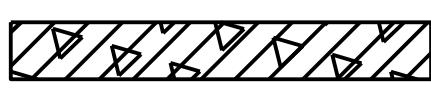

ZONE 1 UPLAND TREE, SHRUB AND SEED MIX + TYPE D SSM




ZONE 1 UPLAND HERBACEOUS SEED MIX + TYPE D SSM



ZONE 2 RIPARIAN TREE, SHRUB AND SEED MIX + TYPE D SSM



ZONE 2 RIPARIAN SEED MIX + TYPE D SSM

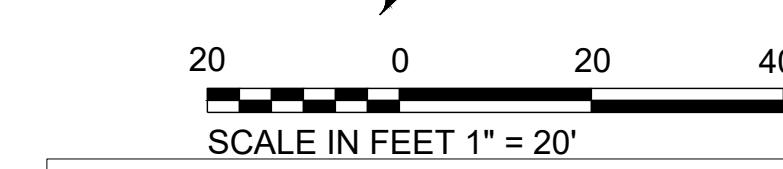

SCORE IN PEEPS 1 20

PROFESSIONAL CERTIFICATION

S/C PLAN # 59914	Revisions
GRA-004622-2025	
SIGN AND SEAL	

HARFORD COUNTY, MARYLAND

EDGEWATER VILLAGE PARK STREAM RESTORATION LANDSCAPING PLAN

drawn By : _____ CA
designed By : _____ CA
reviewed By : _____ BWA

Scale : 1" = 20'
Date : SEPTEMBER 2025

Sheet No. 51 of 60

ZONE 1: UPLAND SEED MIX - 1.79 ACRES			
ERNMX-731 OR APPROVED EQUAL, 20 LBS/ACRE			
SCIENTIFIC NAME	COMMON NAME	TYPE	%TOTAL COMPOSITION
SCHIZACHYRIUM SCOPARIUM	LITTLE BLUESTEM	HERB	65.90%
ELYMUS VIRGINICUS	VIRGINIA WILDRYE	HERB	17.00%
RUDBECKIA HIRTA	BLACKEYED SUSAN	HERB	3.00%
LESPEDEZA VIRGINICA	SLENDER LESPEDEZA	HERB	2.50%
ASCLEPIAS TUBEROSA	BUTTERFLY MILKWEED	HERB	2.00%
CHAMAECRISTA FASCICULATA	PARTRIDGE PEA	HERB	1.50%
SENNA HEBECARPA	WILD SENNA	HERB	1.50%
ASTER PIOSUS	HEATH ASTER	HERB	1.20%
PYCNANTHEMUM TENUIFOLIUM	NARROWLEAF MOUNTAINMINT	HERB	1.20%
AQUILEGIA CANDENSIS	EASTERN COLUMBINE	HERB	1.00%
GEUM CANADENSE	WHITE AVENS	HERB	1.00%
CHAMAECRISTA NICTITANS	SENSITIVE PEA	HERB	0.50%
SISYRINCHIUM ANGUSTIFOLIUM	NARROWLEAF BLUE EYED GRASS	HERB	0.50%
OENOTHERA FRUTICOSA	SUNDROPS	HERB	0.30%
SOLIDAGO BICOLOR	WHITE GOLDENROD	HERB	0.30%
SOLIDAGO NEMORALIS	GRAY GOLDENROD	HERB	0.30%
ASTER LATERIFLORUS	CALICO ASTER	HERB	0.20%
SOLIDAGO JUNcea	EARLY GOLDENROD	HERB	0.10%

ZONE 1: UPLAND TREE AND SHRUB MIX - 1.48 ACRES					
SCIENTIFIC NAME	COMMON NAME	TYPE	1" CALIPER/#7 CONTAINER	5" CALIPER/#5 CONTAINER	4' TALL/#2 CONTAINER
QUERCUS ALBA	WHITE OAK	SINGLE STEM TREE	0	39	0
POPULUS GRANDIDENTATA	BIG TOOTH ASPEN	SINGLE STEM TREE	28	0	0
LIQUIDAMBAR STYRACIFLUA	AMERICAN SWEETGUM	SINGLE STEM TREE	24	0	0
QUERCUS RUBRA	RED OAK	SINGLE STEM TREE	0	42	0
QUERCUS PALUSTRIS	PIN OAK	SINGLE STEM TREE	0	45	0
LIRIODENDRON TULIPIFERA	TULIP TREE	SINGLE STEM TREE	43	0	0
ACER RUBRUM	RED MAPLE	SINGLE STEM TREE	38	0	0
VIBURNUM ACERIFOLIUM	MAPLELEAF VIBURNUM	SHRUB	0	0	15
VACCINIUM PALLIDUM	LOWBUSH BLUEBERRY	SHRUB	0	0	14
		TOTAL	133	126	29



ZONE 2: RIPARIAN SEED MIX - 0.45 ACRES			
SCIENTIFIC NAME	COMMON NAME	TYPE	%TOTAL COMPOSITION
SORGHASTRUM NUTANS	INDIANGRASS	HERB	39.70%
ELYMUS VIRGINICUS	VIRGINIA WILDRYE	HERB	20.00%
PANICUM VIRGATUM	SWITCHGRASS	HERB	18.00%
PANICUM RIGIDULUM	REDTOP PANICGRASS	HERB	10.00%
CHAMAECRISTA FASCICULATA	PARTERIDGE PEA	HERB	3.00%
RUDBECKIA HIRTA	BLACKEYED SUSAN	HERB	3.00%
HELIOPSIS HELIANTHOIDES	OXEYE SUNFLOWER	HERB	2.00%
ASCLEPIAS INCARNATA	SWAMP MILKWEED	HERB	1.00%
VERNONIA NOVEBORACENSIS	NEW YORK IRONWEED	HERB	0.90%
EUPATORIUM PERFORIATUM	BONESET	HERB	0.80%
HELENIUM AUTUMNALE	COMMON SNEEZEWEED	HERB	0.80%
SOLIDAGO RUGOSA	WRINKLELEAF GOLDENROD	HERB	0.80%

ZONE 2: RIPARIAN TREE AND SHRUB MIX - 0.40 ACRES					
SCIENTIFIC NAME	COMMON NAME	TYPE	1" CALIPER/#7 CONTAINER	5" CALIPER/#5 CONTAINER	4' TALL/#2 CONTAINER
LIQUIDAMBAR STYRACIFLUA	AMERICAN SWEETGUM	SINGLE STEM TREE	12	0	0
ACER RUBRUM	RED MAPLE	SINGLE STEM TREE	11	0	0
BETULA NIGRA	RIVER BIRCH	SINGLE STEM TREE	5	0	0
PLATANUS OCCIDENTALIS	AMERICAN SycAMORE	SINGLE STEM TREE	10	0	0
QUERCUS PHELLOS	WILLOW OAK	SINGLE STEM TREE	0	10	0
ALNUS SERRULATA	SMOOTH ALDER	MULTI STEM TREE	10	0	0
QUERCUS BICOLOR	SWAMP WHITE OAK	SINGLE STEM TREE	0	10	0
LINDERA BENZIN	SPICEBUSH	SHRUB	0	0	8
		TOTAL	48	20	8

STREAMBANK SEED MIX - 0.12 ACRES			
ERNMX-733 OR APPROVED EQUAL, 20 LBS/ACRE			
SCIENTIFIC NAME	COMMON NAME	TYPE	%TOTAL COMPOSITION
CAREX VULPINOIDEA	FOX SEDGE	HERB	25.00%
ELYMUS VIRGINICUS	VIRGINIA WILDRYE	HERB	18.00%
PANICUM RIGIDULUM	REDTOP PANICGRASS	HERB	17.00%
CAREX LURIDA	LURID SEDGE	HERB	16.70%
CAREX SCOPARIA	BLUNT BROOM SEDGE	HERB	10.00%
CAREX CRINITA	FRINGED SEDGE	HERB	3.00%
JUNCUS EFFUSUS	SOFT RUSH	HERB	3.00%
ASCLEPIAS INCARNATA	SWAMP MILKWEED	HERB	2.00%
EUPATORIUM PERFORIATUM	BONESET	HERB	1.00%
HELENIUM AUTUMNALE	COMMON SNEEZEWEED	HERB	1.00%
JUNCUS TENUIS	PATH RUSH	HERB	1.00%
VERNONIA NOVEBORACENSIS	NEW YORK IRONWEED	HERB	1.00%
SOLIDAGO RUGOSA	WRINKLELEAF GOLDENROD	HERB	0.70%
MIMULUS RINGENS	SQUARE STEMMED MONKEYFLOWER	HERB	0.30%
SCIRPUS CYPERINUS	WOOLGRASS	HERB	0.30%

ZONE 3: STREAMBANK LIVE STAKES MIX - 0.12 ACRES		
SCIENTIFIC NAME	COMMON NAME	QUANTITY
SALIX NIGRA	BLACK WILLOW	148
CORNUS AMOMUM	SILKY DOGWOOD	148
CORNUS SERICEA	RED OSIER DOGWOOD	148
SALIX SERICEA	SILKY WILLOW	147
	TOTAL	591





ZONE 4: TURF SEED	
AREA	UNITS
1,581	SQUARE FEET

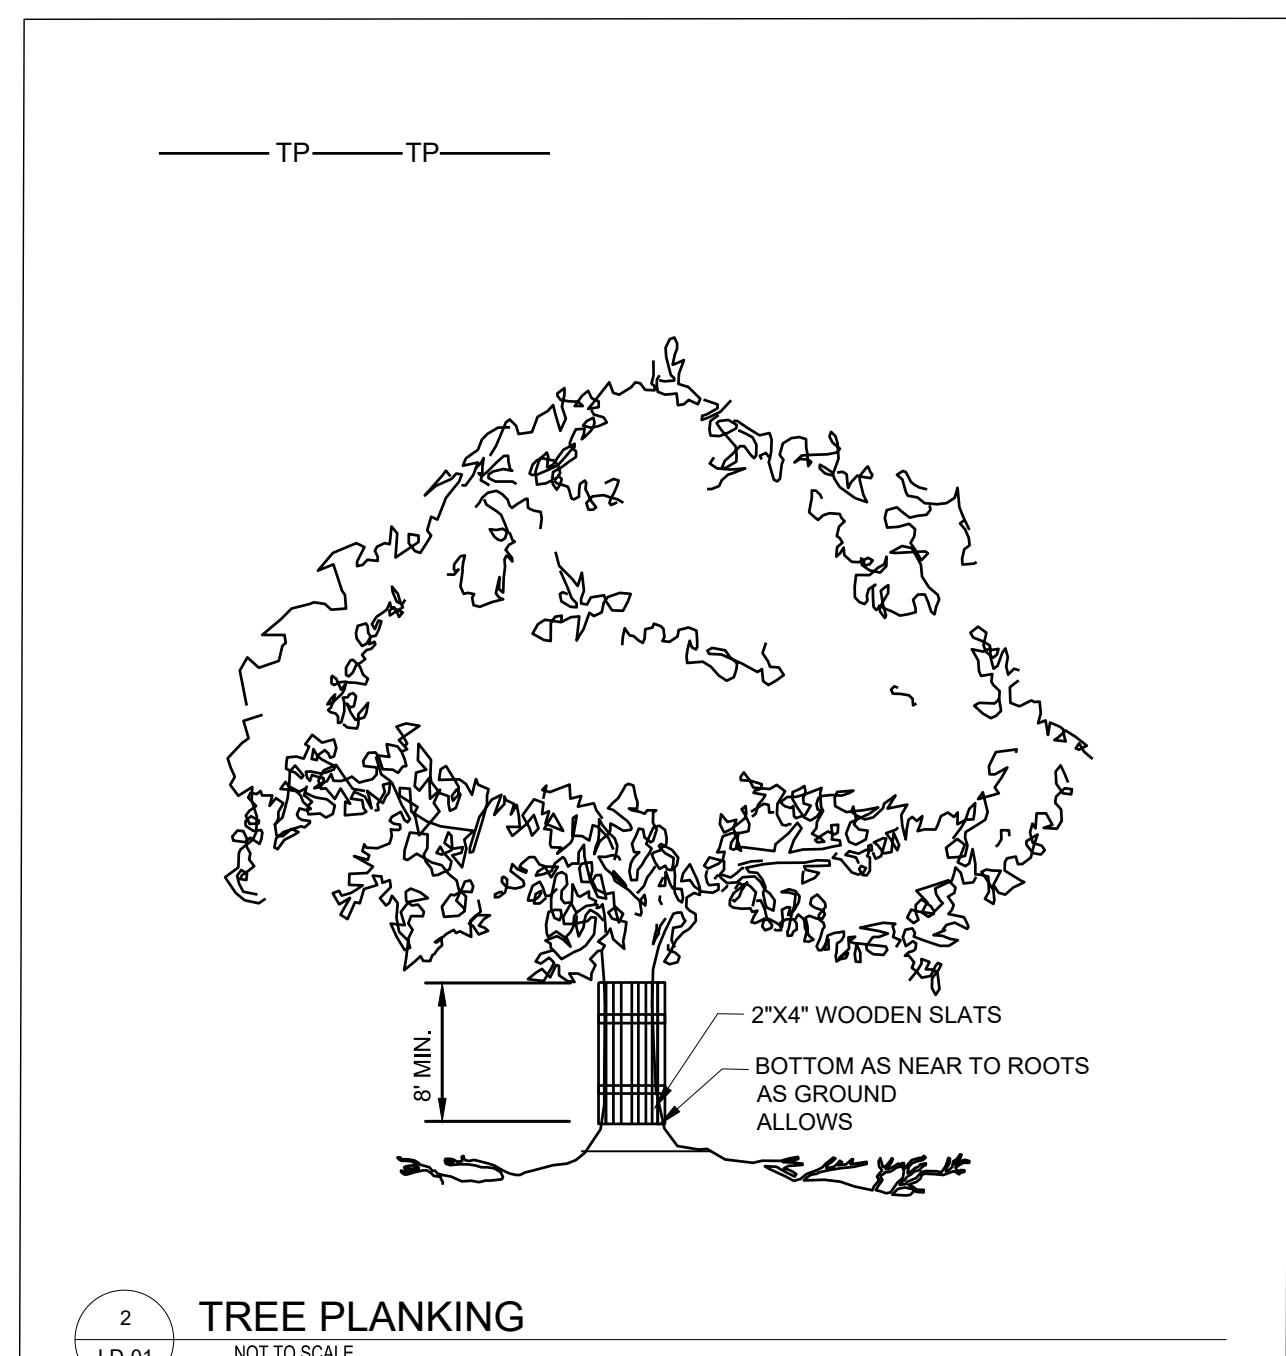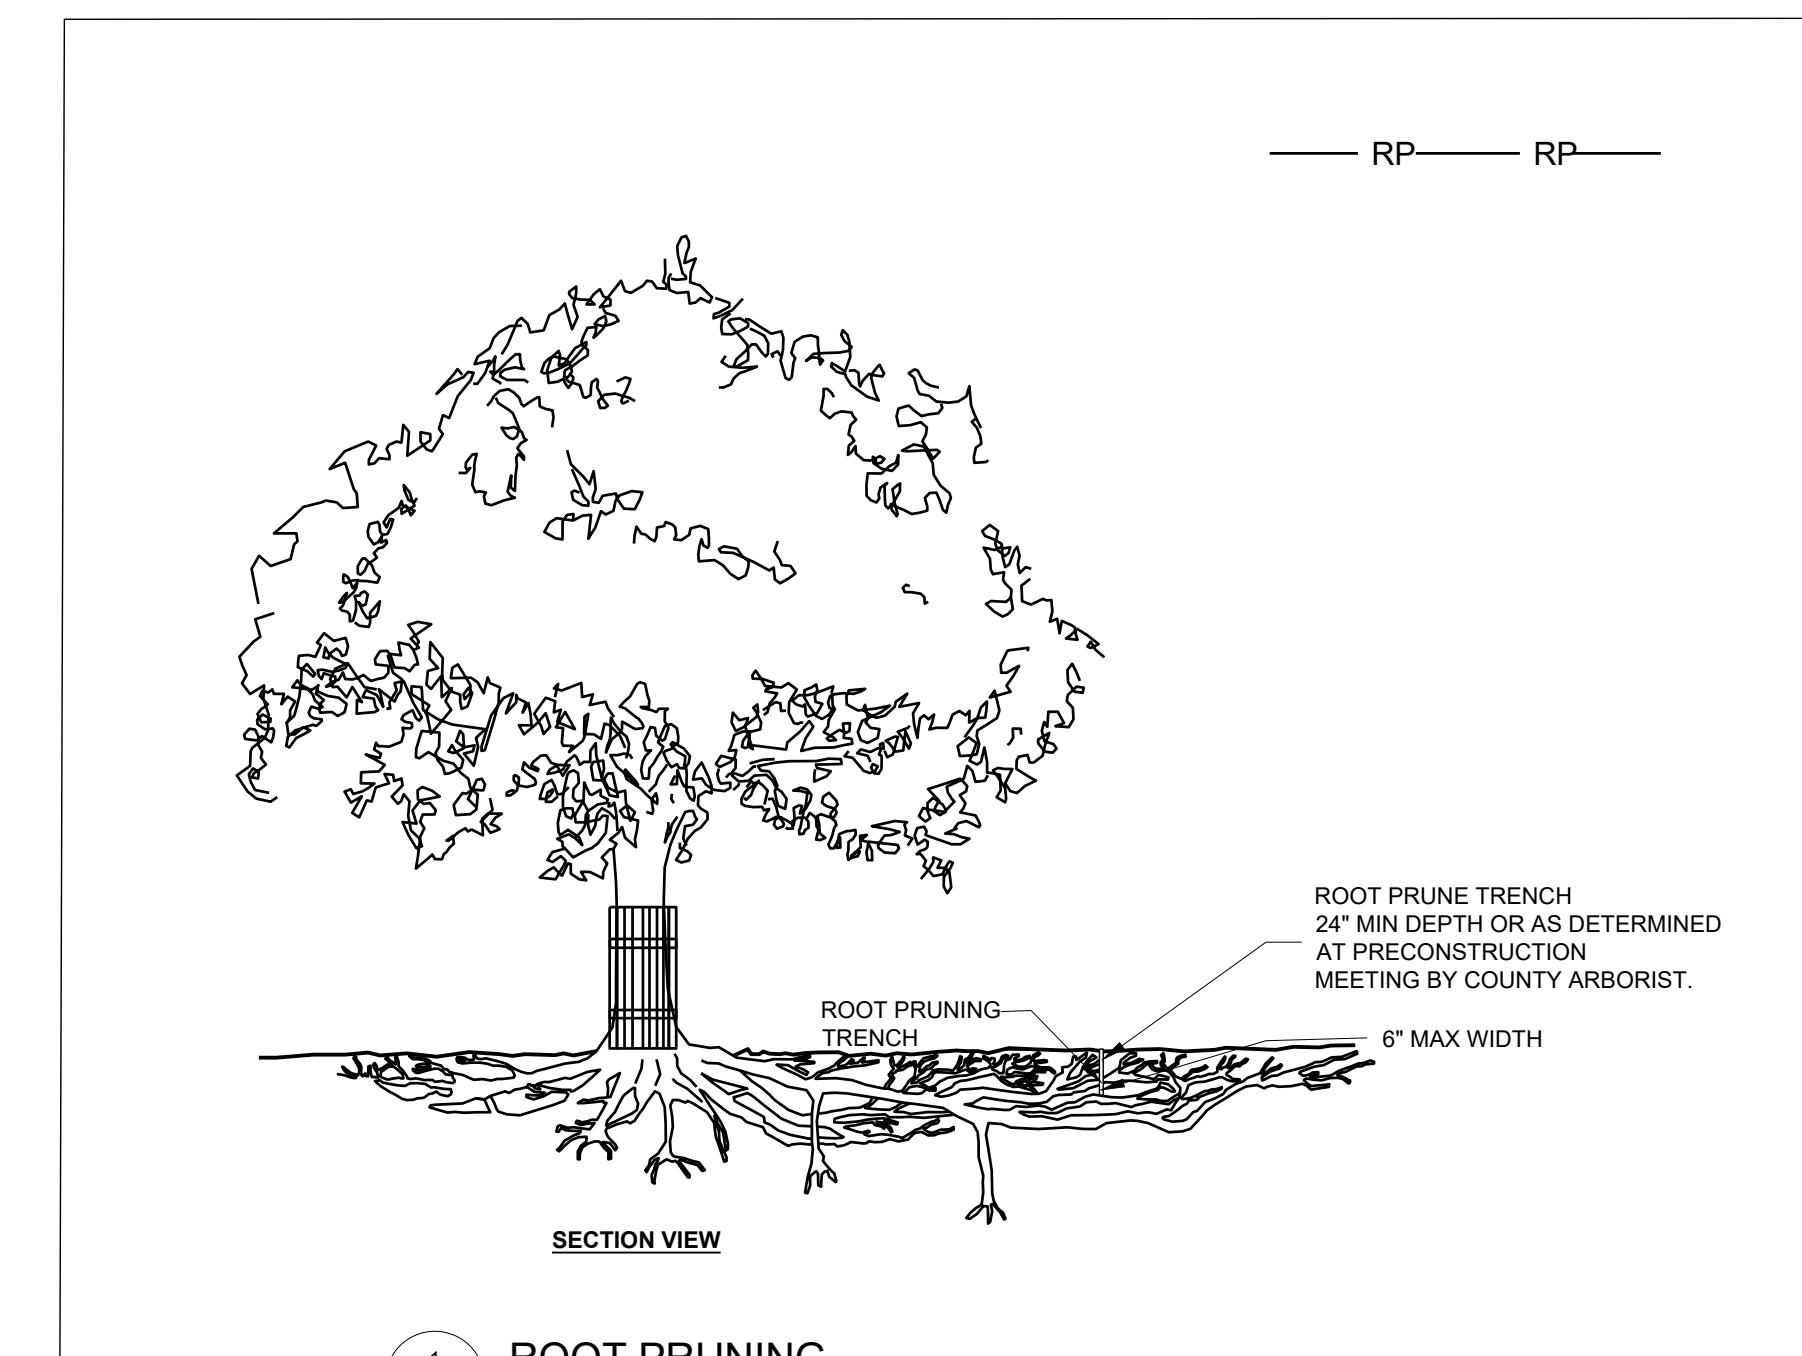

S/C PLAN # 59914	Revisions
GRA-004622-2025	
SIGN AND SEAL	
PROFESSIONAL CERTIFICATION	
I HEREBY CERTIFY THAT THESE DOCUMENTS WERE PREPARED OR APPROVED BY ME, AND THAT I AM A DULY LICENSED PROFESSIONAL ENGINEER UNDER THE LAWS OF THE STATE OF MARYLAND LICENSE NO. XXXXX, EXPIRATION DATE: XX/XX/XXXX.	
Drawn By : CA	Reviewed By : BWA
Designed By : CA	
Drawing No. LD-01	of LD-02
Sheet No. 52 of 65	

HARFORD COUNTY, MARYLAND
 EDGEWATER VILLAGE PARK
 STREAM RESTORATION
 STREAM RESTORATION DETAILS
 AS NOTED
 Scale : SEPTEMBER 2025
 Drawn By : CA
 Designed By : CA
 Reviewed By : BWA
 Drawing No. LD-01 of LD-02
 Sheet No. 52 of 65

1. QUANTITIES ARE BASED ON ESTIMATED PLANTING AREA OF 2.39 ACRES. ANY ADDITIONAL DISTURBANCE REQUIRING PLANTING SHALL BE SEEDED AND PLANTED AT THE RATE SPECIFIED FOR UPLAND SEED MIX.
2. SEEDING SHALL OCCUR PRIOR TO INSTALLATION OF EROSION CONTROL COIR MATTING FABRICS AND LIVE STAKE PLANTING.
3. LIVE STAKES SHALL BE INSTALLED ALONG NEWLY GRADED BANKS WITHIN PLANTING ZONE 3 AS INDICATED ON THE LANDSCAPING PLANS. THE DENSITY OF LIVE STAKES IS BASED ON AN ESTIMATED AREA OF STREAM BANK AND SPACED ACCORDING TO THE LIVE STAKING DETAIL.
4. LIVE STAKES WILL BE PLANTED WITH 2 ROWS ON EACH SPECIFIED STREAM BANK AT 3'X3' SPACING.
5. TREES AND SHRUBS SHALL BE SPACED 15 FT ON CENTER IN OFFSETTING ROWS.
6. MULCHING SHALL BE PERFORMED WITHIN 48 HOURS OF SEEDING. GRAIN STRAW MULCH SHOULD BE APPLIED ON SEEDED AREAS AT A RATE OF 2 TONS PER ACRE AND APPLIED UNIFORMLY.
7. SPECIES LISTED ON LD-01 SHOULD BE PLANTED. IF UNAVAILABLE, SUBSTITUTIONS MAY BE ALLOWED BASED ON REVIEW AND APPROVAL OF THE PROPOSED MATERIAL AND LOCAL NURSERY SUPPLY
8. UPLAND SEED MIX SHALL BE APPLIED EVENLY AT A RATE OF 20 LBS PER ACRE WITH A COVER CROP OF OATS AT 100 LBS PER ACRE BETWEEN JANUARY 1 TO APRIL 30, BROWN TOP MILLET AT 30 LBS PER ACRE BETWEEN MAY 1 TO AUGUST 31 OR GRAIN RYE AT 100 LBS PER ACRE BETWEEN SEPTEMBER 1 TO DECEMBER 31.
9. RIPARIAN SEED MIX SHALL BE APPLIED EVENLY AT A RATE OF 20 LBS PER ACRE WITH A COVER CROP OF GRAIN OATS AT 100 LBS PER ACRE BETWEEN JANUARY 1 TO APRIL 30, BROWN TOP MILLET AT 30 LBS PER ACRE BETWEEN MAY 1 TO AUGUST 31, OR GRAIN RYE AT 100 LBS PER ACRE BETWEEN SEPTEMBER 1 TO DECEMBER 31.
10. ALL SINGLE STEM TREES LOCATED WITHIN ZONE 1 SHALL RECEIVE BLACK HIGH DENSITY POLYETHYLENE DEER PROTECTION SHELTERS 4' IN HEIGHT BY 4" IN DIAMETER MOUNTED AS DEPICTED IN THE TYPICAL DETAIL PROVIDED.
11. ALL SHRUB PLANTINGS AND MULTI STEM TREES LOCATED WITHIN ZONE 1 SHALL BE ENCLOSED USING 4' TALL, 14 GAUGE GALVANIZED, WELDED WIRE FENCE SECURED TO 6' METAL T-POSTS DRIVE 2' INTO THE GROUND.
12. INDIVIDUAL TREES WITHIN THE LOD THAT ARE NOT MARKED AS REMOVAL, NOT WITHIN A DESIGNATED AREA OF FOREST RETENTION, OUTSIDE THE LIMITS OF GRADING, AND OUTSIDE OF CONSTRUCTION ACCESS ROADS SHALL BE PROTECTED WITH TREE PLANKING OR HIGH VISIBILITY FENCE CONTINUOUSLY AROUND THOSE TREES.
13. CONTRACTOR SHALL USE LOW PRESSURE EQUIPMENT OR HAND GRADING WHEN GRADING WITHIN CRITICAL ROOT ZONES OF TREES THAT ARE MARKED TO BE SAVED.
14. FOREST RETENTION SIGNAGE SHALL BE STAKED ALONG THE EXISTING HIGH VISIBILITY FENCING OR SILT FENCE ALONG PORTIONS OF THE LOD MARKED AS FOREST RETENTION AREA. SIGN SHALL BE SPACED APPROXIMATELY 100 FEET APART WHERE POSSIBLE, WITH MAXIMUM OF 150 FEET APART.
15. CONTRACTOR SHALL REFER TO THE EDGEWATER VILLAGE STREAM RESTORATION CONSTRUCTION SPECIFICATIONS REGARDING FOREST/TREE PROTECTION METHODS. INITIAL PLANTING SHALL BE SUPERVISED BY A LICENSED TREE CARE PROFESSIONAL
16. NO TREES SHALL BE PLANTED WITHIN 15 FEET OF ANY EXISTING UTILITIES ON SITE

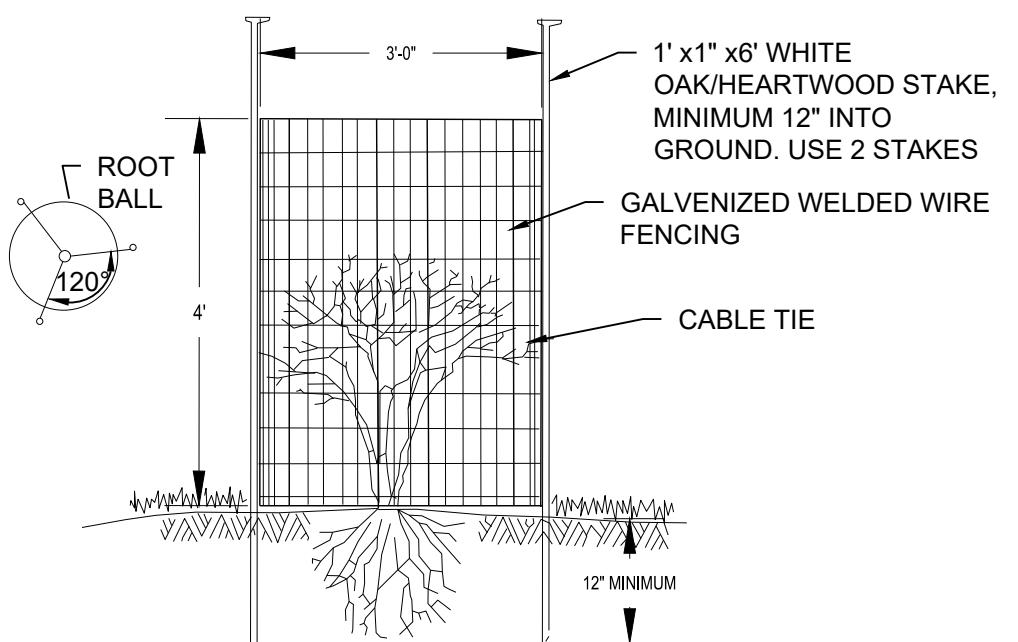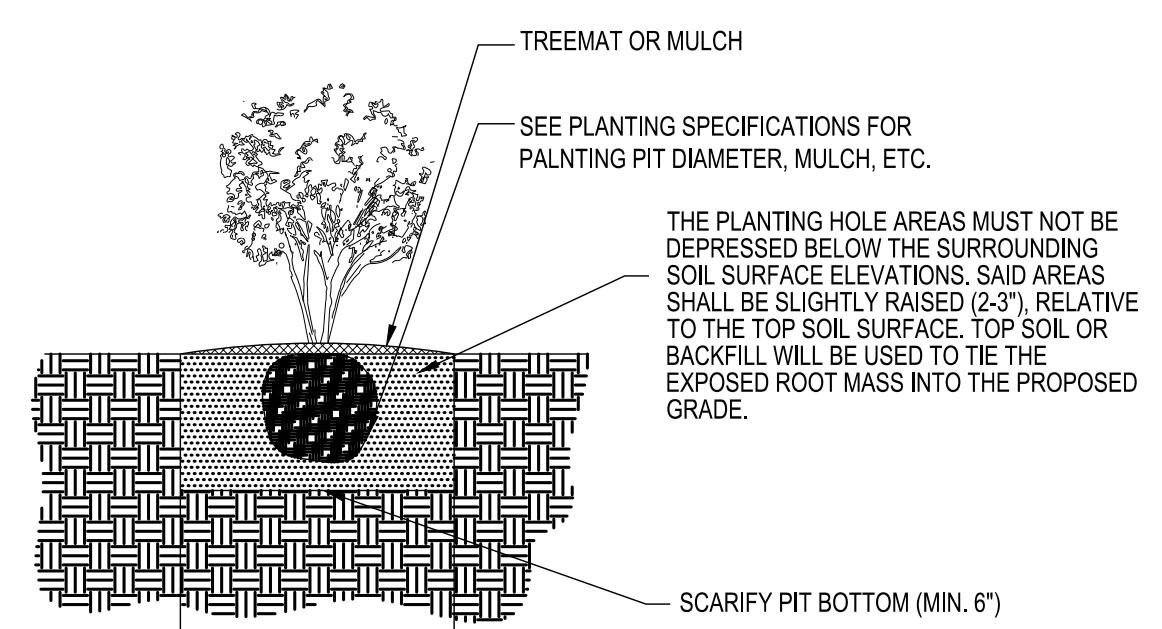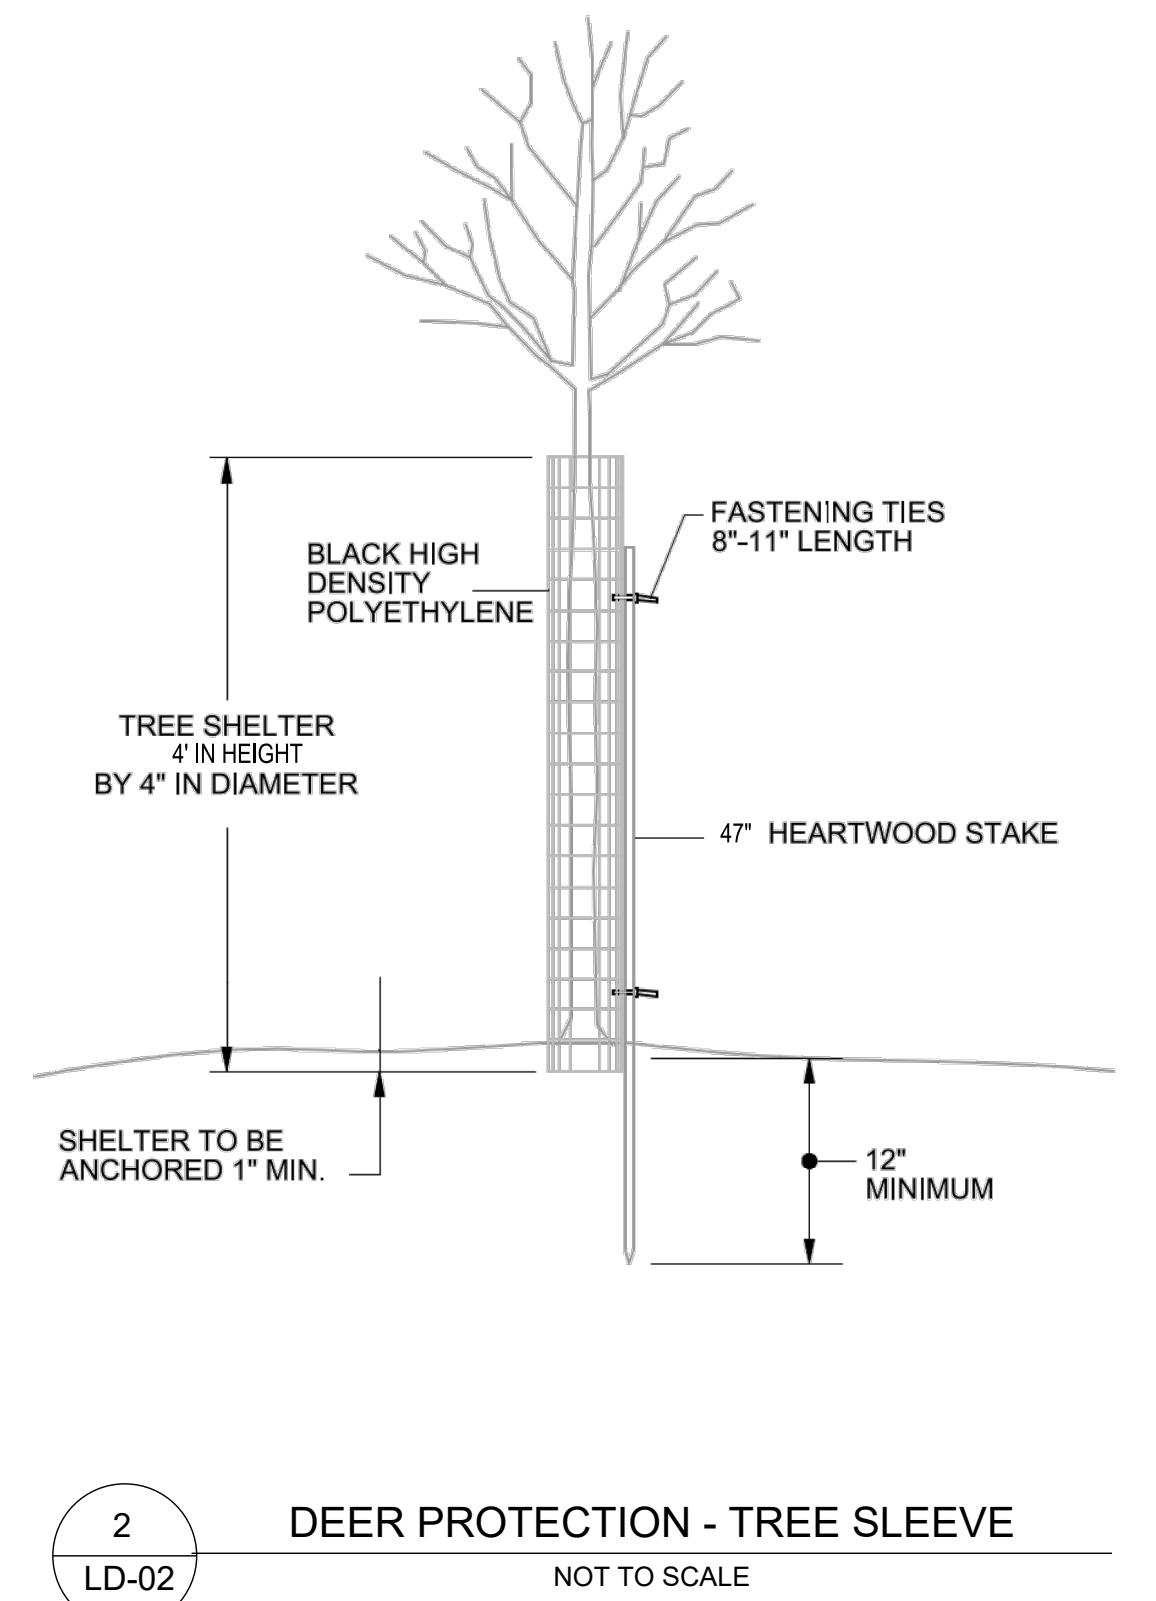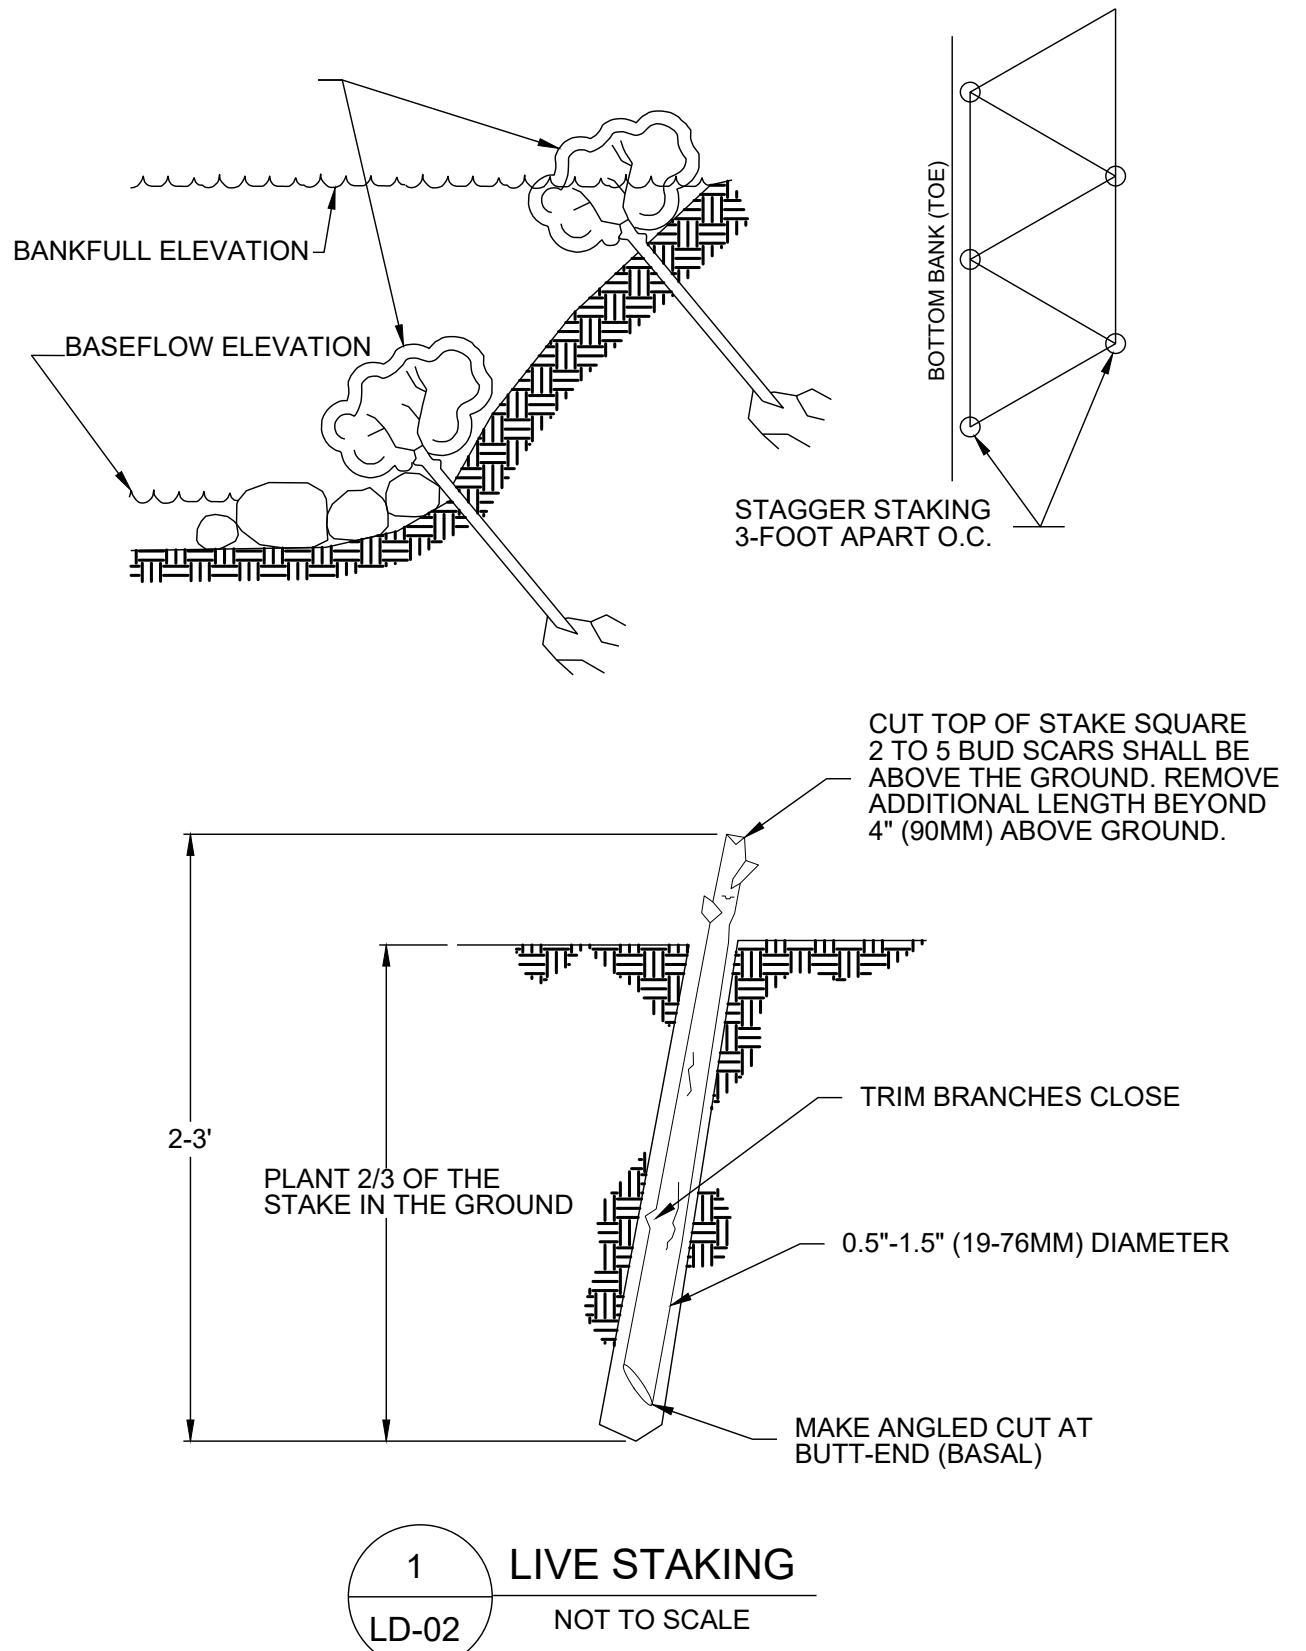

S/C PLAN # 59914	Revisions
GRA-004622-2025	
SIGN AND SEAL	
PROFESSIONAL CERTIFICATION	


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HARFORD COUNTY, MARYLAND
EDGEWATER VILLAGE PARK
STREAM RESTORATION
LANDSCAPING DETAILS
Drawing No. LD-02 of LD-02 Sheet No. 53 of 65
Scale : AS NOTED
Date : SEPTEMBER 2025
Drawn By : CA
Designed By : CA
Reviewed By : BWA
HGC DWG ID No. :
S/C PLAN # 59914
Revisions
SIGN AND SEAL
PROFESSIONAL CERTIFICATION
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DRAINAGE AREAS		
POI	DRAINAGE AREA (SQ. MI)	PERCENT IMPERVIOUS (%)
REACH 1	0.05	40%
REACH 2A	0.08	33%
REACH 2B	0.09	33%
LT-1	0.02	28.3%
LT-2	0.01	11.9%
REACH 3	0.11	33.0%

DRAINAGE AREA BOUNDARY
 SUB-DRAINAGE AREA BOUNDARY
 POINT OF INTEREST (POI)



PROFESSIONAL CERTIFICATION

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HARFORD COUNTY, MARYLAND

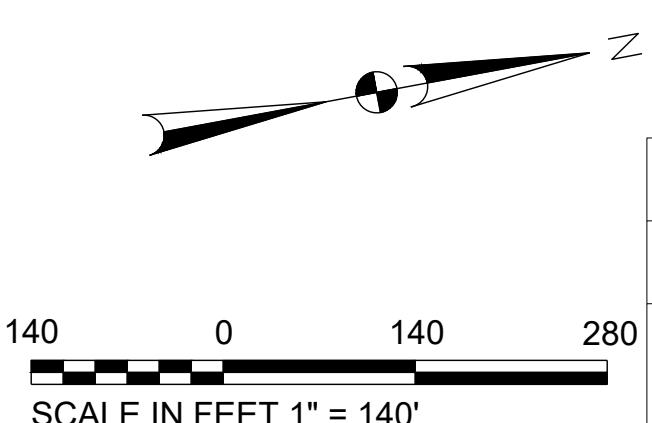EDgewater VILLAGE PARK
STREAM RESTORATION
DRAINAGE AREA

S/C PLAN # 59914	Revisions
GRA-004622-2025	
SIGN AND SEAL	
Drawn By : _____ CA	Scale : 1"=140'
Designed By : _____ CA	Date : SEPTEMBER 2025
Reviewed By : _____ BWA	
Drawing No. DA-01 of DA-01	
Sheet No. 54 of 65	

HGC DWG ID No.: _____


SCALE : 1 inch

EDGEWATER VILLAGE PARK SEWER REPLACEMENT

INDEX OF SHEETS

NO.	DESCRIPTION	SHEET NAME
55	TITLE SHEET	SS-01
56	SEWER CONSTRUCTION NOTES	SS-02
57	SEQUENCE OF CONSTRUCTION	SS-03
58	EXISTING CONDITIONS	SS-04
59	EXISTING CONDITIONS	SS-05
60	SANITARY SEWER PLAN AND PROFILE	SS-06
61	SANITARY SEWER PLAN AND PROFILE	SS-07
62	BYPASS PUMPING PLAN	SS-08
63	SEWER DETAILS	SS-09
64	SEWER DETAILS	SS-10
65	SEWER DETAILS	SS-11

OFFICE OF PUBLIC WORKS
HARFORD COUNTY, MARYLAND
BID NO. : TBD

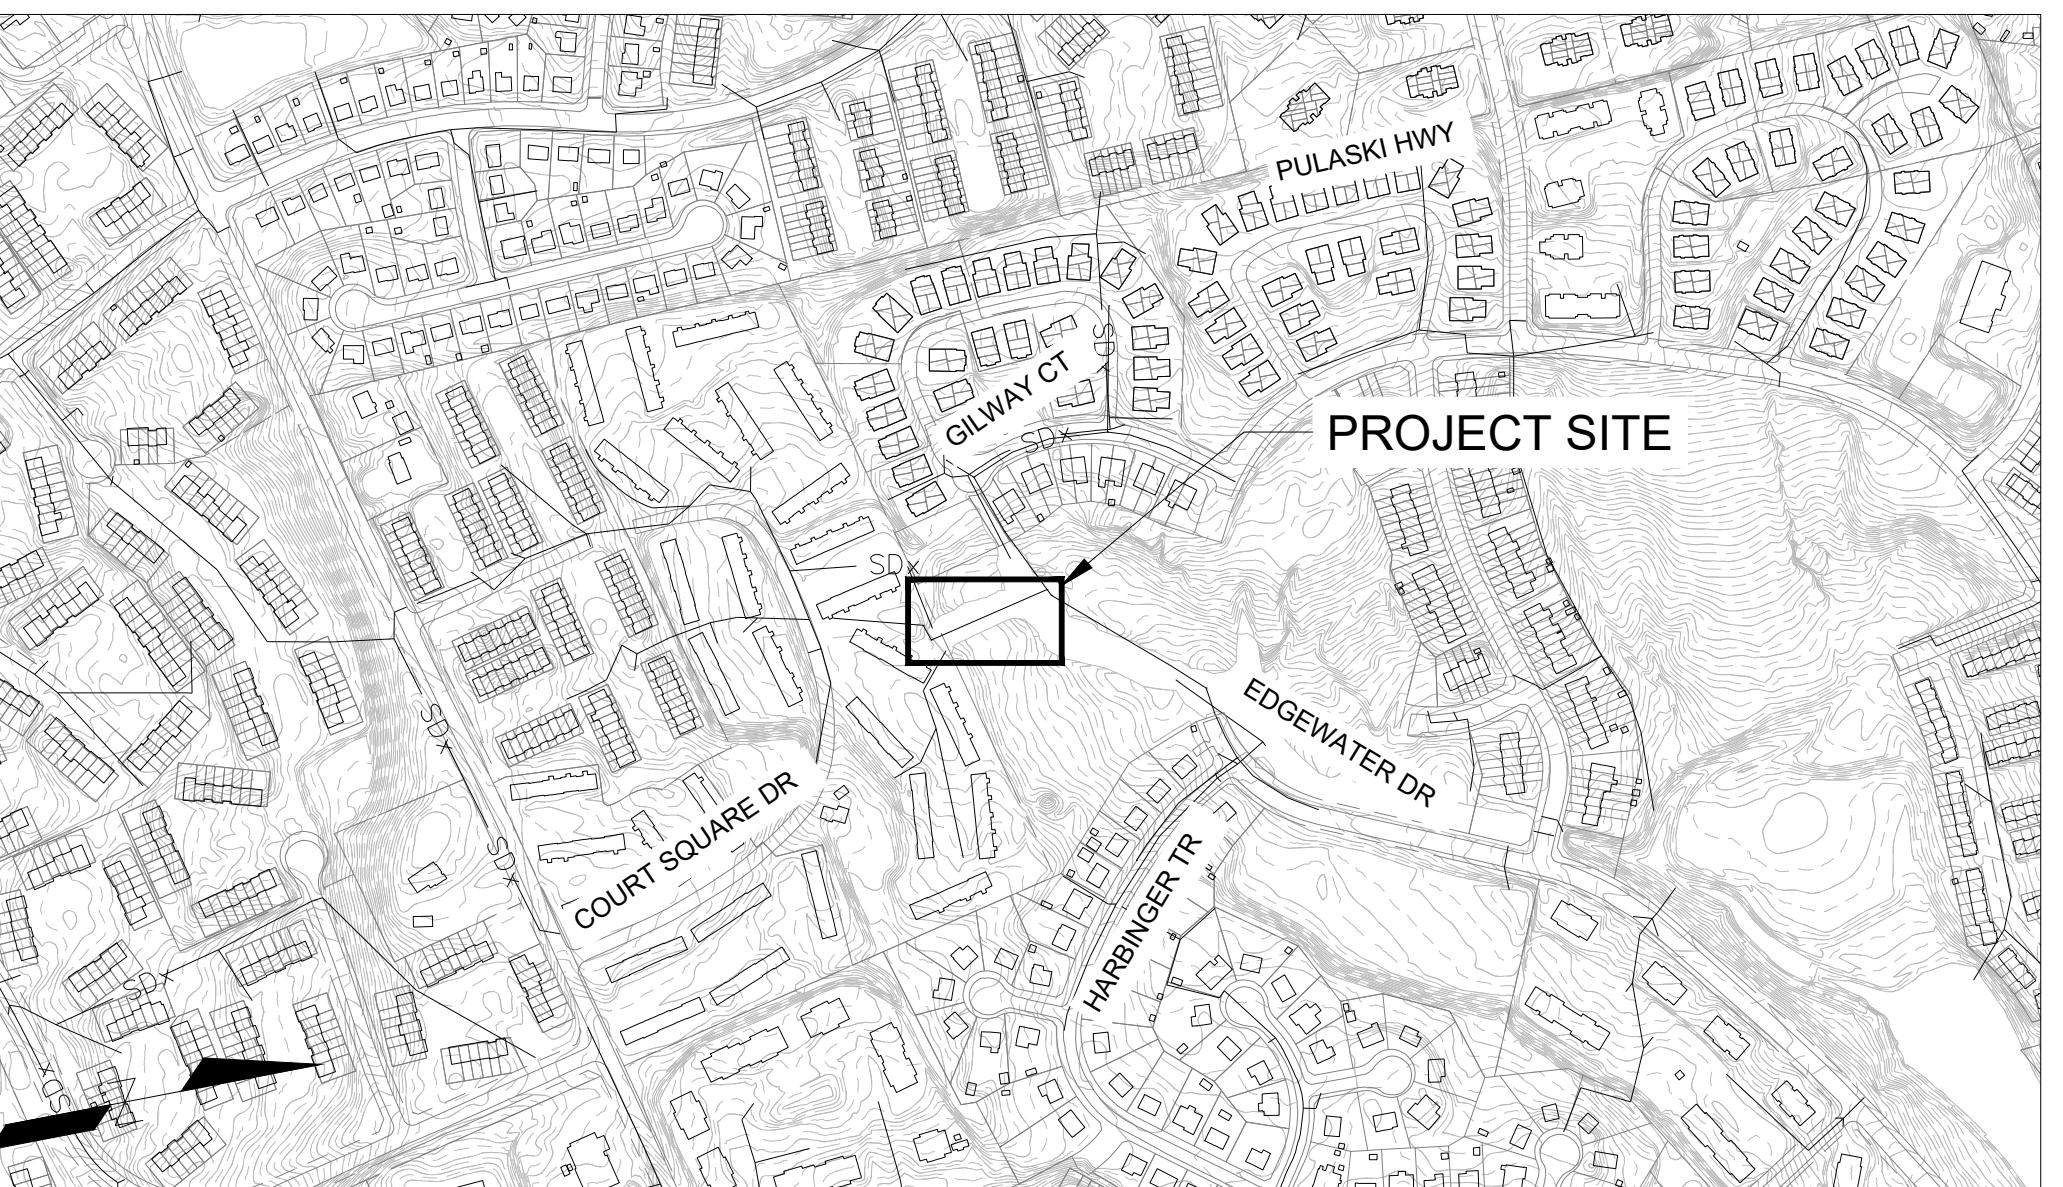

LOCATION MAP

SCALE 1" = 400'

400' 0 400' 800'
SCALE: 1"=400'

PROJECT SUMMARY

THE HARFORD COUNTY DEPARTMENT OF PUBLIC WORKS, WATERSHED PROTECTION AND RESTORATION DIVISION IS PURSUING THE EDGEWATER PARK STREAM RESTORATION PROJECT. THIS SEWER REPLACEMENT PLAN WILL SUPPORT THE CONSTRUCTION OF THE EDGEWATER PARK STREAM RESTORATION PROJECT BY REPLACING AN 8" SEWER CROSSING THE PROPOSED STREAM ALIGNMENT AND MODIFYING EXISTING MANHOLES TO MEET COUNTY WATER AND SEWER SPECIFICATIONS.

THE SITE IS LOCATED IN A SUBURBAN AREA WITHIN THE UNINCORPORATED COMMUNITY OF EDGEWOOD, MARYLAND. THE AREA SURROUNDING THE PROJECT AREA INCLUDES RESIDENTIAL NEIGHBORHOODS, ATHLETIC FIELDS, OPEN SPACE, AND FORESTED BUFFERS. THE SITE IS LOCATED WITHIN THE WINTERS RUN-BUSH RIVER (HUC10: 0206000301) AND BUSH RIVER (HUC12: 020600030105) WATERSHEDS. AREAS LOCATED OUTSIDE THE LOD WILL NOT BE DISTURBED DURING CONSTRUCTION.

GENERAL NOTES

1. SPECIFICATIONS: ALL WORK IS TO BE PERFORMED IN ACCORDANCE WITH MARYLAND STATE HIGHWAY ADMINISTRATIONS STANDARD SPECIFICATIONS FOR CONSTRUCTION AND MATERIALS DATED JULY 2022 AND THE MOST RECENT REVISIONS THEREOF AND ADDITIONS THERETO.
2. SPECIFICATIONS: CONSTRUCTION OF THIS PROJECT SHALL BE PERFORMED IN ACCORDANCE WITH THE CURRENT EDITION OF THE STANDARD SPECIFICATIONS AND DETAILS FOR WATER MAINS AND SANITARY SEWERS OF THE HARFORD COUNTY DEPARTMENT OF PUBLIC WORKS AND WITH THE CONTRACT PLANS AND SPECIFICATIONS. ALL WORK SHALL BE PERFORMED IN ACCORDANCE WITH THE MARYLAND OCCUPATIONAL SAFETY LAWS. SEE HARFORD COUNTY STANDARD SPECIFICATIONS. ALL MATERIALS USED ON THIS PROJECT SHALL BE LISTED IN THE APPROVED MATERIALS LIST AS IDENTIFIED IN THE RULES AND REGULATIONS OF THE DIVISION OF WATER AND SEWER.
3. UTILITIES: UTILITY LOCATIONS SHOWN ON THE PLANS ARE BASED ON LIMITED INFORMATION AVAILABLE. HOWEVER, IT IS THE RESPONSIBILITY OF THE CONTRACTOR TO VERIFY THE ACCURACY OF THIS INFORMATION. THE COST OF REPAIR OR REPLACEMENT OF ANY SUCH FACILITIES DAMAGED BY THE CONTRACTOR'S OPERATIONS SHALL BE BORNE BY HIM. CONTACT "MISS UTILITY" PHONE 1-800-257-7777, 48 HOURS PRIOR TO THE START OF WORK. THERE SHOULD BE NO EXCAVATION UNTIL THE LOCATIONS OF UNDERGROUND UTILITIES HAVE BEEN DETERMINED.
4. STANDARD DETAILS: REFERENCE MADE TO STANDARDS ARE TAKEN FROM THE HARFORD COUNTY "STANDARD SPECIFICATIONS AND DETAILS FOR WATER MAINS & SEWER MAINS" DATED 2014, FROM THE HARFORD COUNTY ROAD CODE "BOOK OF STANDARD DETAILS" AND FROM "THE MARYLAND STATE HIGHWAY ADMINISTRATION'S BOOK OF STANDARDS-HIGHWAY AND INCIDENTAL STRUCTURES", IT WILL BE THE CONTRACTOR'S RESPONSIBILITY THAT THE STANDARD DRAWINGS IN HIS POSSESSION ARE THE LATEST REVISED STANDARDS UP TO AND INCLUDING THE DATE OF THE ADVERTISEMENT OF THIS CONTRACT.
5. RIGHT-OF-WAY LINES: RIGHT-OF-WAY LINES SHOWN ON THESE PLANS DO NOT INCLUDE EASEMENTS. THEY ARE FOR ASSISTANCE IN INTERPRETING THE PLANS ONLY. THESE LINES DO NOT REPRESENT THE OFFICIAL PROPERTY ACQUISITION LINES. FOR OFFICIAL FEES RIGHT-OF-WAY AND EASEMENT INFORMATION, SEE THE APPROPRIATE RIGHT-OF-WAY PLATS.
6. SOIL CONSERVATION: THE CONTRACTOR SHALL NOT DISTURB THE EXISTING VEGETATION OUTSIDE THE LIMITS OF DISTURBANCE. IF NECESSARY, A TEMPORARY STOCKPILE SHALL BE PROVIDED WITHIN THE LIMITS OF DISTURBANCE. THE STOCKPILE SHALL BE LOCATED SUCH THAT ANY RUNOFF WILL DRAIN TO AN EXISTING SEDIMENT CONTROL DEVICE (I.E., SUPER SILT FENCE). THE STOCKPILE MAY NOT PROTRUDE UPON NOR ALTER DRAINAGE DIVIDES TO THE SEDIMENT CONTROL DEVICE AT ANY TIME. SOIL STABILIZATION WILL CONFORM TO 2011 MARYLAND STANDARDS AND SPECIFICATIONS FOR SOIL EROSION AND SEDIMENT CONTROL. THE CONTRACTOR WILL OBTAIN APPROVAL OF THE HARFORD COUNTY SOIL CONSERVATION DISTRICT FOR HIS PLANS IN CONTROLLING SEDIMENT EROSION FOR THE BORROW AREA AND DISPOSING OF ANY WASTE EXCAVATION.
7. EXISTING MAILBOXES AND EXISTING SIGNS: ALL EXISTING MAILBOXES, SIGNS AND PAPER BOXES DISTURBED DURING CONSTRUCTION SHALL BE TEMPORARILY RESET IMMEDIATELY AND PERMANENTLY RESET AS DIRECTED BY THE ENGINEER. THIS WORK WILL BE INCIDENTAL TO ALL OTHER ITEMS IN THE CONTRACT.
8. SURVEYS: HORIZONTAL CONTROL - COORDINATES SHOWN ON THE PLANS ARE BASED ON THE MARYLAND STATE PLANE COORDINATE SYSTEM (NAD83) IN U.S. SURVEY FEET. VERTICAL CONTROL - ELEVATIONS SHOWN ON THE PLANS ARE BASED ON NORTH AMERICAN VERTICAL DATUM OF 1988 (NAVD88) IN U.S. FEET. ONLY THOSE CONTROL POINTS SHOWN ON THESE PLANS ARE TO BE USED FOR THE CONSTRUCTION OF THIS PROJECT. SOURCES FOR ELEVATION DATA INCLUDE THE FOLLOWING: SURVEY PERFORMED BY AECOM IN FEBRUARY 2023 AND MARCH 2023 AND GIS TOPOGRAPHY AVAILABLE FROM THE HARFORD COUNTY GIS DATA DOWNLOAD PORTAL.

NOT FOR CONSTRUCTION: 100% DESIGN REVIEW

Client: HARFORD COUNTY
DEPARTMENT OF PUBLIC WORKS
WATERSHED PROTECTION AND
RESTORATION OFFICE
212 S. BOND STREET
BEL AIR, MD 21014
410-638-3217

Prepared By :

AECOM
12420 MILESTONE CENTER DRIVE
SUITE 150
GERMANTOWN, MARYLAND 20876
301-820-3000

CONTRACT NO. 2792A

PROFESSIONAL CERTIFICATION

I HEREBY CERTIFY THAT THESE DOCUMENTS WERE PREPARED OR APPROVED BY ME,
AND THAT I AM A DULY LICENSED PROFESSIONAL ENGINEER UNDER THE LAWS OF
THE STATE OF MARYLAND, LICENSE NO. XXXXX, EXPIRATION DATE: XX/XX/XXXX.

S/C PLAN # XXXXX	Revisions
GP # XXXXX-XXXX	
SIGN AND SEAL	
	Drawn By : _____ LW
	Designed By : _____ LW
	Reviewed By : _____ NK
Drawing No. SS-01 OF SS-11	Sheet No. 55 of 65

HARFORD COUNTY, MARYLAND	
EDGEWATER VILLAGE PARK SEWER REPLACEMENT TITLE SHEET	
NOTS Date : SEPTEMBER 2025	
Drawn By : _____ LW	Scale : _____ NTS
Designed By : _____ LW	Date : _____ SEPTEMBER 2025
Reviewed By : _____ NK	
Drawing No. SS-01 OF SS-11	Sheet No. 55 of 65

GENERAL CONSTRUCTION NOTES

A. THE ENGINEER USED NORMAL STANDARD OF CARE IN LOCATING, IDENTIFYING AND SURVEYING EXISTING UTILITIES. NO SPECIALIZED SUBSURFACE UTILITY ENGINEERING WAS CONDUCTED. ALL EXISTING UTILITIES FOUND DURING SURVEY ARE SHOWN ON THE PLANS. THE CONTRACTOR IS RESPONSIBLE FOR LOCATING ALL UTILITIES WITHIN THE CONSTRUCTION LIMITS AND VERIFYING THE LOCATION AND DEPTHS OF BURIED UTILITIES PRIOR TO CONSTRUCTION. IF A CONFLICT IS DISCOVERED BETWEEN THE PLANS AND THE EXISTING UTILITIES, THE CONTRACTOR IS TO NOTIFY THE ENGINEER TO ADDRESS THE CONFLICT PRIOR TO BEGINNING CONSTRUCTION.

B. CONTRACTOR SHALL PROVIDE TEMPORARY STABILIZATION OF ALL UTILITIES DURING CONSTRUCTION INCLUDING POWER POLES.

C. VERIFY ALL FIELD CONDITIONS PRIOR TO CONSTRUCTION AND/OR DEMOLITION AND REPORT ANY DIFFERENCE IN SITE CONDITIONS FROM THE DRAWINGS TO THE ENGINEER IMMEDIATELY.

D. PROMPTLY INFORM THE ENGINEER OF ANY ERROR OR DISCREPANCY DISCOVERED IN THESE DRAWINGS OR SPECIFICATIONS OR CONFLICT BETWEEN THE DRAWINGS AND THE SPECIFICATIONS.

E. THE FLOW OF GRAVITY SEWERS SHOWN ON THE PLANS IS DOWNSTREAM IN THE DIRECTION OF THE STATIONS SHOWN UNLESS OTHERWISE NOTED. UNLESS OTHERWISE NOTED, STATIONS REFER TO SEWER PIPE STATIONING.

F. COMPLETE ALL PROPOSED WORK CAREFULLY TO MINIMIZE DISTURBANCE TO ADJACENT AREAS.

G. RESTORE ANY AREAS DISTURBED BY CONSTRUCTION TO THEIR ORIGINAL OR PROPOSED CONDITION TO THE SATISFACTION OF THE OWNER AND THE ENGINEER.

H. IF WORK IS NOT ANTICIPATED OR INVOLVES DESIGN MODIFICATION CONSIDERATIONS, NOTIFY ENGINEER PRIOR TO PROCEEDING.

I. CONTRACTOR SHALL BE RESPONSIBLE FOR CLEARING AND DEMOLITION OF ANY ELEMENTS WHICH ARE IN CONFLICT WITH PROPOSED NEW CONSTRUCTION. THIS INCLUDES BUT IS NOT LIMITED TO FENCES, TREES, DRAINAGE STRUCTURES, POLES, PAVEMENTS, VEGETATION, SIGNS AND OTHER MISCELLANEOUS SITE ELEMENTS.

J. ALL DEMOLITION DEBRIS SHALL BE DISPOSED OF OFF-SITE IN ACCORDANCE WITH ALL LOCAL, STATE, AND FEDERAL REGULATIONS AND SPECIFICATIONS, LATEST REVISION.


K. CONTRACTOR SHALL STRIP TOPSOIL AND STOCKPILE IT FOR LATER USE.

L. EXISTING UTILITIES SUCH AS WATER, SEWER, GAS, ELECTRICAL, FIBER, CABLE, ETC. MAY BE PRESENT IN THE AREA. THE EXACT LOCATION OF ALL UNDERGROUND UTILITIES SHOULD BE VERIFIED PRIOR TO CONSTRUCTION. ANY AND ALL DAMAGES RESULTING FROM THE FAILURE TO DO SO SHALL BE REPAIRED AT NO EXPENSE TO THE OWNER. CONTACT ANY APPLICABLE LOCAL AND REGIONAL UTILITIES COMPANIES AT LEAST 48 HOURS PRIOR TO COMMENCING CONSTRUCTION.

M. IT IS ANTICIPATED THE SEWER REPLACEMENT AND MODIFICATIONS PRESENTED IN THIS PLAN WILL OCCUR CONCURRENTLY AND AT APPROPRIATE TIMES WITH THE EDGEWATER VILLAGE PARK STREAM RESTORATION PLAN.

N. WHERE APPLICABLE, CONTRACTOR SHALL UTILIZE THE EROSION AND SEDIMENT CONTROL PLAN AND NOTES, INCLUDING ANY NECESSARY STREAM DEWATERING PRACTICES, IN THE EDGEWATER VILLAGE STREAM RESTORATION PLAN.

LEGEND

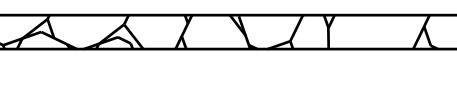EXISTING CONDITIONS/DEMOLITION		PROPOSED CONDITIONS	
	PROPERTY BOUNDARY	-LOD—	LIMIT OF DISTURBANCE
—	MAJOR CONTOURS	—LOD—LOD—LOD—LOD—LOD—	SEWER BYPASS FLOW
—	MINOR CONTOURS	—SS—	SANITARY SEWER PIPE
—WUS—	WATERS OF THE US	—	PIPE ENCASEMENT
—EPH—	EPHEMERAL WATER		PUMP PAD
—LOS—	LIMITS OF SURVEY		RIPRAP
—	EXISTING STREAMLINE		
—//—	SOIL BOUNDARY		
—SDx—	STORM DRAIN		
—	TREE LINE		
—○—	FENCE		
—SS—	SANITARY SEWER		
—#—	PIPE TO BE REMOVED		
	CONCRETE DEBRIS		
	RIPRAP		
	SANITARY SEWER MANHOLE		
	SPECIMEN TREE (30"+)		
	SIGNIFICANT TREE (24"-29")		
	TREES LESS THAN 24"		
	CRITICAL ROOT ZONE		
	TREE TO BE REMOVED		

DEVELOPER'S/LANDOWNER'S CERTIFICATION

I/WE HEREBY CERTIFY THAT ALL PROPOSED WORK SHOWN ON THESE CONSTRUCTION DRAWING(S) WILL BE ACCOMPLISHED PURSUANT TO THESE PLANS. I/WE ALSO UNDERSTAND THAT IT IS MY/OUR RESPONSIBILITY TO HAVE THE CONSTRUCTION SUPERVISED AND CERTIFIED, INCLUDING THE SUBMITTAL OF "AS-BUILT" PLANS WITHIN 30 DAYS OF COMPLETION, BY A REGISTERED PROFESSIONAL ENGINEER.

SIGNED: _____
PRINT NAME: _____
DATE: _____

ENGINEER'S CERTIFICATION

I HEREBY CERTIFY THAT THIS PLAN HAS BEEN PREPARED BY ME, OR UNDER MY SUPERVISION, AND MEETS THE MINIMUM STANDARDS OF THE HARFORD COUNTY DEPARTMENT OF PUBLIC WORKS AND/OR THE UNITED STATES DEPARTMENT OF AGRICULTURE, SOIL CONSERVATION SERVICE, AND/OR THE MARYLAND DEPARTMENT OF THE ENVIRONMENT, WATER MANAGEMENT ADMINISTRATION.

SIGNED: _____
PRINT NAME: _____
DATE: _____
P.E. NO.: _____

AS-BUILT CERTIFICATION

I HEREBY CERTIFY THAT THE FACILITY SHOWN ON THIS PLAN WAS CONSTRUCTED AS SHOWN ON THE "AS-BUILT" PLANS AND MEETS THE APPROVED PLANS AND SPECIFICATIONS.

SIGNED: _____
PRINT NAME: _____
DATE: _____
P.E. NO.: _____

FIELD VERIFICATION CERTIFICATION

I HEREBY CERTIFY THAT I COMPLETED A FIELD VERIFICATION TO THE INFORMATION SHOWN ON THE PLANS ON _____ AND THAT THE INFORMATION SHOWN ON THE PLANS IS IN AGREEMENT WITH THE ACTUAL FIELD CONDITIONS.

SIGNED: _____
PRINT NAME: _____
DATE: _____

HARFORD COUNTY, MARYLAND	
EDGEWATER VILLAGE PARK SEWER REPLACEMENT	
GENERAL CONSTRUCTION NOTES	
Drawn By : _____ Designed By : _____ Reviewed By : _____	Scale : _____ Date : _____
CONTRACT NO. 2792A	SS-02 OF SS-11
PROFESSIONAL CERTIFICATION	
I HEREBY CERTIFY THAT THESE DOCUMENTS WERE PREPARED OR APPROVED BY ME, AND THAT I AM A DULY LICENSED PROFESSIONAL ENGINEER UNDER THE LAWS OF THE STATE OF MARYLAND LICENSE NO. XXXXX, EXPIRATION DATE: XX/XX/XXXX.	

SEQUENCE OF CONSTRUCTION

- THE SEWER MODIFICATION WORK DESCRIBED IN THIS PLAN SET WILL OCCUR AT APPROPRIATE TIMES DURING THE CONSTRUCTION OF THE EDGEWATER VILLAGE PARK STREAM RESTORATION.
- THE CONTRACTOR SHALL OBTAIN ALL REQUIRED PERMISSIONS AND PERMITS PRIOR TO SEWER CONSTRUCTION.
- THE CONTRACTOR SHALL NOTIFY THE COUNTY AND ITS REPRESENTATIVE A MINIMUM OF ONE (1) WEEK PRIOR TO COMMENCING ANY NEW SEWER REPLACEMENT ACTIVITIES.
- THE CONTRACTOR SHALL NOTIFY "MISS UTILITY" PRIOR TO LAND DISTURBANCE TO DETERMINE LOCATIONS OF ALL EXISTING UTILITIES AND SERVICES WITHIN THE PROJECT LIMITS.
- THE CONTRACTOR SHALL SCHEDULE A PRE-CONSTRUCTION MEETING ACCOMMODATING PROJECT STAKEHOLDERS A MINIMUM OF ONE (1) WEEK PRIOR TO COMMENCING ANY NEW SEWER REPLACEMENT ACTIVITIES. THE CONTRACTOR SHALL BE PREPARED TO REVIEW THEIR WORKFLOW PLAN AND PROPOSED CONSTRUCTION SCHEDULE.
- IT IS ANTICIPATED THE CONTRACTOR WILL, AS SHOWN ON AND IN ACCORDANCE WITH THE EDGEWATER VILLAGE PARK STREAM RESTORATION PLANS, MARK LIMITS OF DISTURBANCE (LD) CLEARLY USING STAKES AND FLAGGING PRIOR TO CLEARING AND GRUBBING, INSTALLING SEDIMENT CONTROL MEASURES, CONSTRUCTION, CLEARING AND GRUBBING, OR OTHER LAND DISTURBANCE ACTIVITIES.
- VERIFY THAT ALL REQUIRED PERMISSIONS AND PERMITS HAVE BEEN GRANTED BY THE COUNTY.
- REMOVE THE EXISTING FRAME AND COVER FROM SSMH-01, SSMH-65151 AND SSMH-65152 AND INSTALL A WATERTIGHT FRAME AND COVER AS DESCRIBED IN HARFORD COUNTY STANDARD DETAIL SHOWN ON THE SEWER DETAILS. FLUSH EXISTING SEWER MAIN WITH CLEAN WATER PRIOR TO REMOVAL.
- ESTABLISH ACCESS TO COMMENCE REPLACEMENT OF THE 8" SANITARY SEWER PIPE FROM SEWER STATION 0+00 TO 2+45.
- IN THE EVENT OF DAMAGE TO THE EXISTING SEWER MAIN, THE CONTRACTOR MUST:
 - IMMEDIATELY NOTIFY HARFORD COUNTY WATER AND SEWER.
 - HAVE APPROVED REPAIR CLAMPS ON SITE TO FIT THE OUTER DIAMETER (OD) THE ASBESTOS CEMENT (AC) PIPE.
 - HAVE AN APPROVED SEWER BYPASS PLAN.
 - IMPLEMENT THE SEWER BYPASS PLAN TO PREVENT SANITARY SEWER OVERFLOWS.
- THE CONTRACTOR IS RESPONSIBLE FOR PREVENTING AND CORRECTING SANITARY SEWER OVERFLOWS INCLUDING DISINFECTION, PUBLIC NOTIFICATION, AND PAYING FINES LEVIED BY MARYLAND DEPARTMENT OF ENVIRONMENT (MDE) ONTO HARFORD COUNTY.
- IF ANY ASBESTOS CEMENT PIPE NEEDS TO BE CUT, CUTTING SHALL BE PERFORMED FOLLOWING FEDERAL, STATE, AND LOCAL LAWS SUCH AS SPRAYING WHILE CUTTING TO PREVENT AIRBORNE ASBESTOS, BAGGING UP PIECES FOR TEMPORARY STORAGE, AND DISPOSAL AT AN APPROVED ASBESTOS WASTE FACILITY IN A NEIGHBORING STATE ALONG WITH APPROPRIATE AND TRACEABLE CHAIN-OF-CUSTODY MANIFESTS.
- UPON VERIFICATION BY HARFORD COUNTY DEPARTMENT OF PUBLIC WORKS AND AT AN APPROPRIATE TIME DURING THE STREAM RESTORATION CONSTRUCTION, CONTRACTOR MAY PROCEED WITH INSTALLING SHUTOFF PLUGS AND BYPASS PUMPING OPERATION OF SANITARY SEWER MANHOLES AS DETAILED IN THE PLANS.
- INSTALL PUMP PADS AND APPROPRIATE APPURTENANCES TO MAINTAIN THE BYPASS PUMPING OPERATION FOR THE DURATION OF THE SANITARY SEWER REPLACEMENT INCLUDING TIME REQUIRED FOR ALL TESTING REQUIREMENTS SPECIFIED IN HARFORD COUNTY SPECIFICATIONS.
- WHEN THE SHUTOFF PLUGS AND BYPASS PUMPS ARE INSTALLED AND OPERATIONAL, CONTRACTOR MAY BEGIN EXCAVATING THE PIPE TRENCH TO EXPOSE THE SANITARY SEWER PIPE TO BE REPLACED. PIPE TRENCH SECTIONS MUST BE CLOSED AT THE END OF EACH WORK DAY UNLESS WRITTEN APPROVAL IS GRANTED BY THE COUNTY. THE PIPE TRENCH SHALL BE PRACTICALLY PLUMB. NO SLOPING OR CUT-BACK IS ALLOWED WITHOUT WRITTEN APPROVAL BY THE COUNTY. CONTRACTOR MUST FIELD VERIFY THE EXACT LOCATION AND LENGTH OF THE SANITARY SEWER TO BE REPLACED. FLUSH TEMPORARY BYPASS LINE WITH CLEAN WATER AND DRAIN INTO PUBLIC SEWER PRIOR TO DISASSEMBLY.
- REMOVE THE EXISTING DUCTILE IRON PIPE CONNECTING SSMH-01 AND SSMH-02. INSPECT THE EXISTING GASKETS AND VERIFY THE NEW PVC PIPE WILL FIT. INSERT THE NEW PVC PIPE INTO THE MANHOLE GASKET UP TO THE EXISTING CHANNEL. CONTRACTOR SHALL CORE DRILL THE EXISTING SANITARY SEWER MANHOLES AS NECESSARY TO INSTALL THE NEW SANITARY SEWER PIPE.
- THE EXISTING MANHOLE CHANNEL AND BENCH SHALL BE SHAPED AS NECESSARY TO MEET THE PLAN INVERTS AND COUNTY SPECIFICATIONS.
- UTILIZE AN A-LOK FIELD KIT OR SIMILAR TO CONNECT THE NEW PIPE TO THE EXISTING SANITARY SEWER MANHOLES.
- INSTALL THE NEW PVC PIPE ON AN AGGREGATE BEDDING EXTENDING A MINIMUM OF 6" ABOVE THE SUBGRADE AS SHOWN IN THE DETAILS. GROUT PARGE THE CHANNELS OF SSMH-01 AND SSMH-02 TO REPAIR ANY DAMAGE.
- INSTALL CONCRETE ENCASEMENT AS SHOWN ON THE PLAN AND PROFILE. REFER TO STREAM DETAILS FOR ADDITIONAL REQUIREMENTS. SEWER ENCASEMENT SHALL BE TEMPORARILY STABILIZED WITH CLASS 1 RIPRAP. RIPRAP SHALL BE PLACED OVERTOP THE SEWER ENCASEMENT AS SHOWN IN THE STREAM RESTORATION DESIGN PLANS AND TIE INTO THE EXISTING CHANNEL AT A 3:1 SLOPE ON ALL SIDES.
- ONCE THE NEW PVC PIPE IS INSTALLED, PRIOR TO BACKFILLING THE CONTRACTOR SHALL COMPLETE PIPE TESTING REQUIREMENTS AS DESCRIBED IN THE HARFORD COUNTY WATER AND SEWER SPECIFICATIONS. THERE SHALL BE NO VISIBLE WATER LEAKS FROM THE CONSTRUCTED PIPE OR INSIDE ANY MANHOLE ALTERED DURING CONSTRUCTION.
- WHEN ALL REQUIRED TESTING IS COMPLETE, THE PIPE TRENCH SHALL BE BACKFILLED ACCORDING TO HARFORD COUNTY SPECIFICATIONS. THE CONTRACTOR SHALL BACKFILL THE TRENCH IN SUCH A MANNER THAT FINAL GRADE CAN BE ESTABLISHED AT AN APPROPRIATE TIME IN ACCORDANCE WITH AND AS SHOWN ON THE EDGEWATER VILLAGE STREAM RESTORATION PLAN AND PROFILE.
- COMPLETE INSTALLATION OF RIPRAP AT EXISTING SANITARY SEWER MANHOLE SSMH-65152 NEAR SEWER STATION 6+45 AT AN APPROPRIATE TIME DURING THE STREAM RESTORATION.
- ONCE ALL BACKFILL AND STABILIZATION MEASURES HAVE BEEN COMPLETED THE CONTRACTOR SHALL ARRANGE FOR AND OBTAIN ANY REQUIRED FINAL SITE INSPECTIONS AND CERTIFICATIONS FOR PROJECT CLOSEOUT.

BID No.:

HCG DWG ID No.:

STAFF - 1 inch

HARFORD COUNTY, MARYLAND


EDGEWATER VILLAGE PARK SEWER REPLACEMENT SEQUENCE OF CONSTRUCTION

S/C PLAN # XXXXX	Revisions
GP # XXXXX-XXXX	
SIGN AND SEAL	
Drawn By : LW	Scale : NTS
Designed By : LW	Date : SEPTEMBER 2025
Reviewed By : NK	
Drawing No. SS-03 OF SS-11	Sheet No.

CONTRACT NO. 2792A


PROFESSIONAL CERTIFICATION

I HEREBY CERTIFY THAT THESE DOCUMENTS WERE PREPARED OR APPROVED BY ME, AND THAT I AM A DULY LICENSED PROFESSIONAL ENGINEER UNDER THE LAWS OF THE STATE OF MARYLAND, LICENSE NO. XXXXX, EXPIRATION DATE: XX/XX/XXXX.

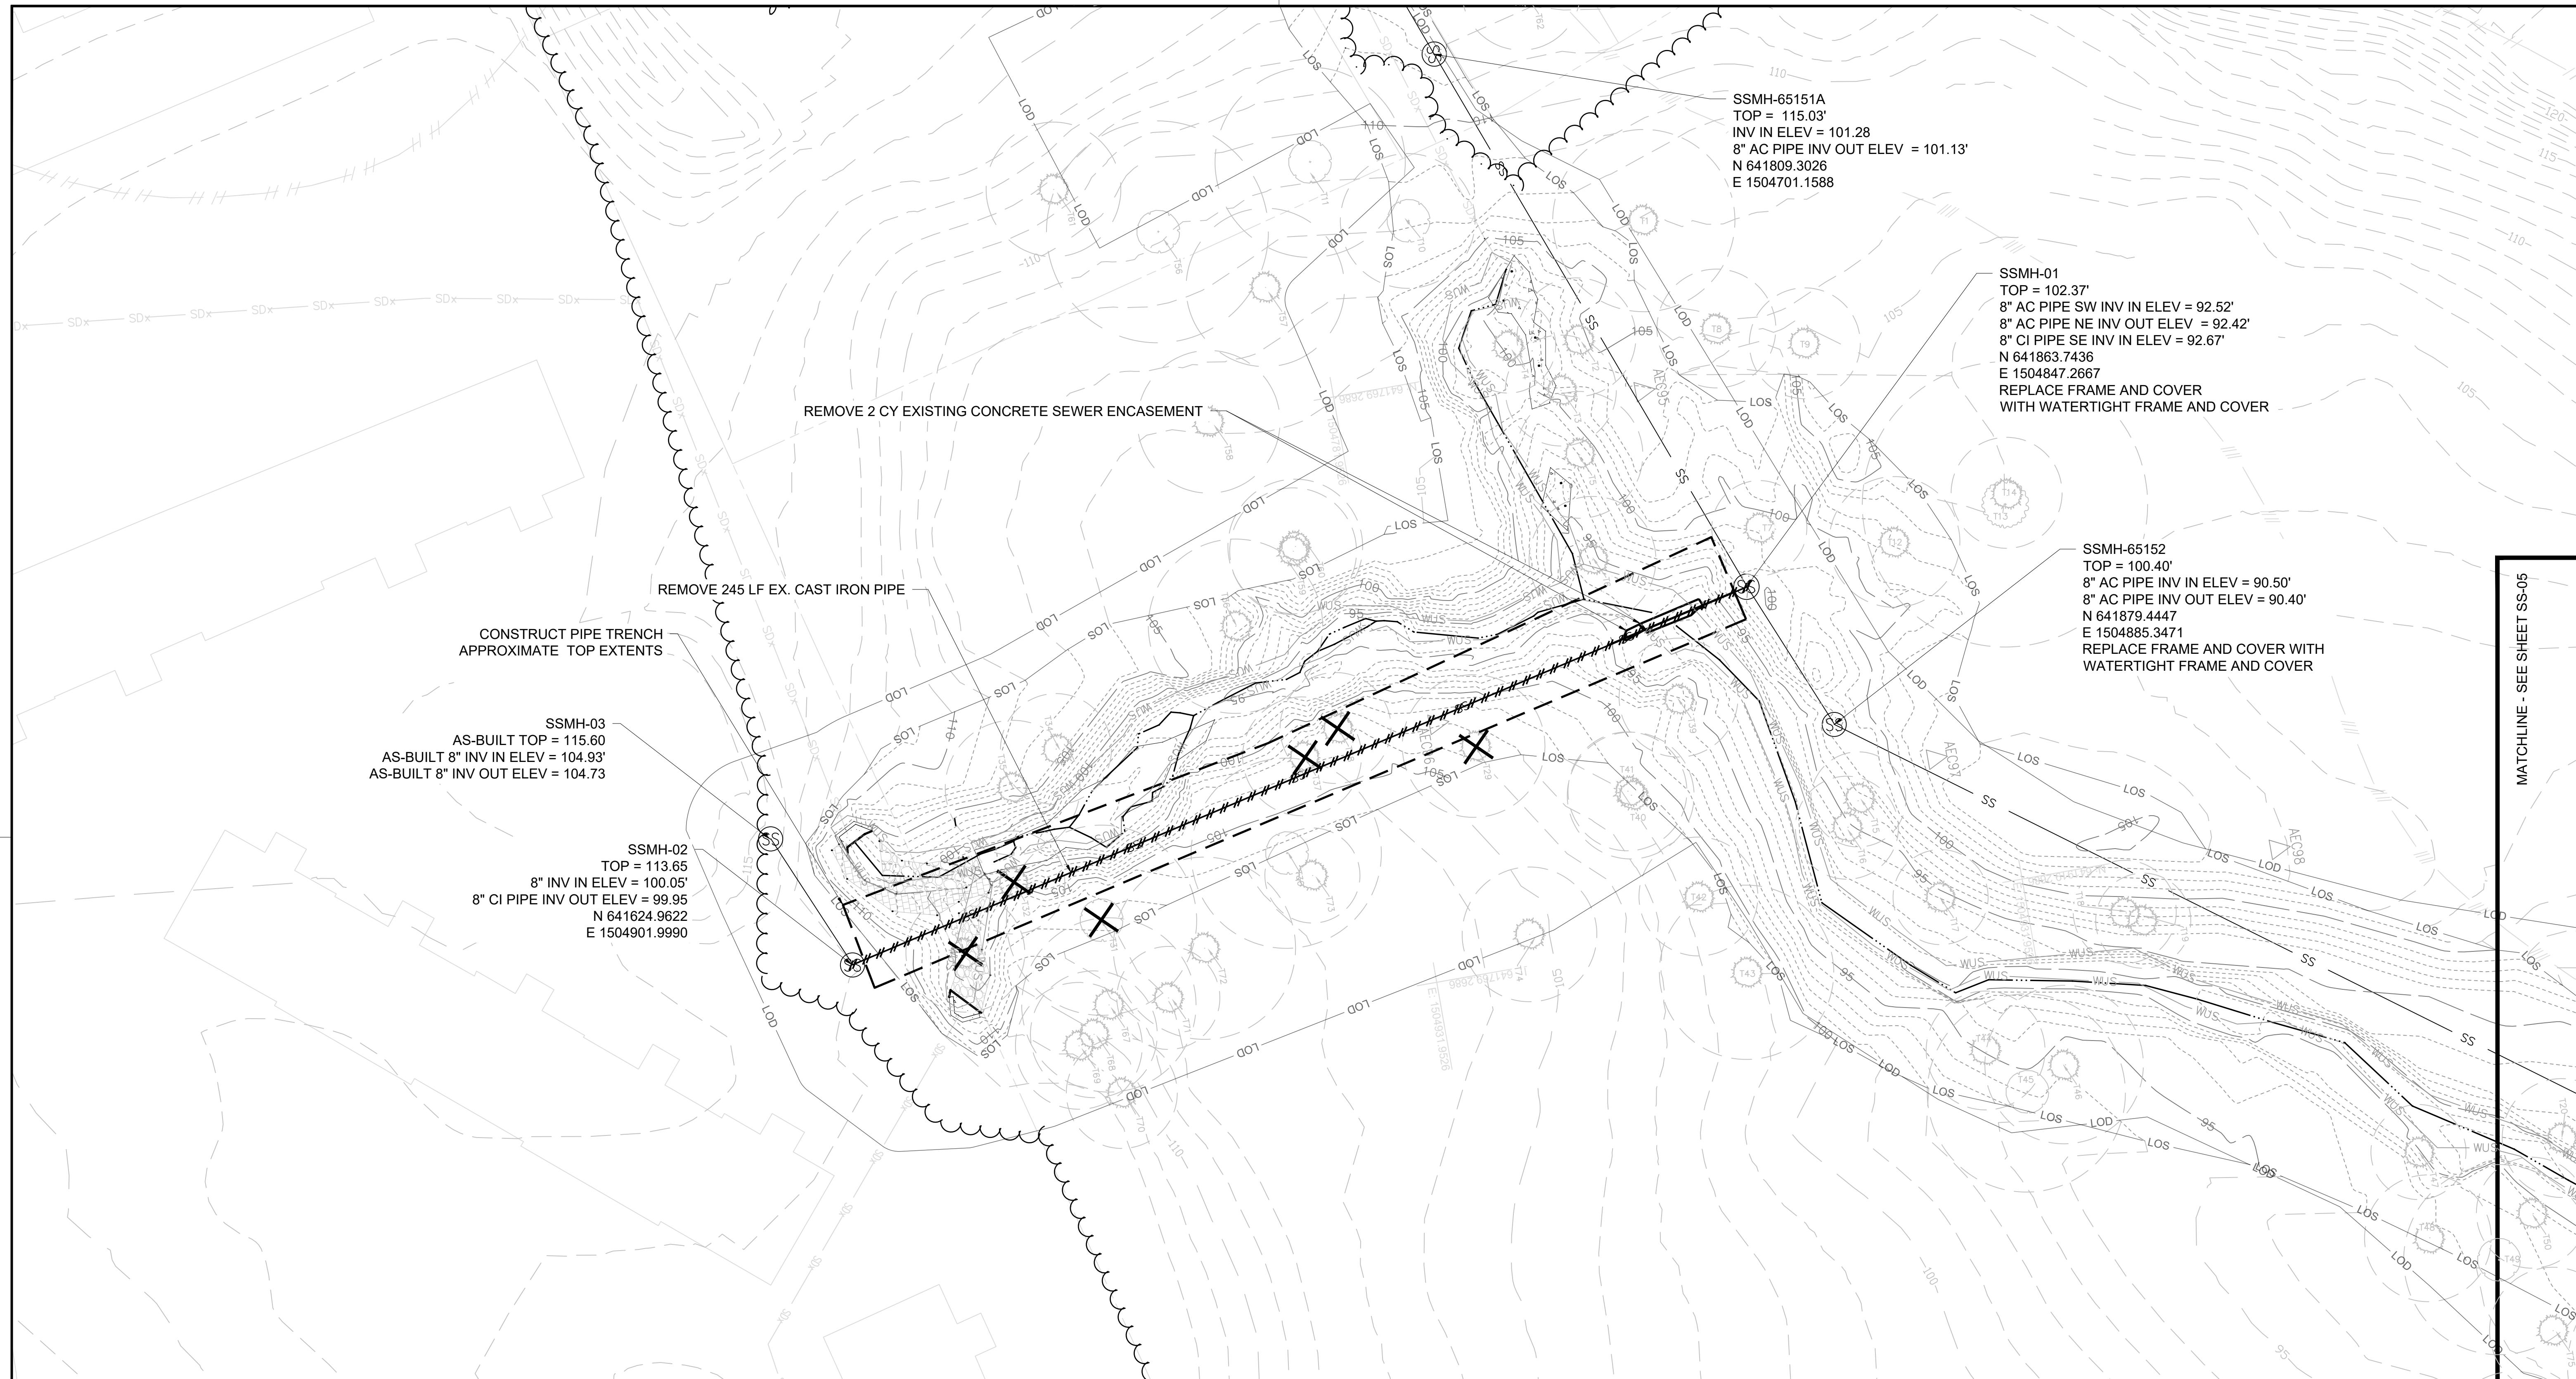

NOTES:

1. REMOVAL OF TREES IS SHOWN TO FACILITATE SEWER REPLACEMENT ONLY. CONTRACTOR SHALL COORDINATE ACTIVITIES WITH THE FOREST CONSERVATION PLAN WITHIN THE EDGEWATER VILLAGE PARK STREAM RESTORATION PLANS.
2. EXISTING GASKETS OR THE PIPE PENETRATIONS MUST REMAIN UNDAMAGED DURING CONSTRUCTION DURING REMOVAL OF DUCTILE IRON AND REPLACEMENT WITH PVC.
3. THERE ARE EXISTING PIPES IN THE PROJECT AREA THAT ARE ASBESTOS CEMENT (AC). SEE PLAN CALLOUTS. CONTRACTOR MUST TAKE APPROPRIATE MEASURES TO PREVENT DAMAGE TO ASBESTOS CEMENT PIPES. IN THE EVENT AN ASBESTOS CEMENT PIPE IS DAMAGED, THE CONTRACTOR MUST FOLLOW FEDERAL AND STATE LAWS REGARDING ASBESTOS PPE, DUST CONTAINMENT, BAGGED RUBBLE CONTAINMENT, TRANSPORTATION REGULATION INCLUDING APPROPRIATE MANIFEST, AND DISPOSAL IN CERTIFIED FACILITIES. CONTRACTOR MUST TAKE APPROPRIATE MEASURES TO PREVENT DAMAGE TO ASBESTOS CEMENT PIPES.

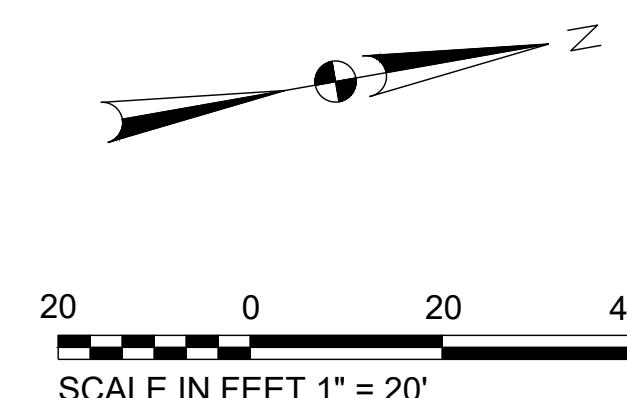


CONTRACT NO. 2792A	
PROFESSIONAL CERTIFICATION	
<small>I HEREBY CERTIFY THAT THESE DOCUMENTS WERE PREPARED OR APPROVED BY ME, AND THAT I AM A DULY LICENSED PROFESSIONAL ENGINEER UNDER THE LAWS OF THE STATE OF MARYLAND. LICENSE NO. XXXXX, EXPIRATION DATE: XX/XX/XXXX.</small>	

S/C PLAN # XXXXX	Revisions
GP # XXXXX-XXXX	SIGN AND SEAL
Drawn By : LW	
Designed By : LW	
Reviewed By : NK	
Drawing No. SS-04 OF SS-11	Sheet No. 58 of 65


HARFORD COUNTY, MARYLAND
EDGEWATER VILLAGE PARK
SEWER REPLACEMENT
EXISTING CONDITIONS/DEMOLITION

Scale : 1" = 20'
Date : SEPTEMBER 2025

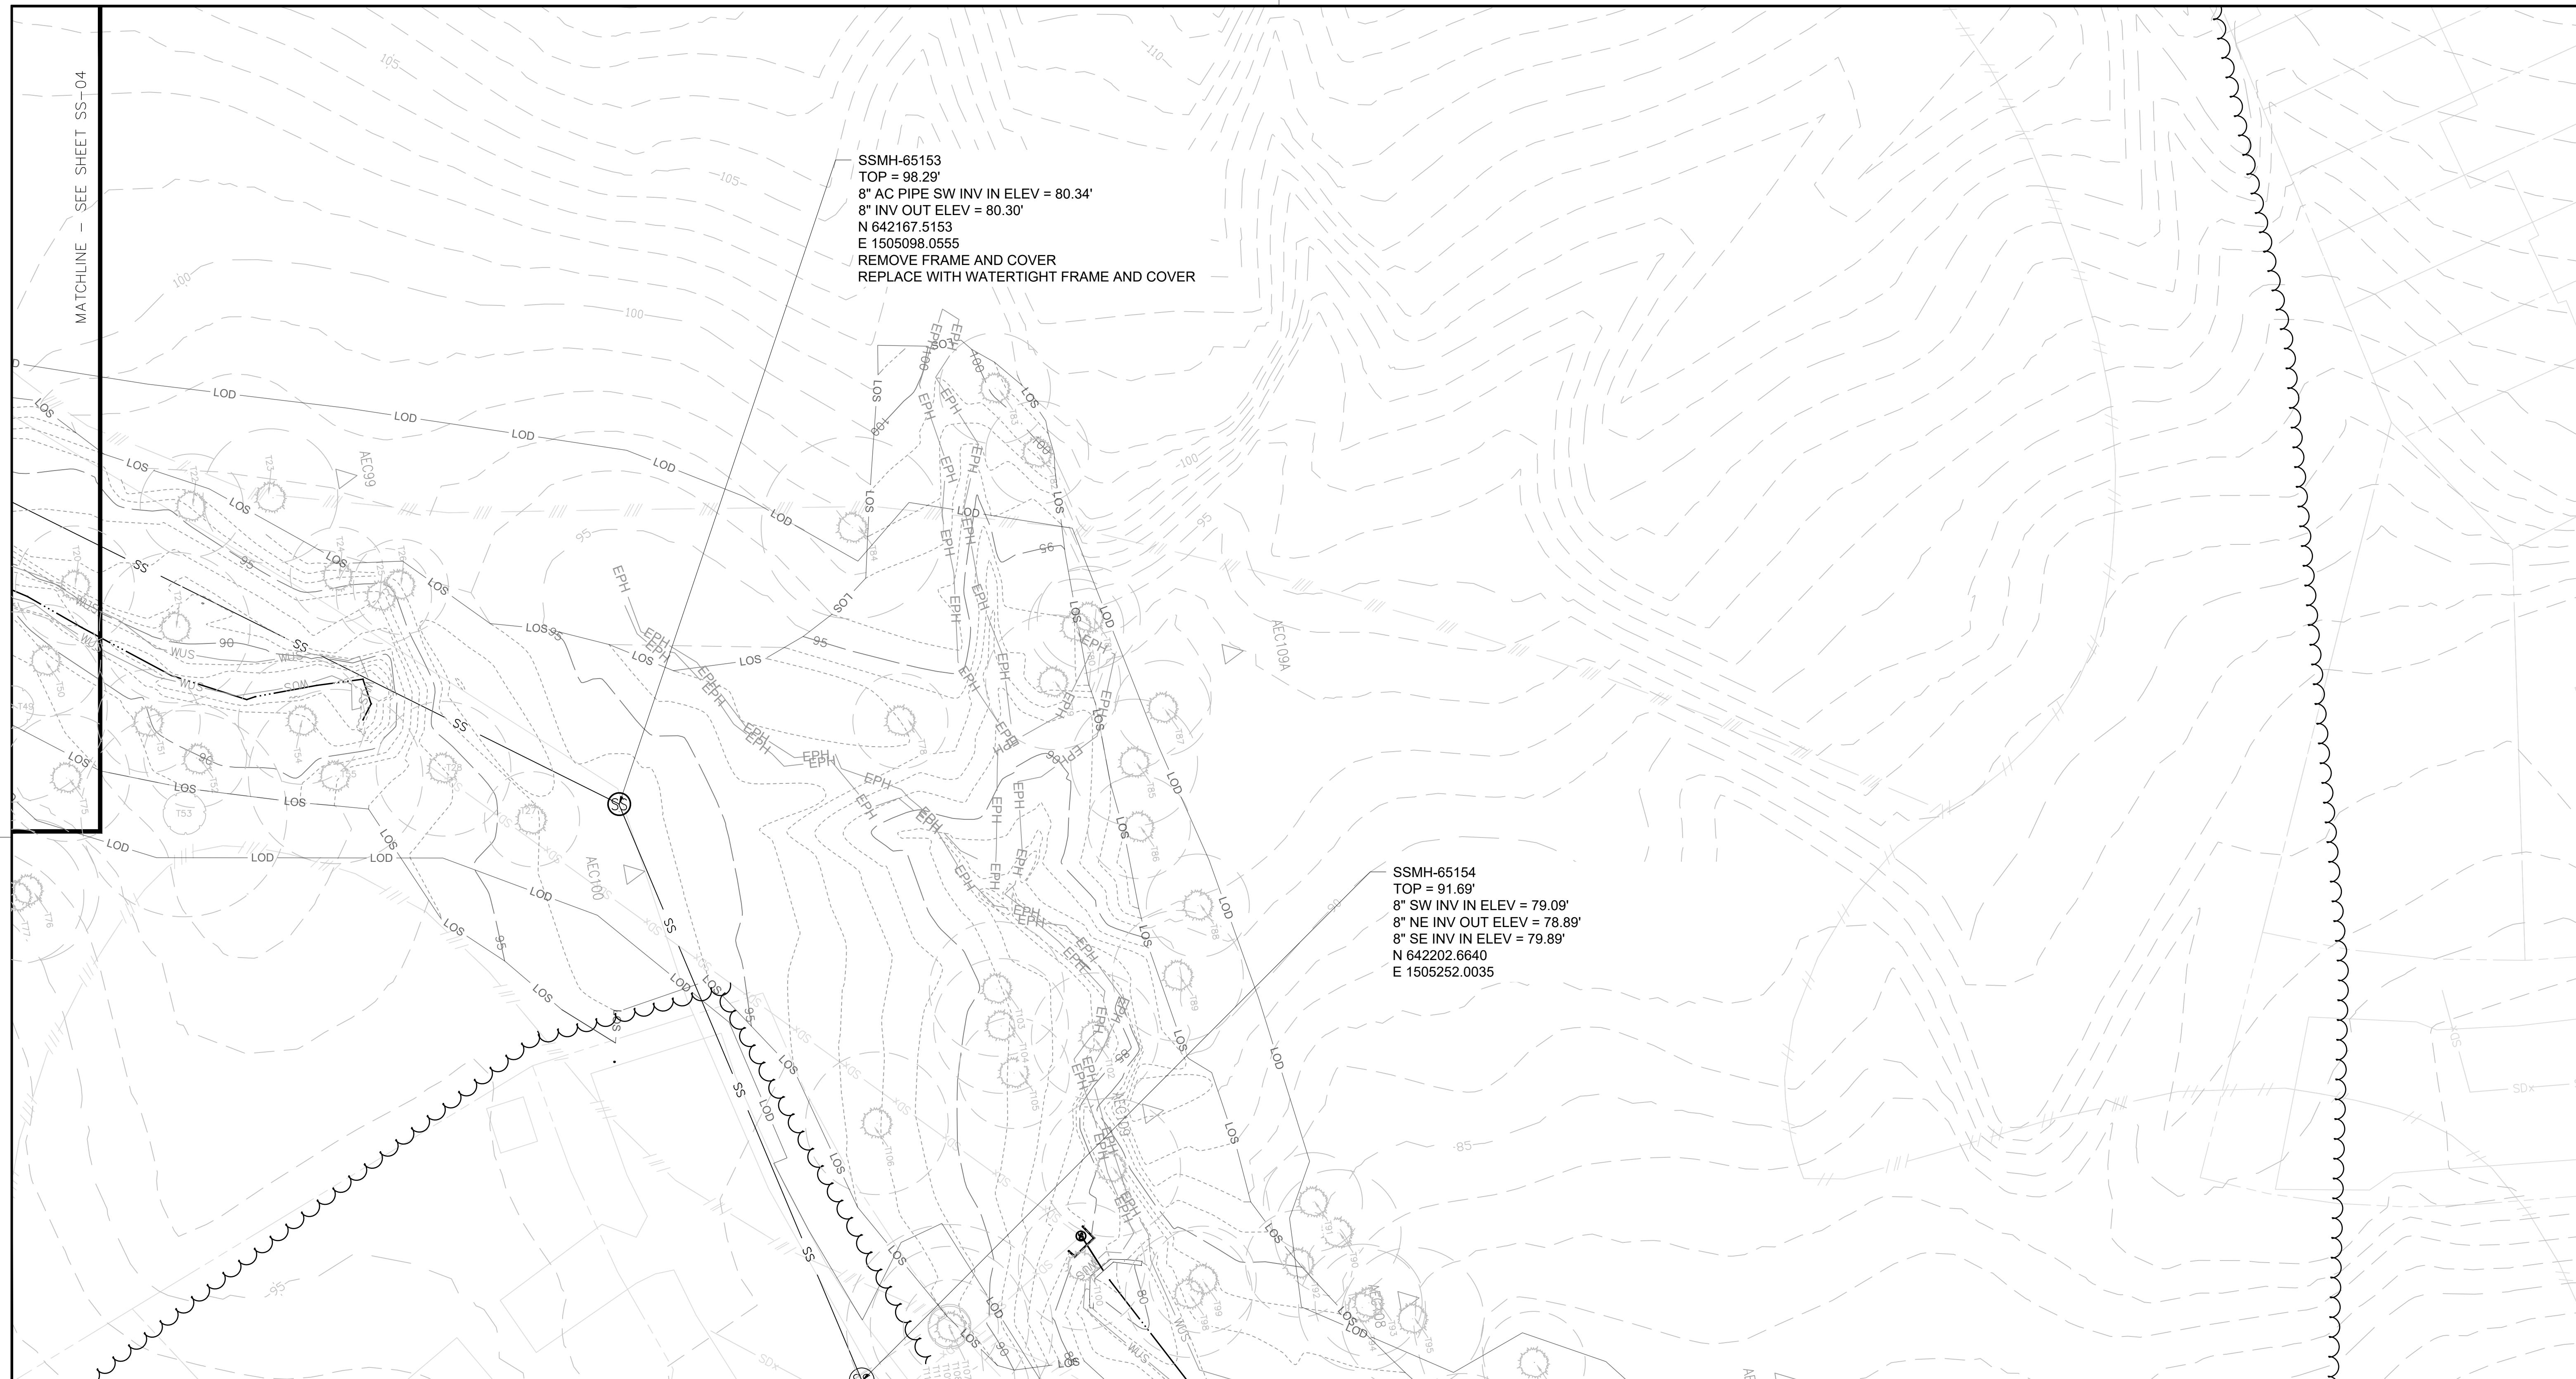

NOTES:

1. REMOVAL OF TREES IS SHOWN TO FACILITATE SEWER REPLACEMENT ONLY. CONTRACTOR SHALL COORDINATE ACTIVITIES WITH THE FOREST CONSERVATION PLAN WITHIN THE EDGEWATER VILLAGE PARK STREAM RESTORATION PLANS.
2. EXISTING GASKETS OR THE PIPE PENETRATIONS MUST REMAIN UNDAMAGED DURING CONSTRUCTION DURING REMOVAL OF DUCTILE IRON AND REPLACEMENT WITH PVC.
3. THERE ARE EXISTING PIPES IN THE PROJECT AREA THAT ARE ASBESTOS CEMENT (AC). SEE PLAN CALLOUTS. CONTRACTOR MUST TAKE APPROPRIATE MEASURES TO PREVENT DAMAGE TO ASBESTOS CEMENT PIPES. IN THE EVENT AN ASBESTOS CEMENT PIPE IS DAMAGED, THE CONTRACTOR MUST FOLLOW FEDERAL AND STATE LAWS REGARDING ASBESTOS PPE, DUST CONTAINMENT, BAGGED RUBBLE CONTAINMENT, TRANSPORTATION REGULATION INCLUDING APPROPRIATE MANIFEST, AND DISPOSAL IN CERTIFIED FACILITIES. CONTRACTOR MUST TAKE APPROPRIATE MEASURES TO PREVENT DAMAGE TO ASBESTOS CEMENT PIPES.

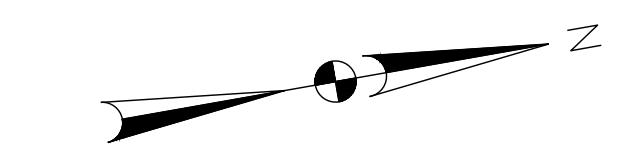

20 0 20 40
SCALE IN FEET 1" = 20'



CONTRACT NO. 2792A	
PROFESSIONAL CERTIFICATION	
I HEREBY CERTIFY THAT THESE DOCUMENTS WERE PREPARED OR APPROVED BY ME, AND THAT I AM A DULY LICENSED PROFESSIONAL ENGINEER UNDER THE LAWS OF THE STATE OF MARYLAND. LICENSE NO. XXXXX, EXPIRATION DATE: XX/XX/XXXX.	

S/C PLAN # XXXXX	Revisions
GP # XXXXX-XXXX	
SIGN AND SEAL	

HARFORD COUNTY, MARYLAND

EDGEWATER VILLAGE PARK
SEWER REPLACEMENT
EXISTING CONDITIONS/DEMOLITION

Drawn By : _____	LW
Designed By : _____	LW
Reviewed By : _____	NK
Drawing No.	SS-05 OF SS-11
Sheet No.	59 of 65

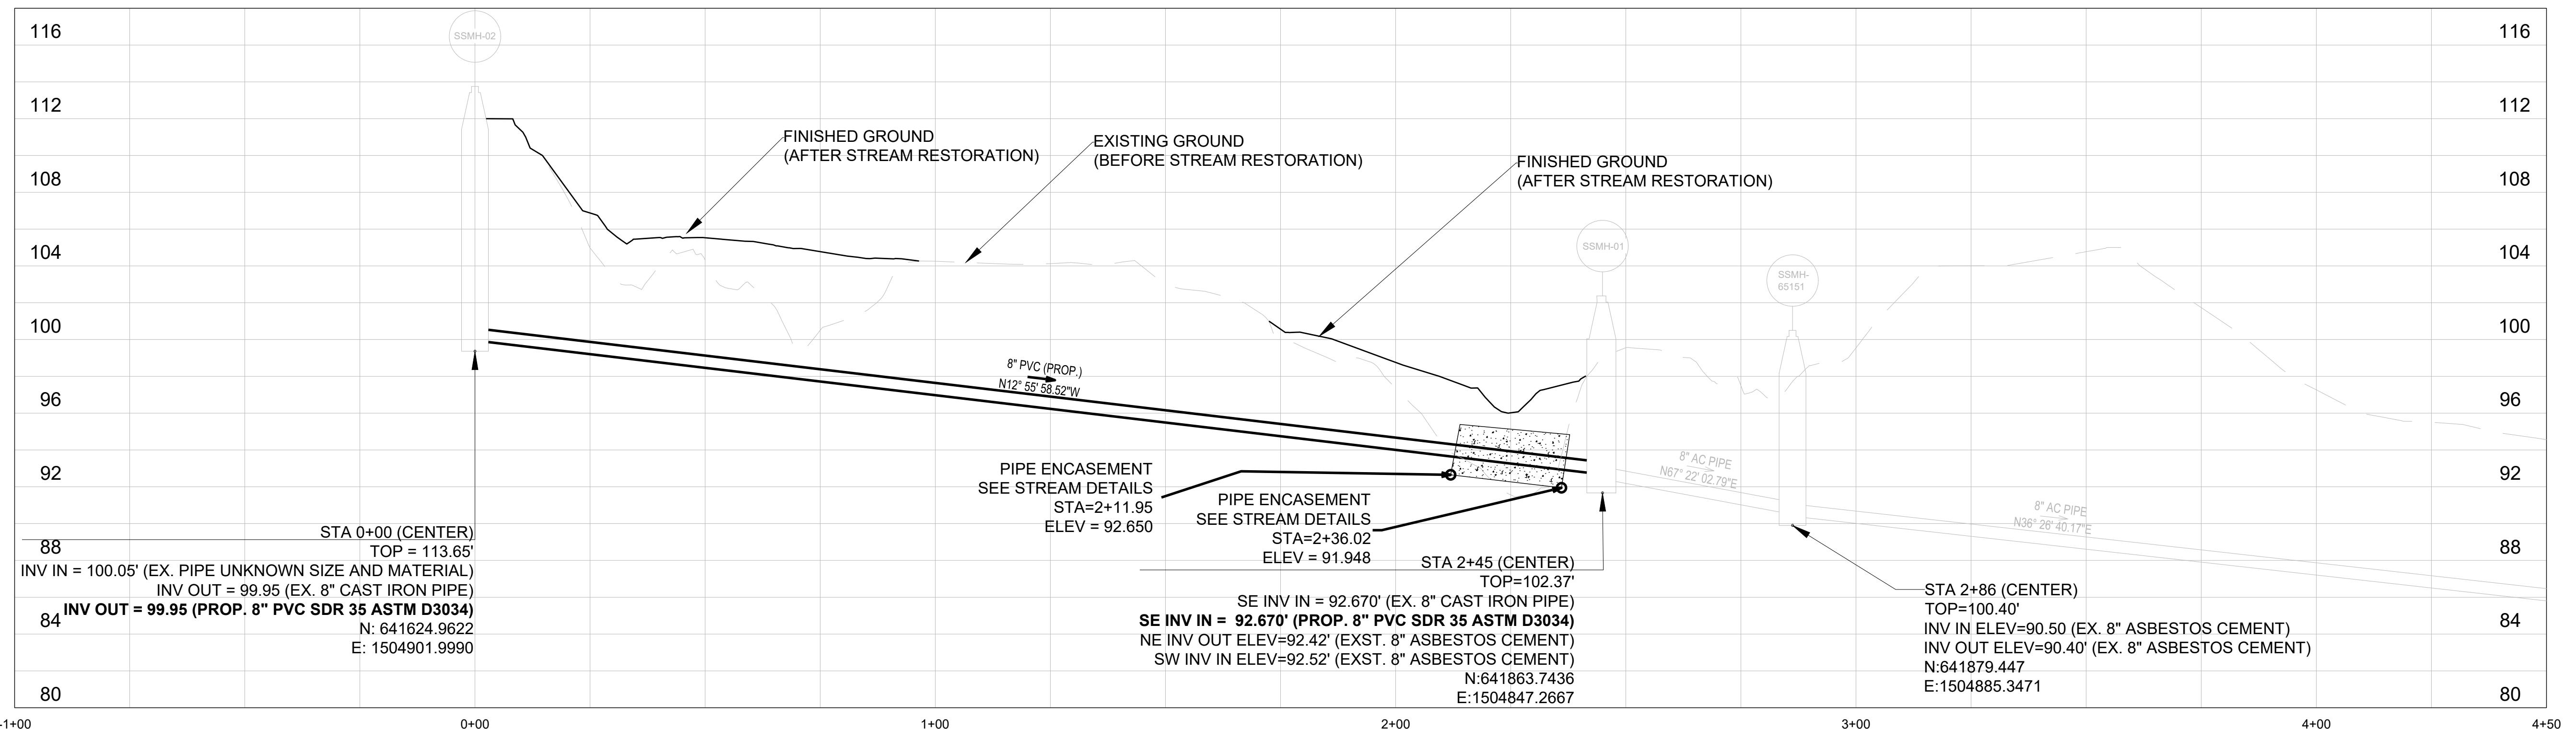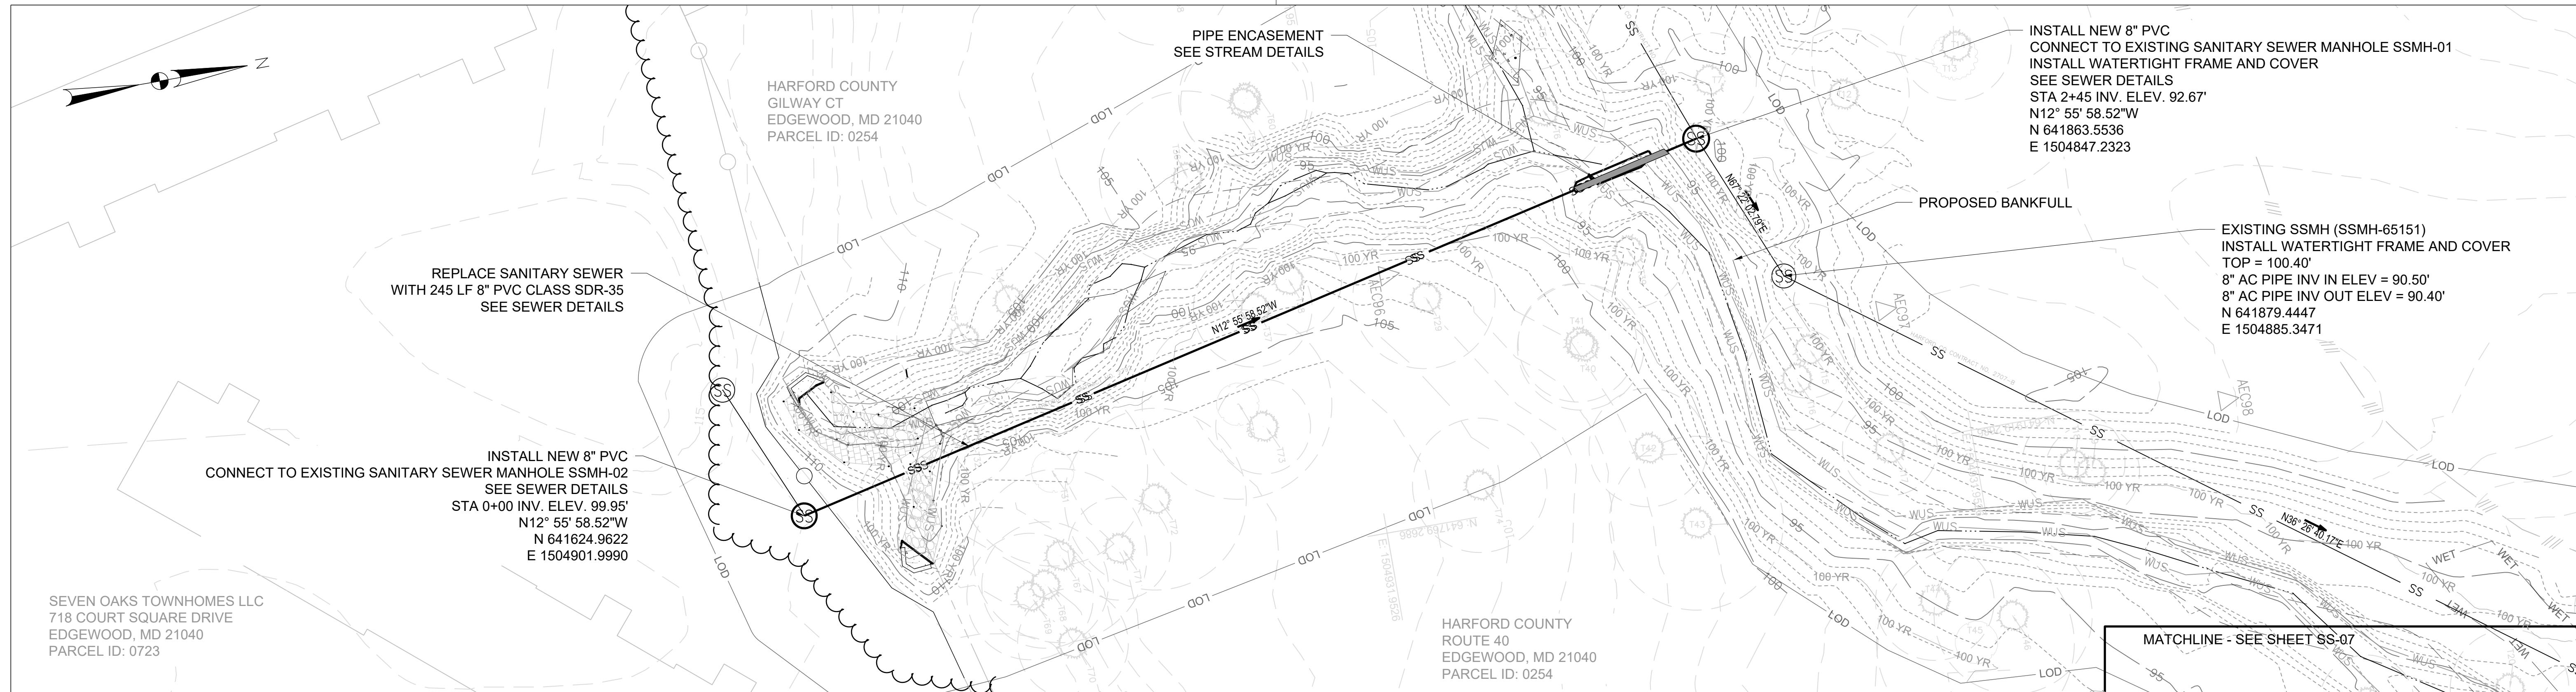

S/C PLAN # XXXXX		Revisions	
GP # XXXXX-XXXX			
SIGN AND SEAL		Drawn By : <u>LW</u>	
		Designed By : <u>LW</u>	
		Reviewed By : <u>NK</u>	
		Drawing No. SS-06 OF SS-11	
Scale : <u>AS SHOWN</u> Date : <u>SEPTEMBER 2025</u>			

HARFORD COUNTY, MARYLAND

EDGEWATER VILLAGE PARK
SEWER REPLACEMENT
SANITARY SEWER PLAN AND PROFILE

CONTRACT NO. 2792A

PROFESSIONAL CERTIFICATION




I HEREBY CERTIFY THAT THESE DOCUMENTS WERE PREPARED OR APPROVED BY ME,
AND THAT I AM A DULY LICENSED PROFESSIONAL ENGINEER UNDER THE LAWS OF
THE STATE OF MARYLAND LICENSE NO. XXXXX, EXPIRATION DATE: XX/XX/XXXX.

PROFILE VERTICAL SCALE
5 0 5 10
SCALE IN FEET 1" = 5'

HORIZONTAL SCALE
20 0 20 40
SCALE IN FEET 1" = 20'

HOG DWG ID No.:

SCALE : 1 in ¹/₆₅

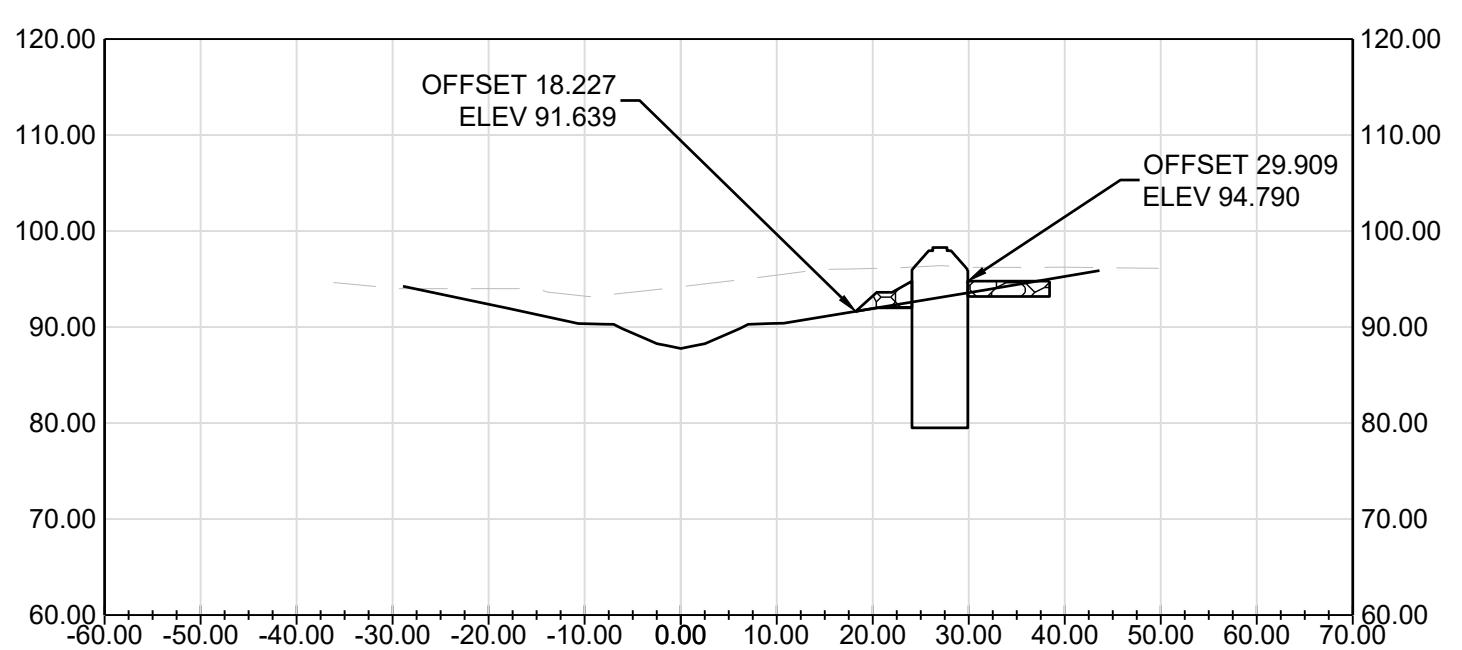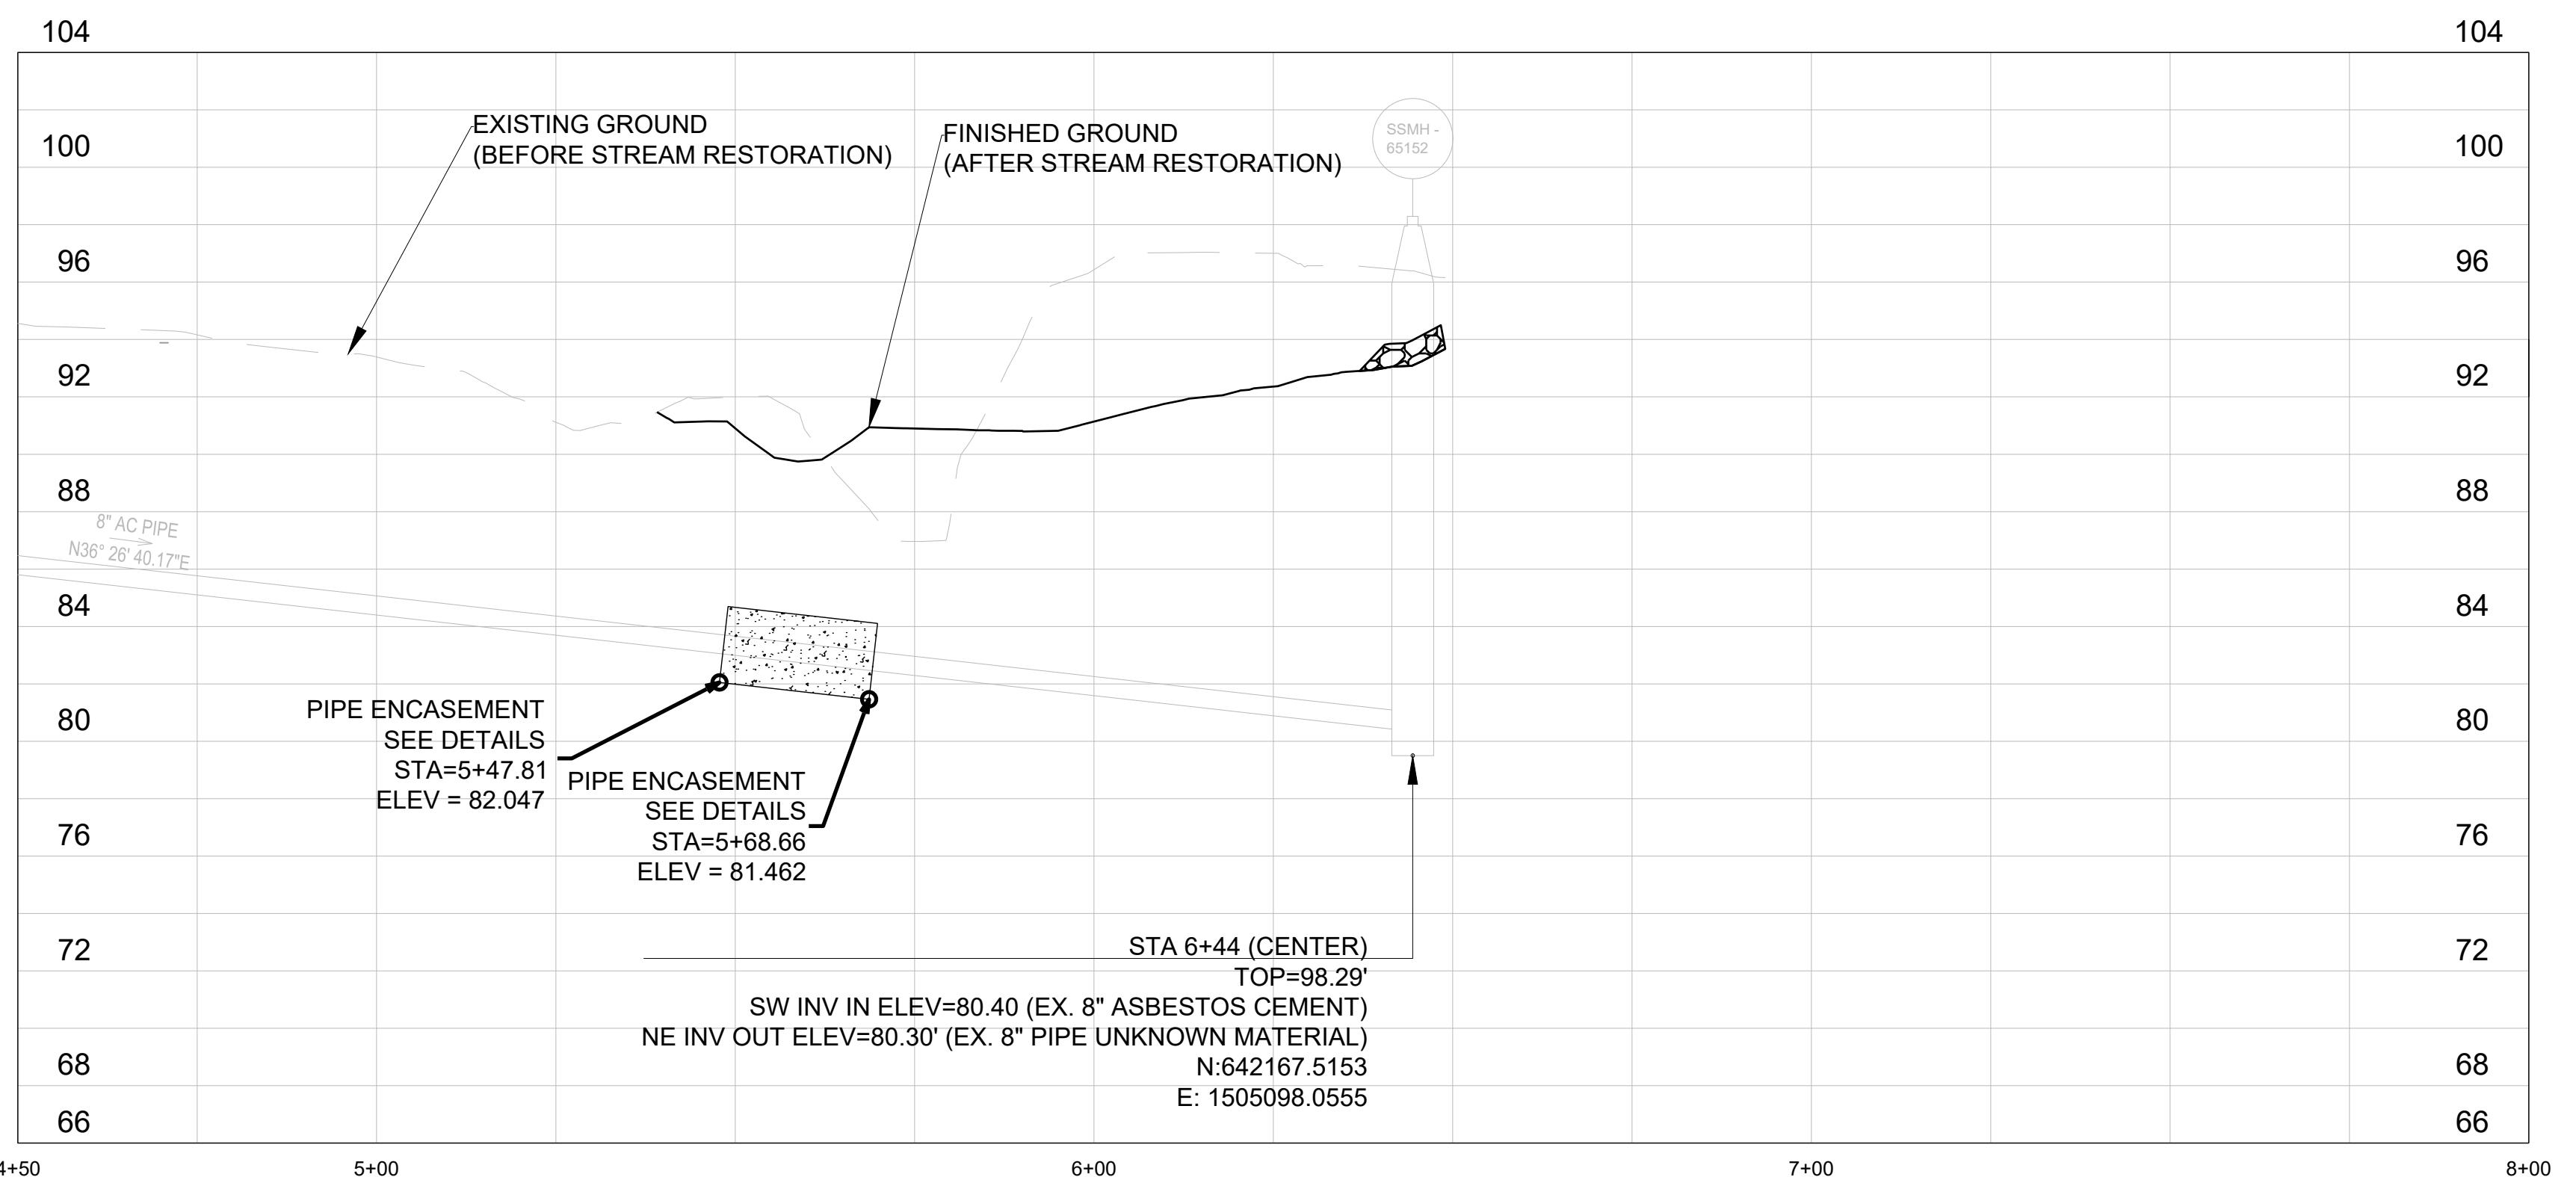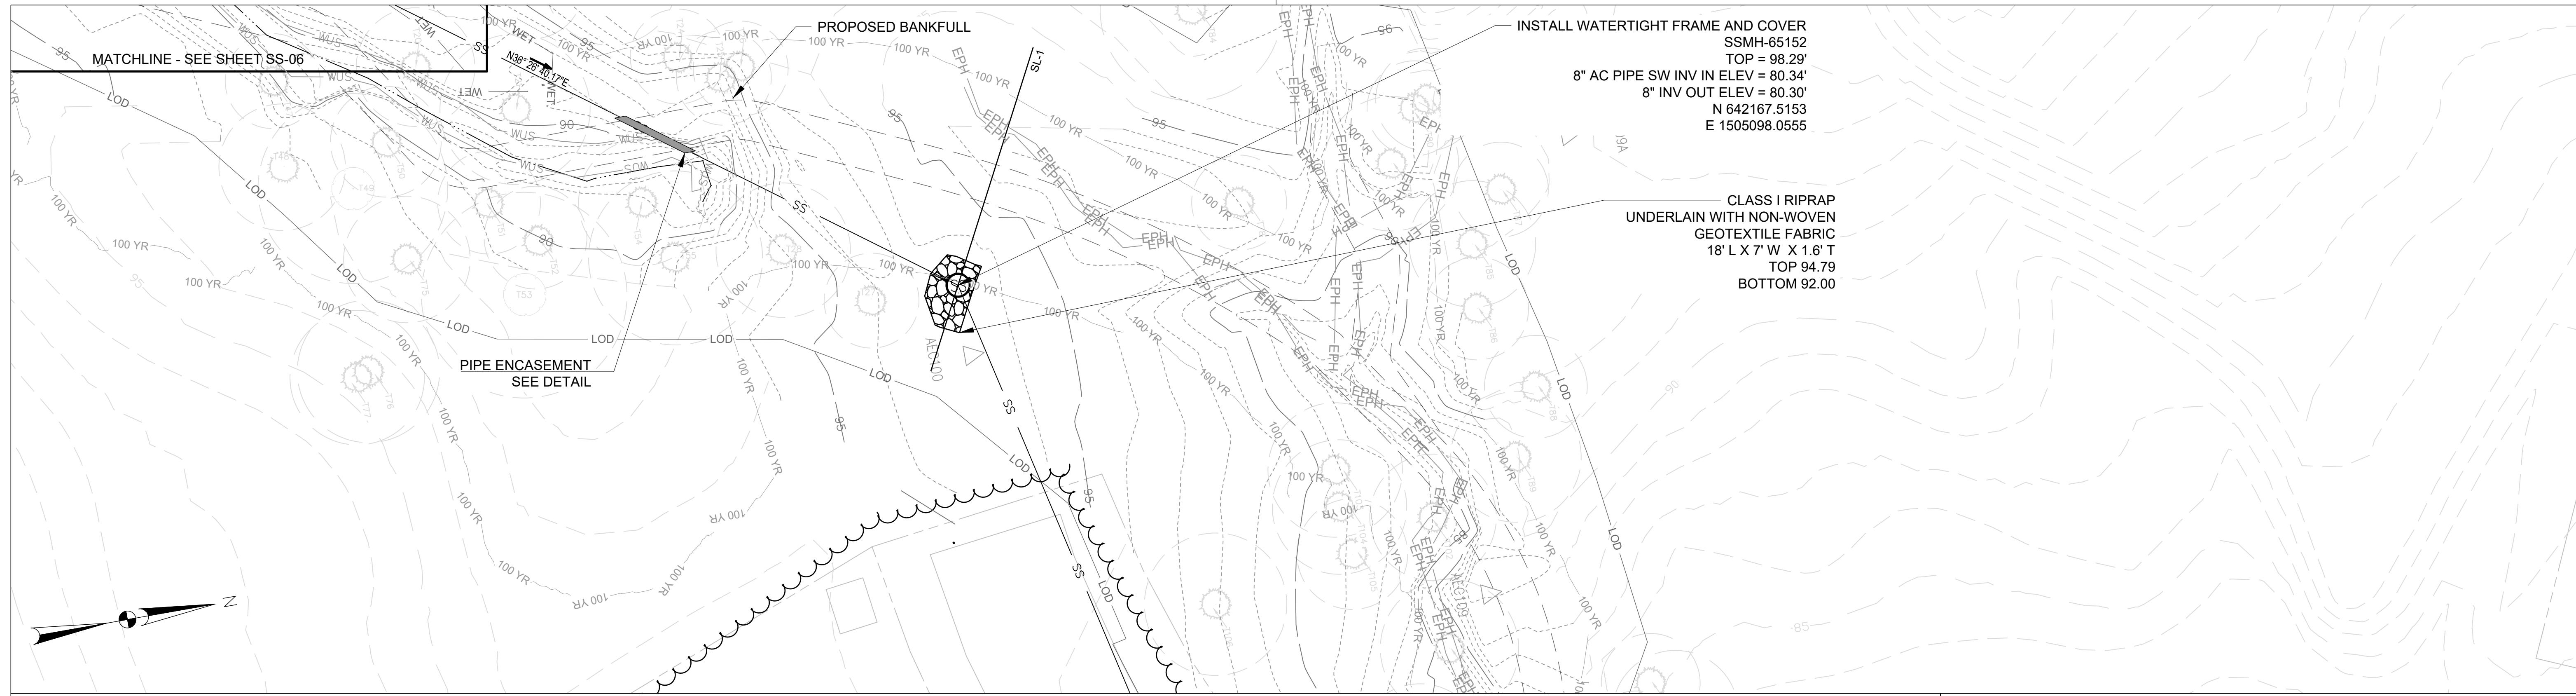

HARFORD COUNTY, MARYI AND

EDGEWATER VILLAGE PARK SEWER REPLACEMENT

SANITARY SEWER PLAN AND PROFILE

S/C PLAN # XXXXX	Revisions	EDGEWATER VILLAGE PARK SEWER REPLACEMENT SANITARY SEWER PLAN AND PROFILE		
GP # XXXXX-XXXX		Drawn By : LW	Scale : 1" = 20'	
SIGN AND SEAL		Designed By : LW	Date : SEPTEMBER 2025	
		Reviewed By : NK		
		Drawing No. SS-07 OF SS-11	Sheet No. 61 of 65	

SECTION VERTICAL SCALE
20 0 20

SCALE IN FEET 1" = 20'

PROFILE VERTICAL SCALE
0 5 0 5

SCALE IN FEET 1" = 5'

HORIZONTAL SCALE (ALL VIEWS)

10 20 0 20

SCALE IN FEET 1" = 20'

CONTRACT NO. 0700

PROFESSIONAL CERTIFICATION

I HEREBY CERTIFY THAT THESE DOCUMENTS WERE PREPARED OR APPROVED BY
AND THAT I AM A DULY LICENSED PROFESSIONAL ENGINEER UNDER THE LAWS
THE STATE OF MARYLAND. LICENSE NO. XXXXX, EXPIRATION DATE: XX/XX/XXXX.

HARFORD COUNTY
GILWAY CT
EDGEGOOD, MD 21040
PARCEL ID: 0254

HARFORD COUNTY
ROUTE 40
EDGEGOOD, MD 21040
PARCEL ID: 0254

SEVEN OAKS TOWNHOMES LLC
718 COURT SQUARE DRIVE
EDGEGOOD, MD 21040
PARCEL ID: 0723

EXISTING SSMH
SSMH-03

EXISTING SSMH
SSMH-02

INSTALL SHUTOFF PLUG
SEE SEWER DETAILS

HORIZONTAL SCALE
20 0 20 40
SCALE IN FEET 1" = 20'

CONTRACT NO. 2792A

PROFESSIONAL CERTIFICATION

I HEREBY CERTIFY THAT THESE DOCUMENTS WERE PREPARED OR APPROVED BY ME,
AND THAT I AM A DULY LICENSED PROFESSIONAL ENGINEER UNDER THE LAWS OF
THE STATE OF MARYLAND LICENSE NO. XXXXX, EXPIRATION DATE: XX/XX/XXXX.

EXISTING SANITARY SEWER MANHOLE
SSMH-65151A

INSTALL SHUTOFF PLUG
SEE SEWER DETAILS

PUMP PAD
ACTUAL LOCATION TO BE
DETERMINED BY CONTRACTOR

EXISTING SSMH
SSMH-01

EXISTING SSMH
SSMH-65151

BYPASS FLOW

SPAN STREAM WITH HDPE PIPE
OR APPROVED RIGID EQUIVALENT



HARFORD COUNTY, MARYLAND




EDGEGOOD VILLAGE PARK
SEWER REPLACEMENT
BYPASS PUMPING PLAN

S/C PLAN # XXXXX	Revisions	1" = 20'	
GP # XXXXX-XXXX	SIGN AND SEAL	SEPTEMBER 2025	
Drawn By : LW		Scale :	1" = 20'
Designed By : LW		Date :	SEPTEMBER 2025
Reviewed By : NK			
Drawing No. SS-08 OF SS-11		Sheet No.	62 of 65

BID No.:

HICG DWG ID No.:

SCALE : 1 in.

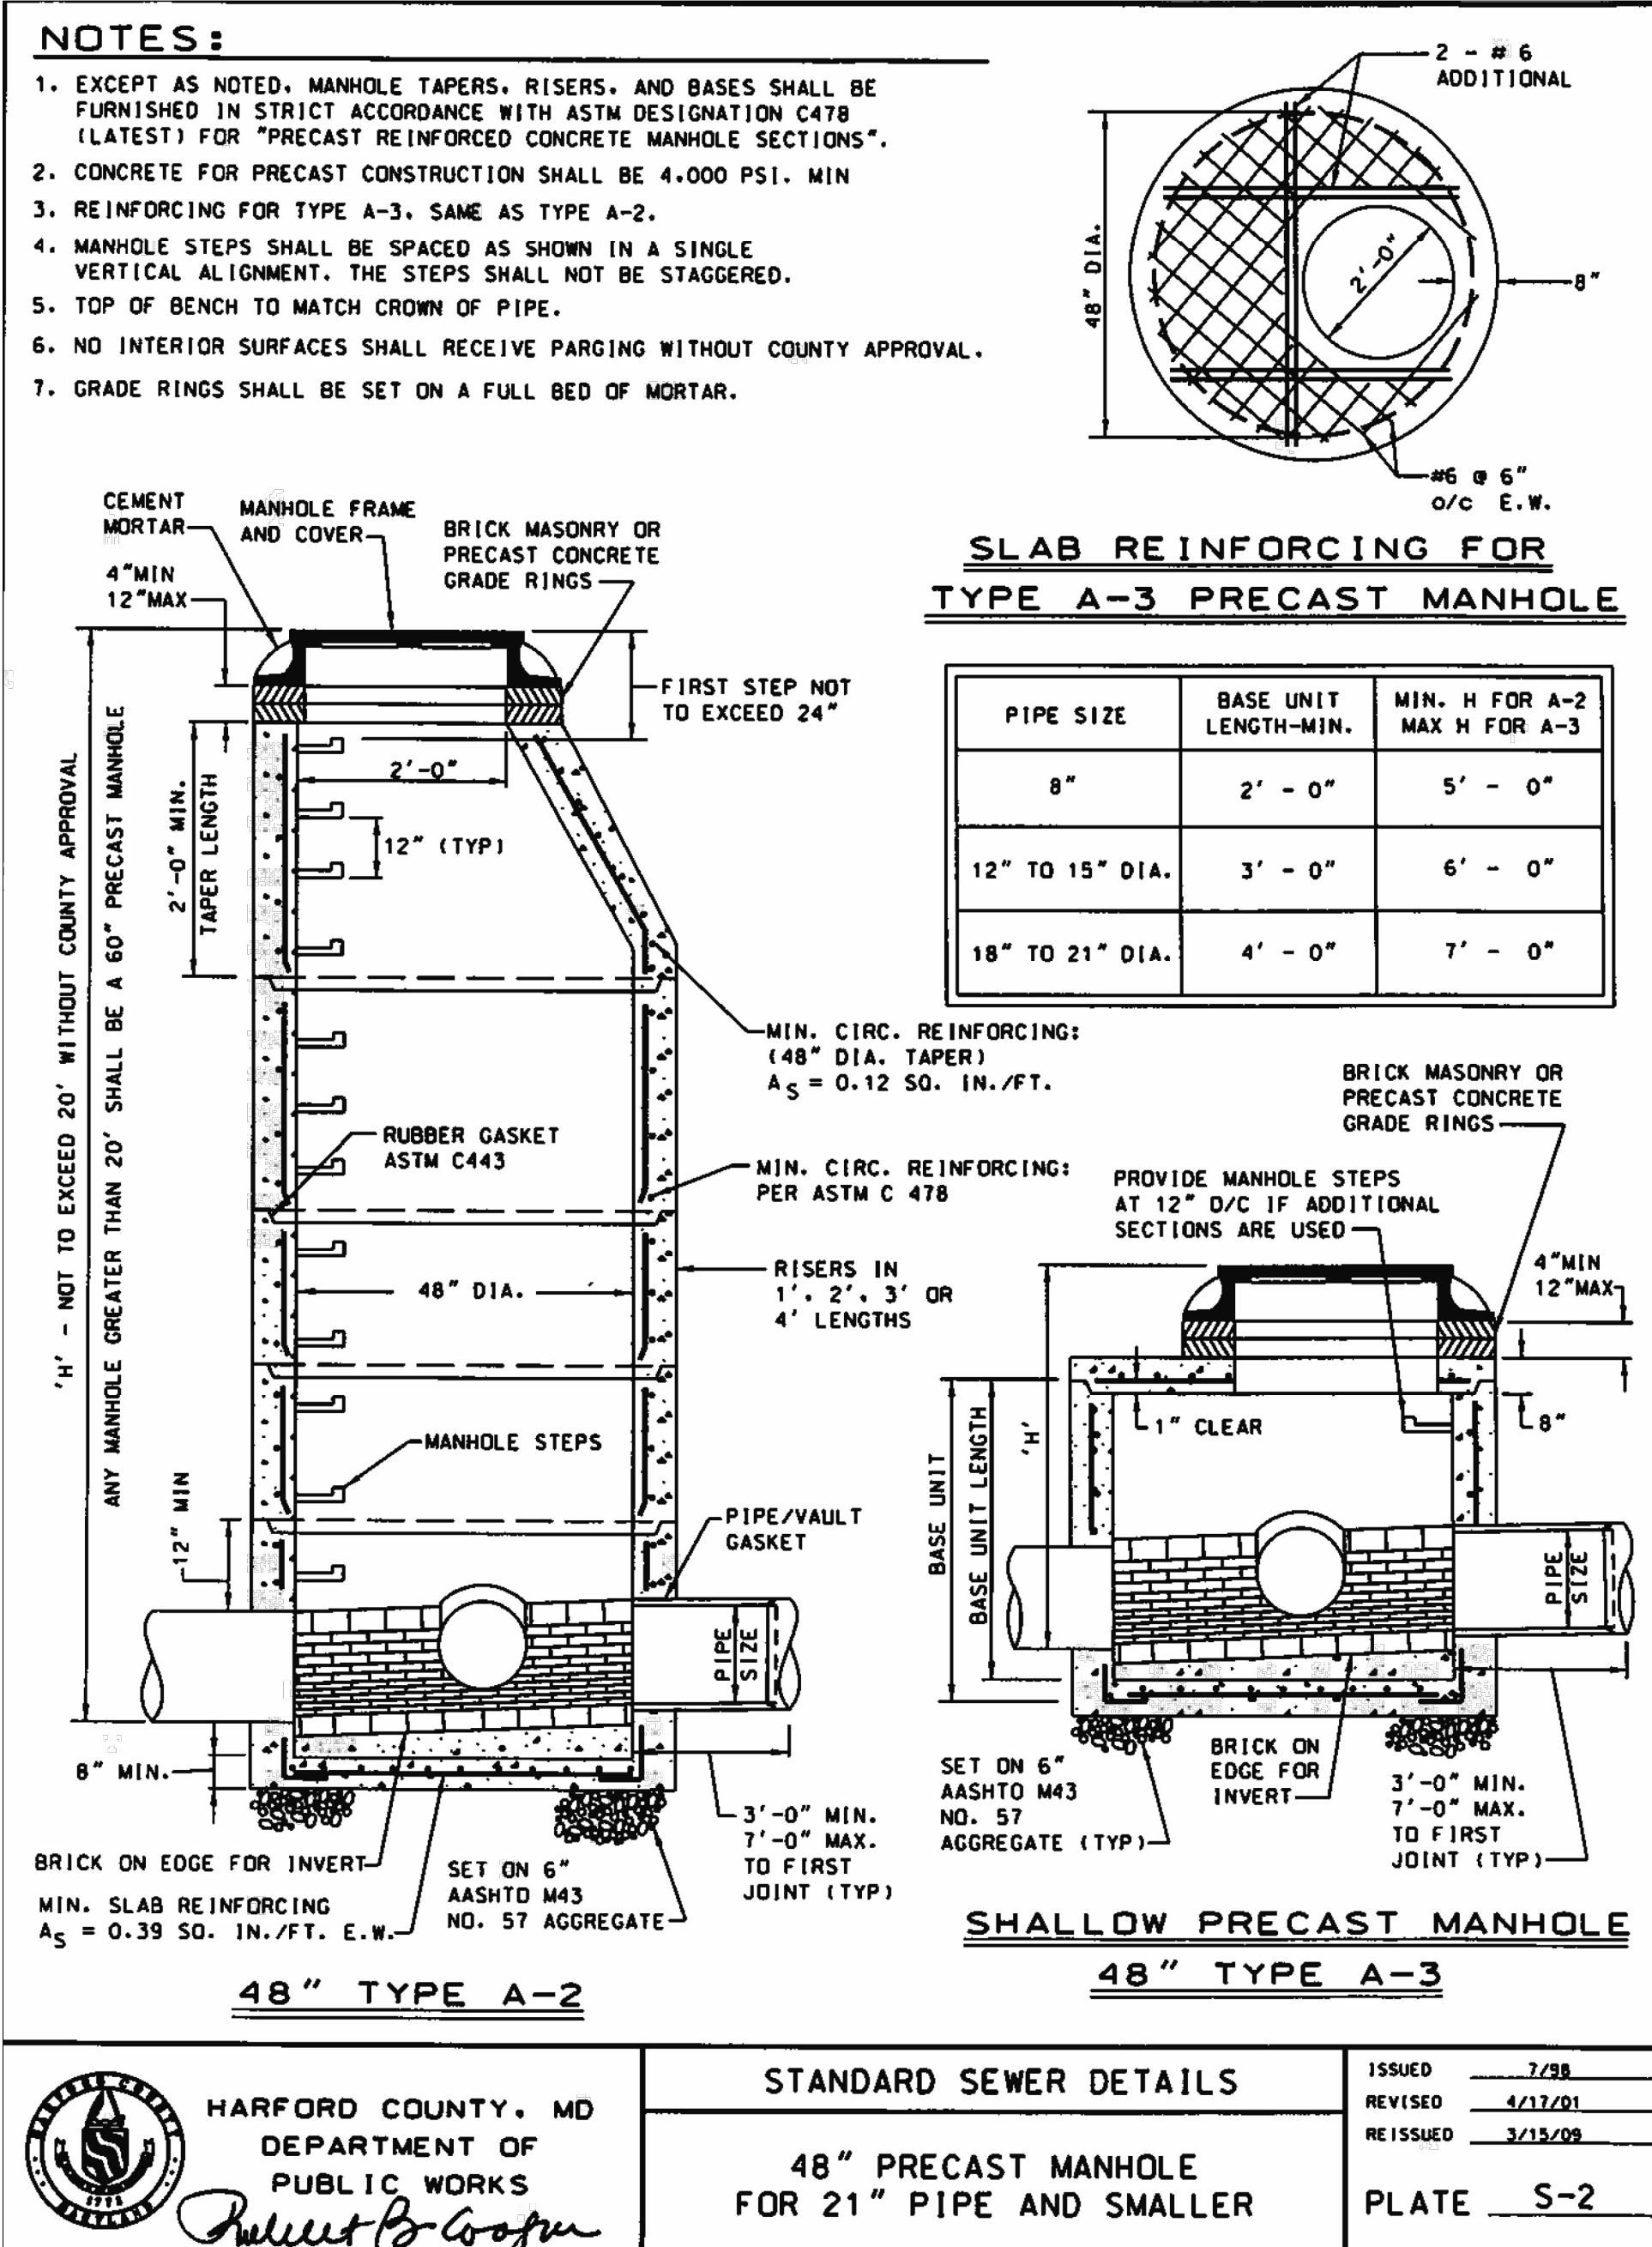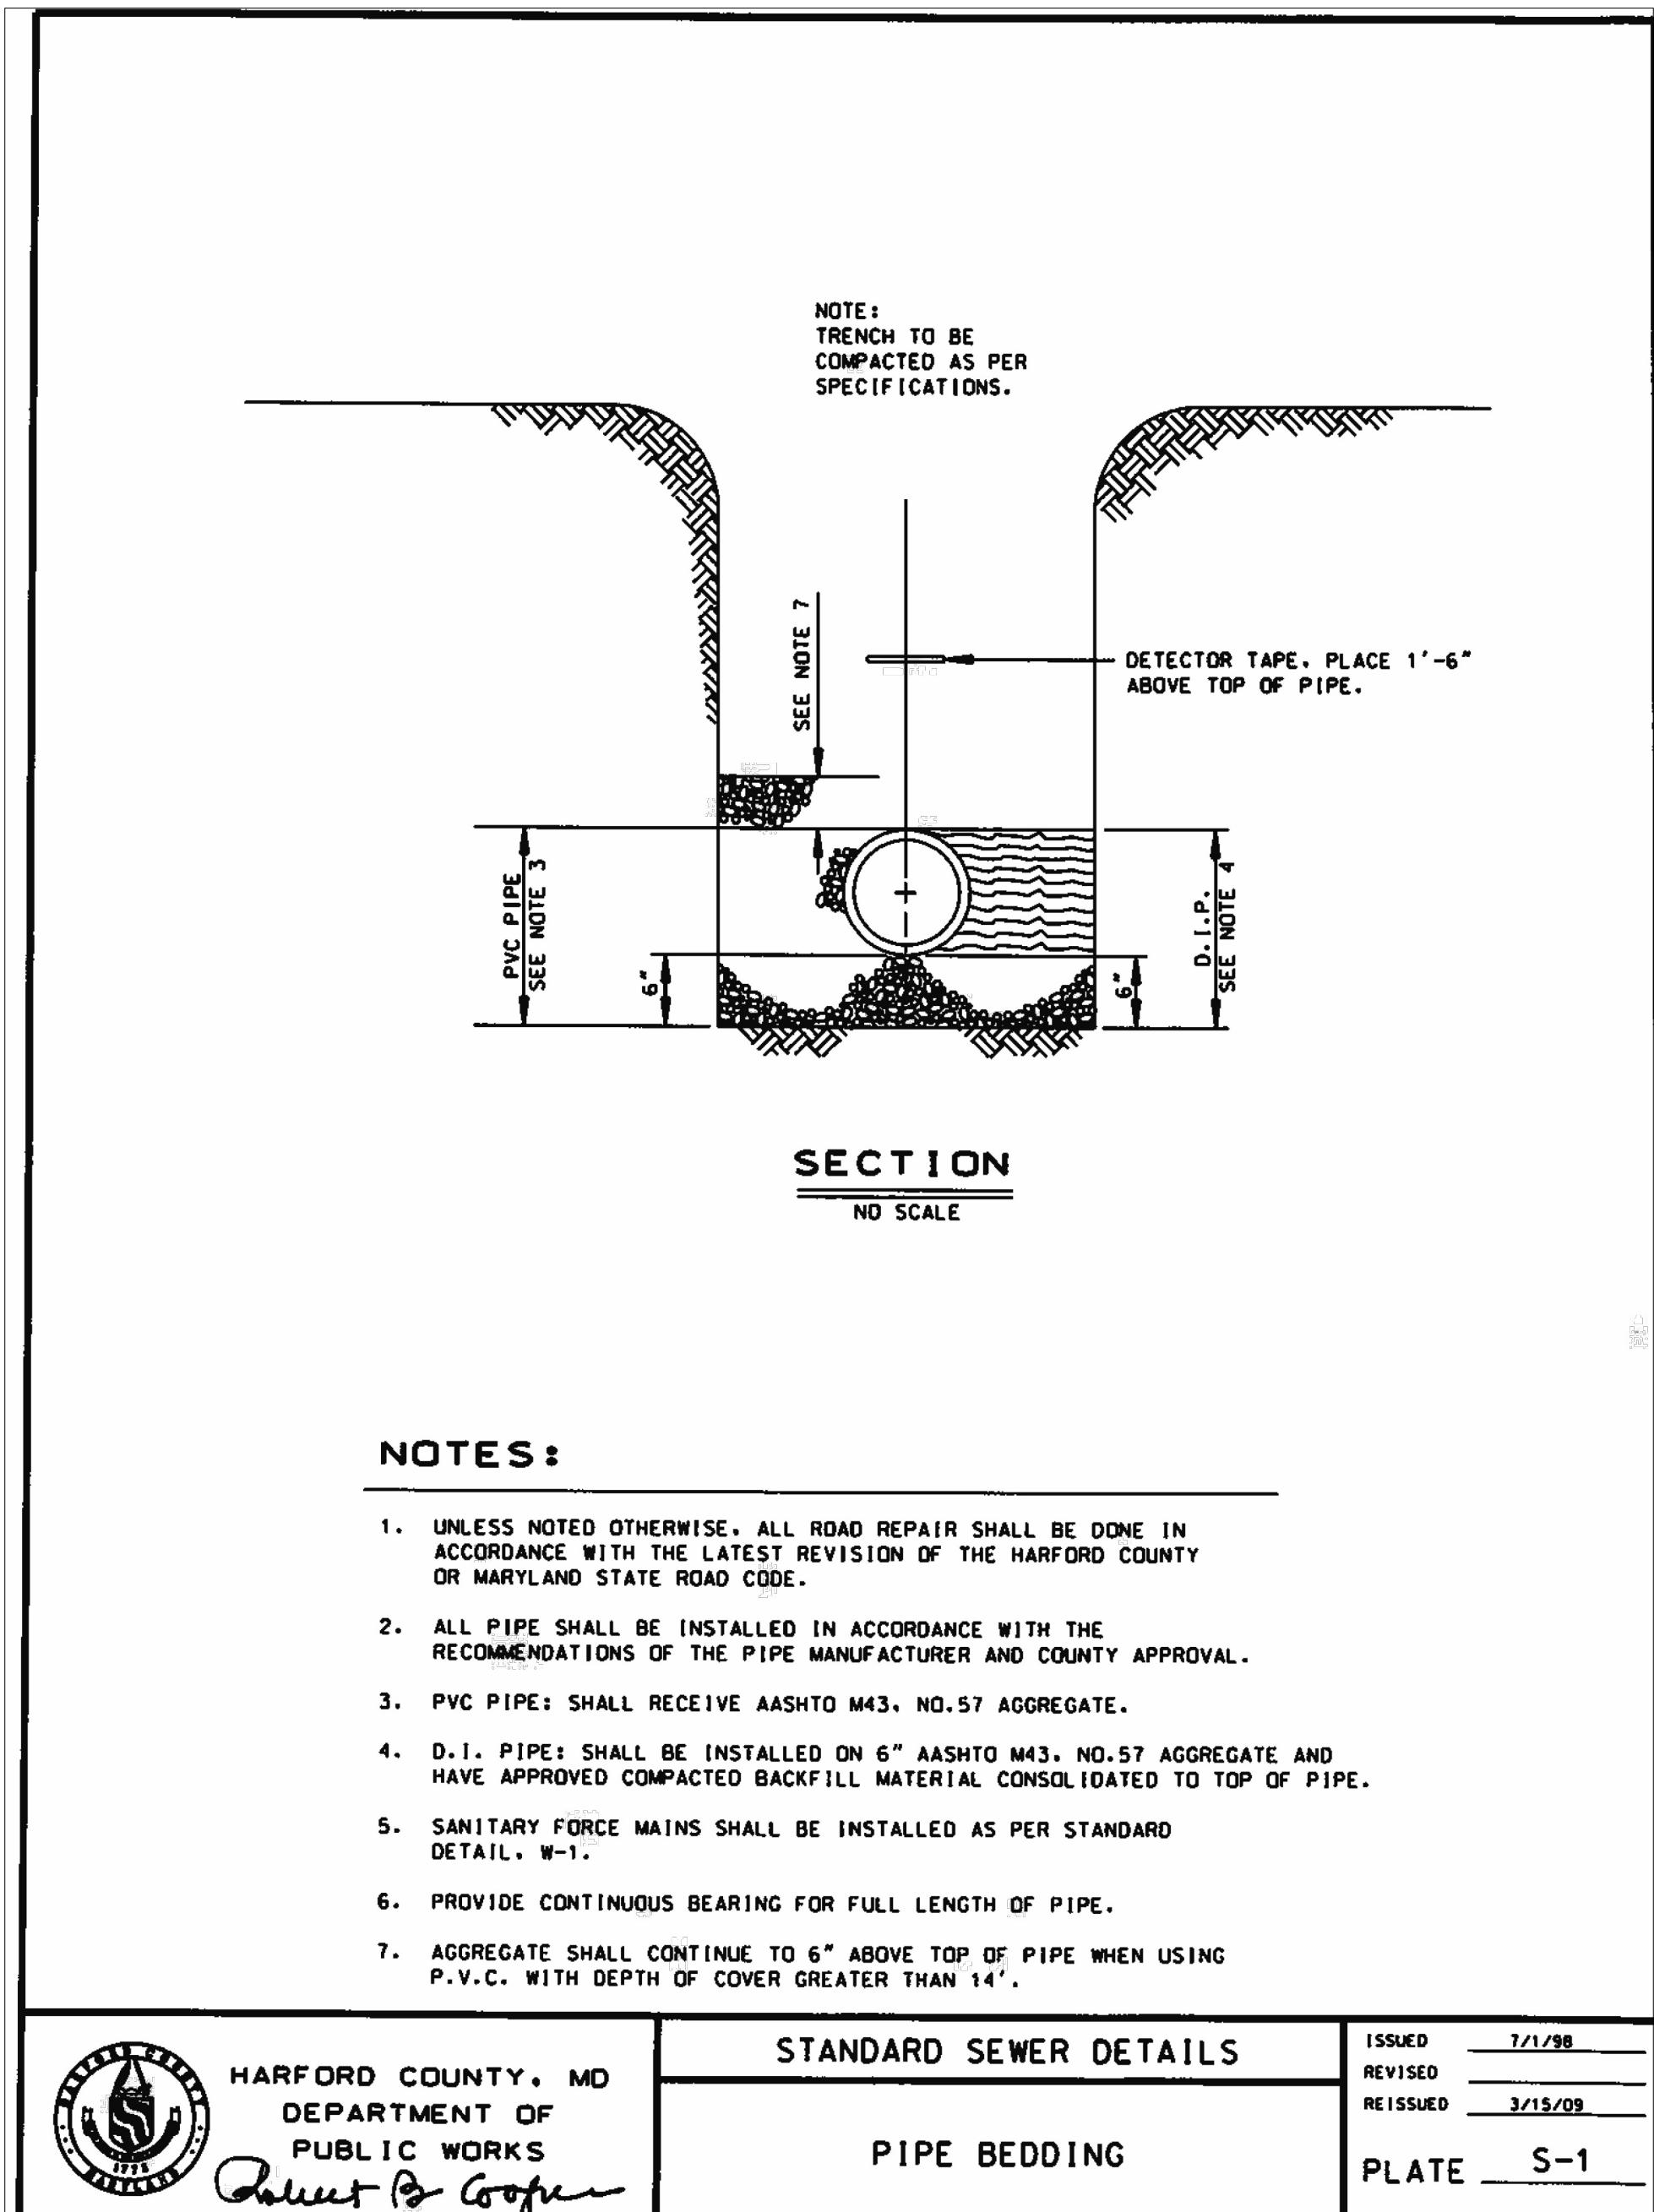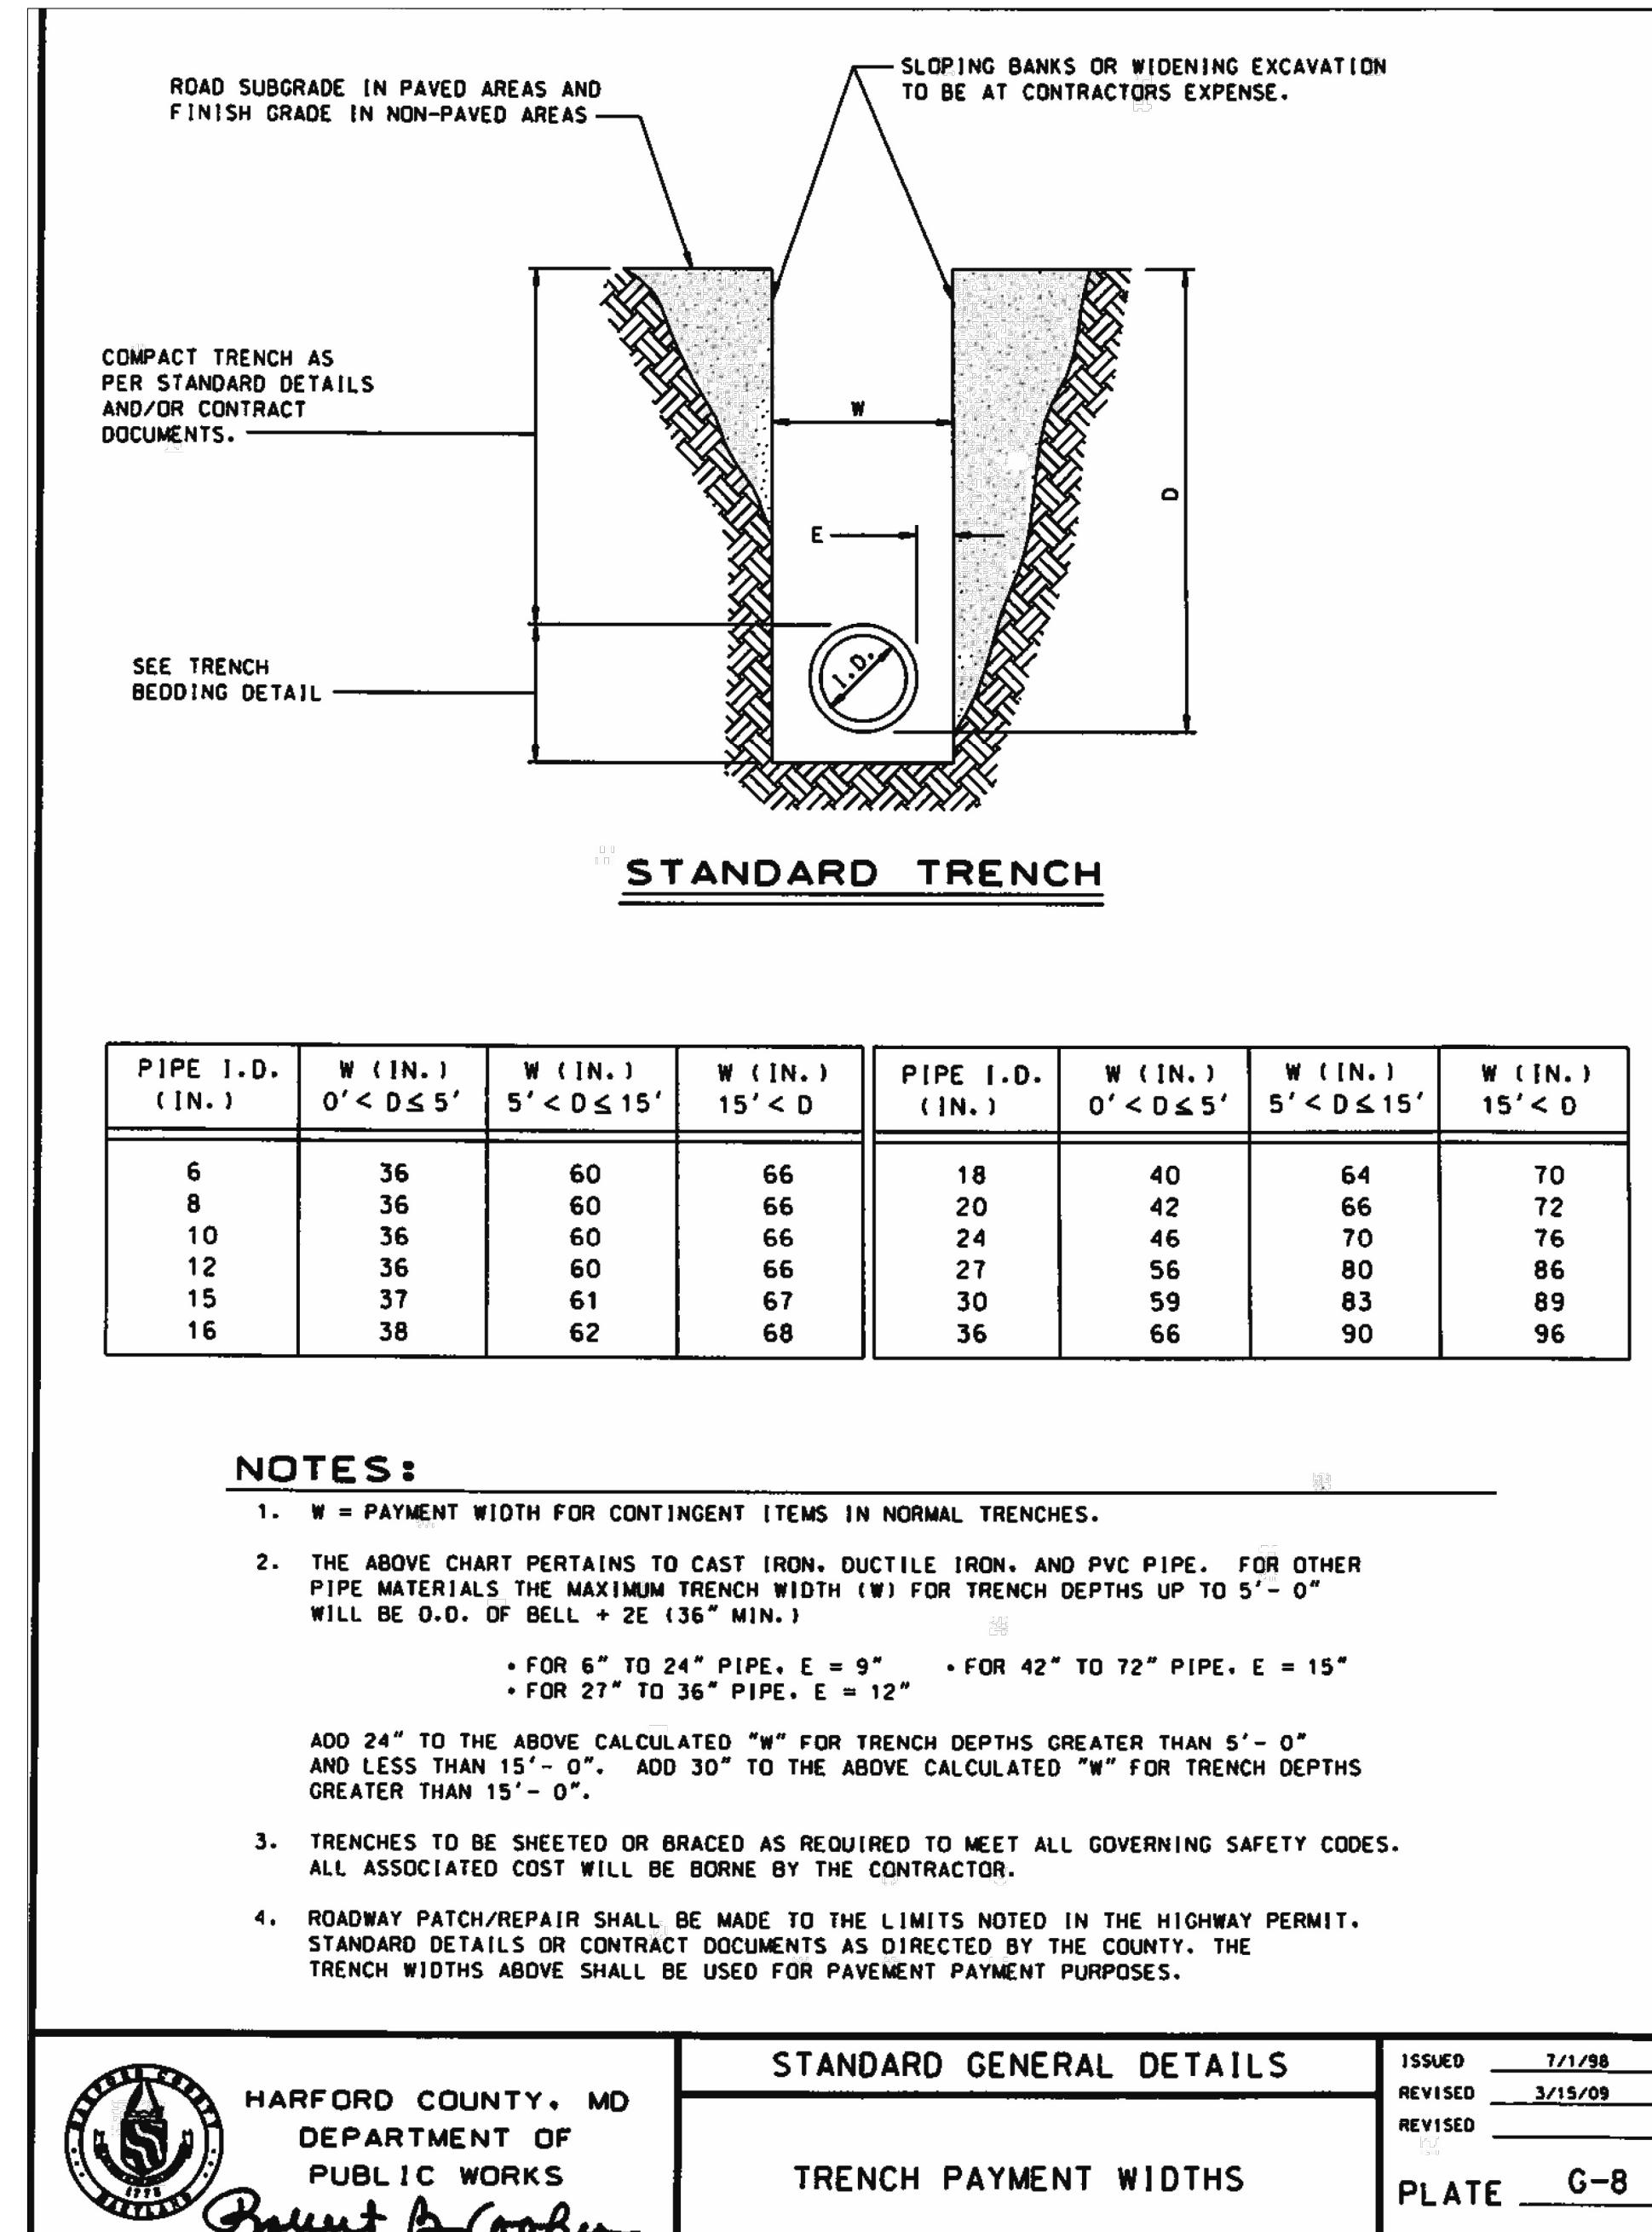


PIPE TRENCH
1
SS-09
NOT TO SCALE

PIPE BEDDING
2
SS-09
NOT TO SCALE


48-INCH PRECAST MANHOLE
3
SS-09
NOT TO SCALE

S/C PLAN # XXXXX	Revisions
GP # XXXXX-XXXX	SIGN AND SEAL
CONTRACT NO. 2792A	
PROFESSIONAL CERTIFICATION	
I HEREBY CERTIFY THAT THESE DOCUMENTS WERE PREPARED OR APPROVED BY ME, AND THAT I AM A DULY LICENSED PROFESSIONAL ENGINEER UNDER THE LAWS OF THE STATE OF MARYLAND LICENSE NO. XXXXX, EXPIRATION DATE: XX/XX/XXXX.	
Drawn By : _____	LW
Designed By : _____	LW
Reviewed By : _____	NK
Drawing No. SS-09 OF SS-11	Sheet No. 63 of 65

HARFORD COUNTY, MARYLAND
EDGEWATER VILLAGE PARK
SEWER REPLACEMENT
SEWER DETAILS
NTS
SEPTEMBER 2025

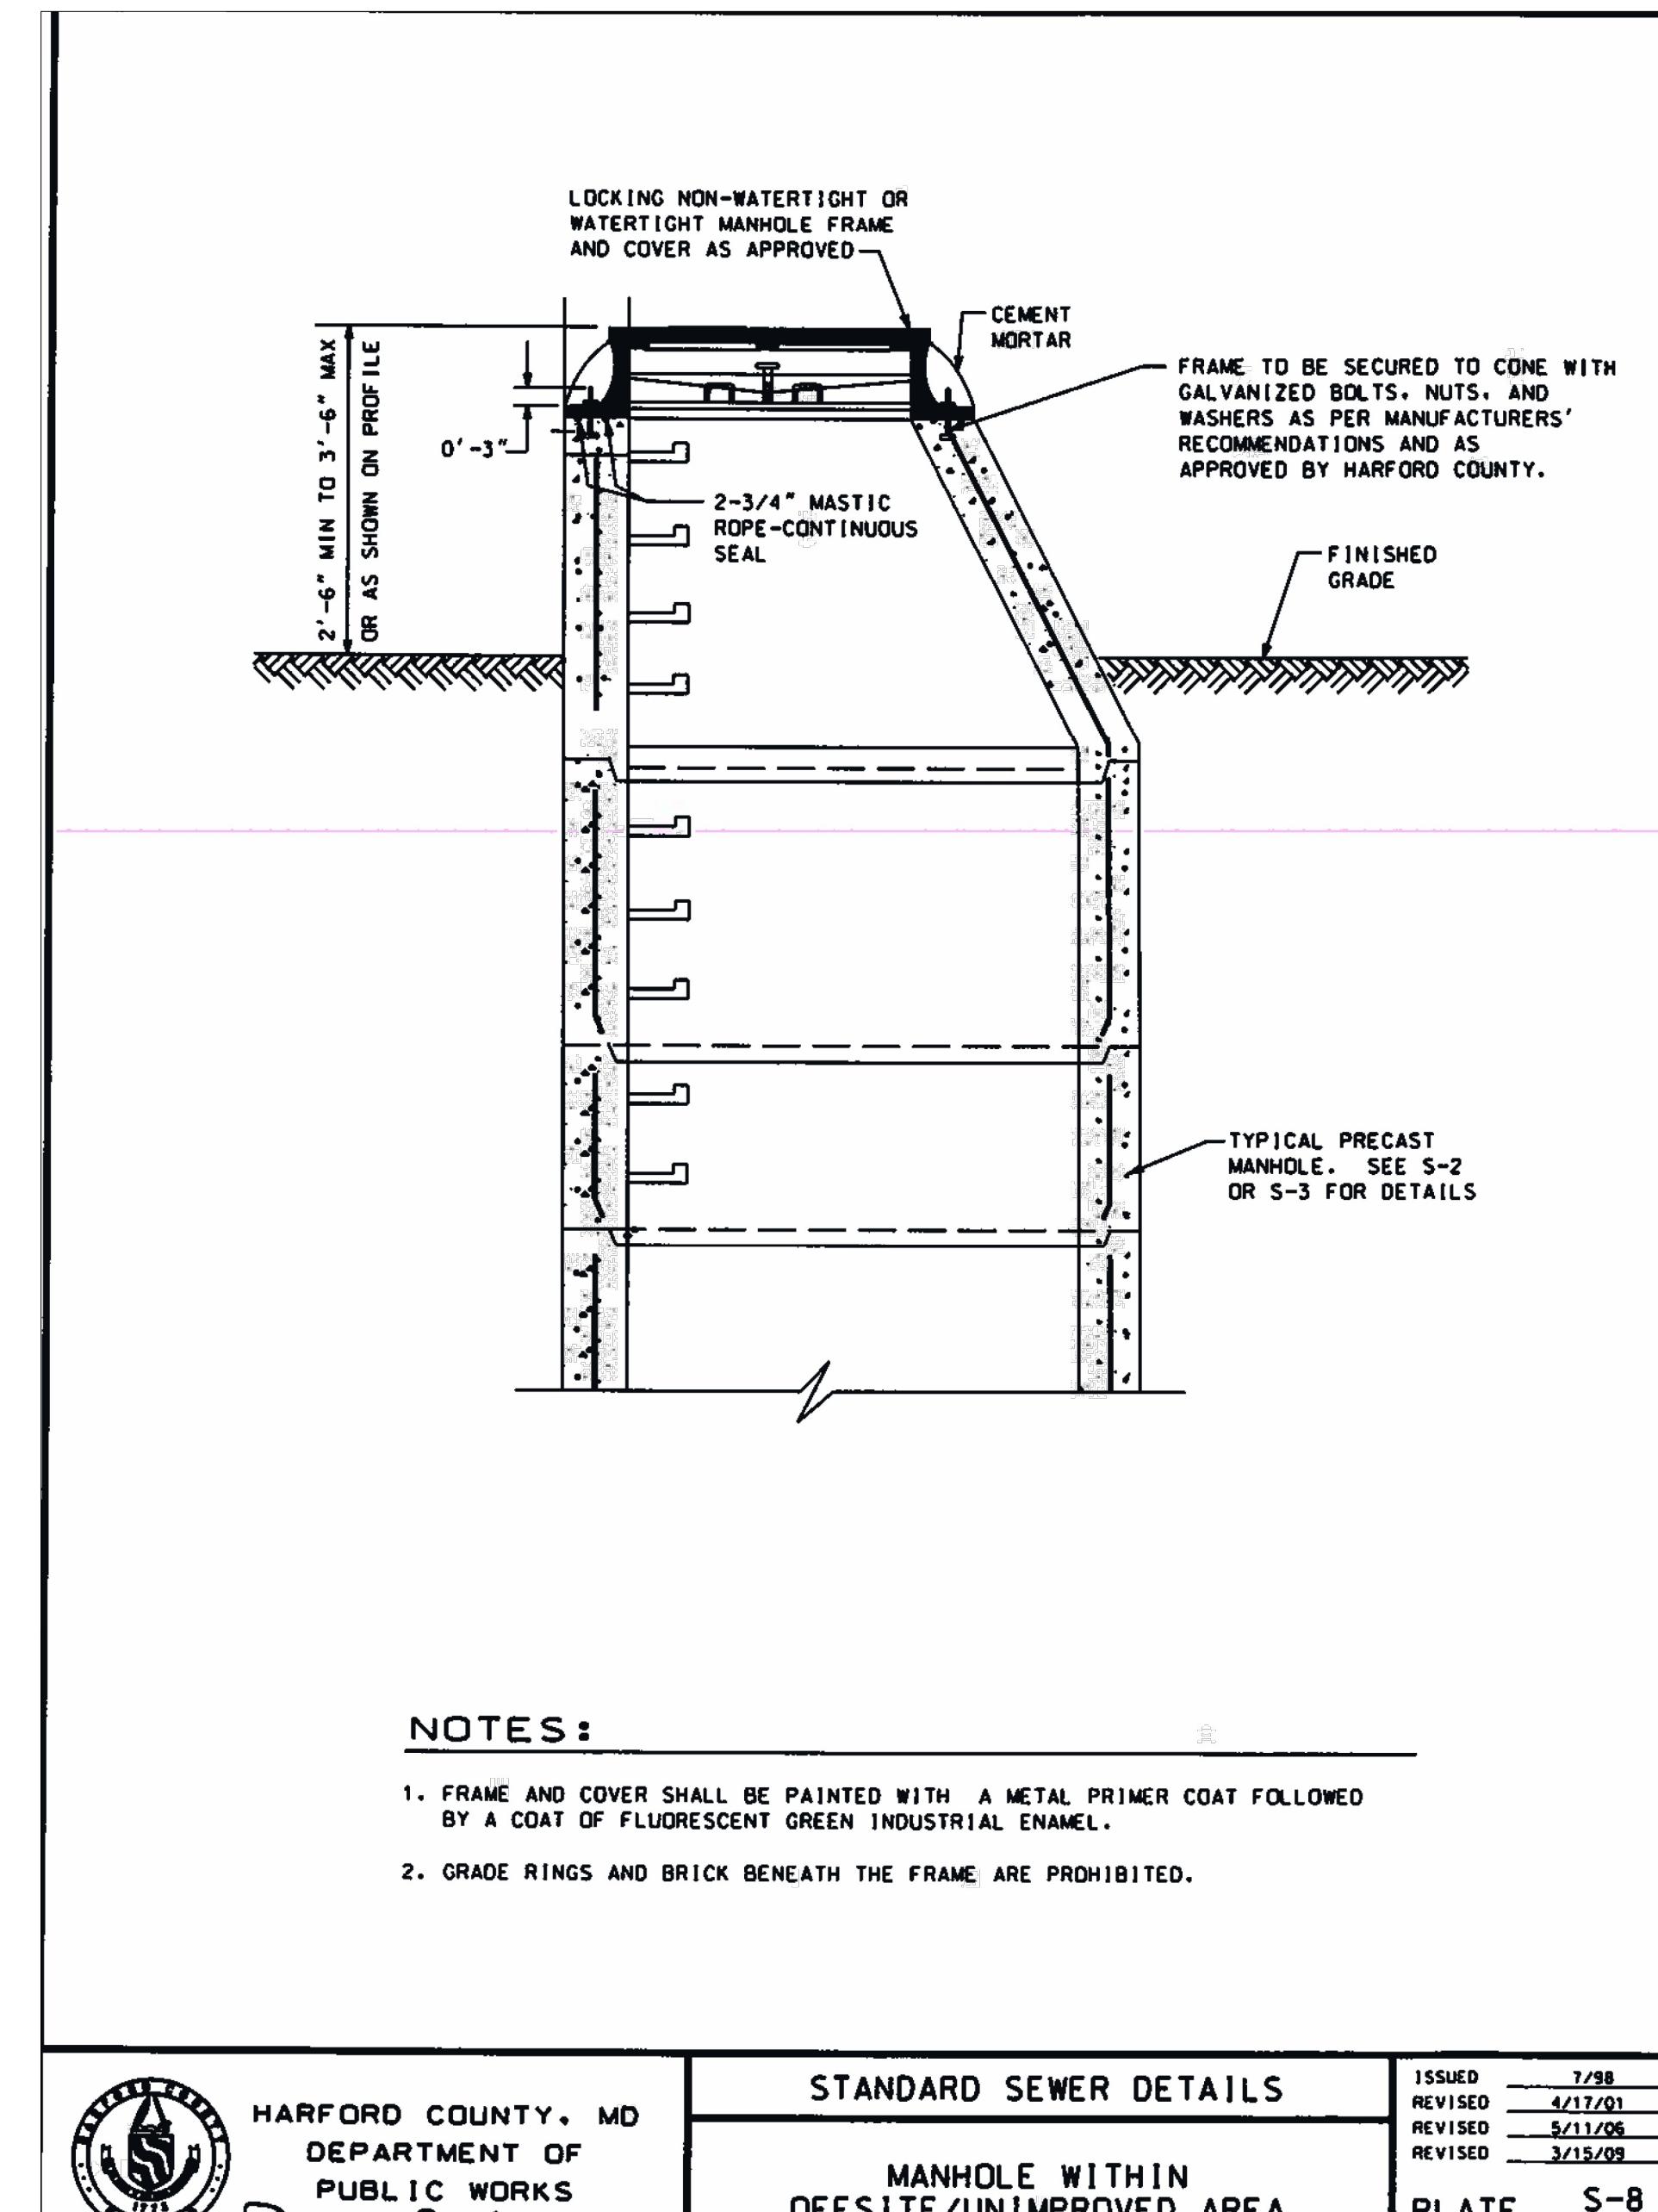


1
SS-10
NOT TO SCALE
MANHOLE WITHIN OFFSITE/UNIMPROVED AREA

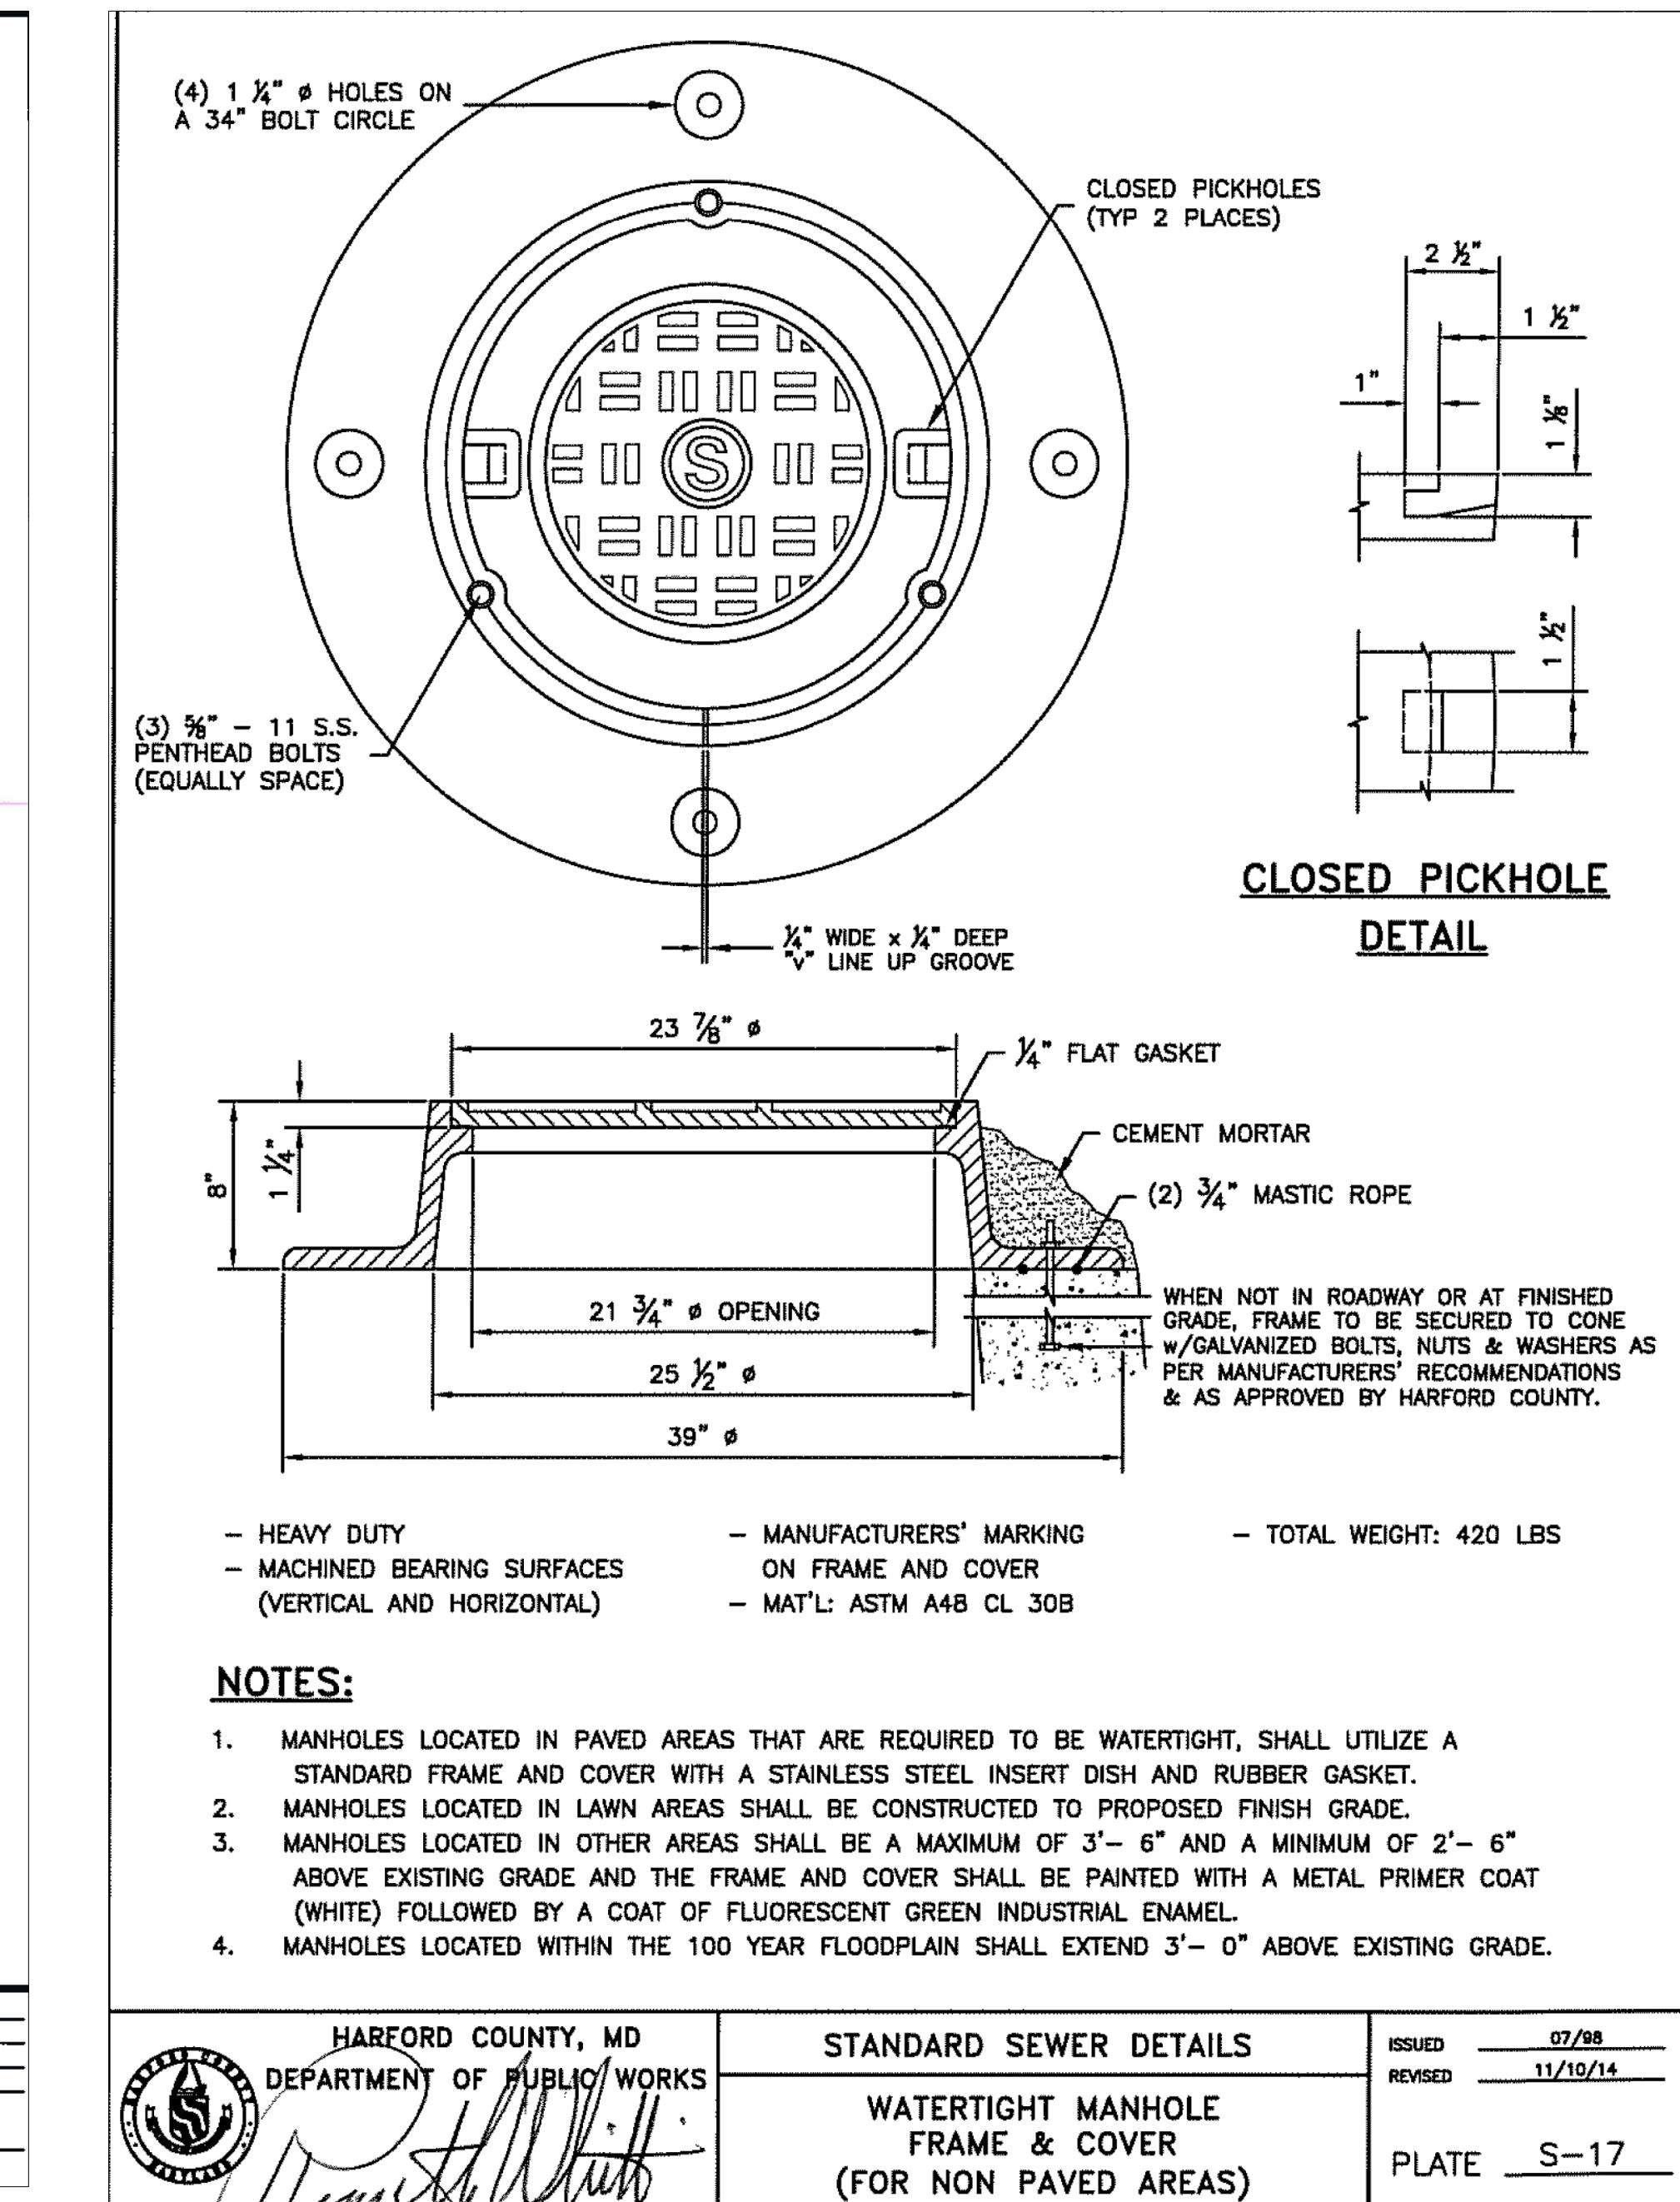


2
SS-10
NOT TO SCALE
WATERTIGHT FRAME AND COVER

CONTRACT NO. 2792A
PROFESSIONAL CERTIFICATION
I HEREBY CERTIFY THAT THESE DOCUMENTS WERE PREPARED OR APPROVED BY ME,
AND THAT I AM A DULY LICENSED PROFESSIONAL ENGINEER UNDER THE LAWS OF
THE STATE OF MARYLAND LICENSE NO. XXXXX, EXPIRATION DATE: XX/XX/XXXX.

S/C PLAN # XXXXX	Revisions	HARFORD COUNTY, MARYLAND	
GP # XXXXX-XXXX	EDGEWATER VILLAGE PARK SEWER REPLACEMENT SEWER DETAILS		Scale : <u>NTS</u> Date : <u>SEPTEMBER 2025</u>
Drawn By : <u>LW</u> Designed By : <u>LW</u> Reviewed By : <u>NK</u>			
	Drawing No. <u>SS-10 OF SS-11</u>	Sheet No.	64 of 65
SIGN AND SEAL			

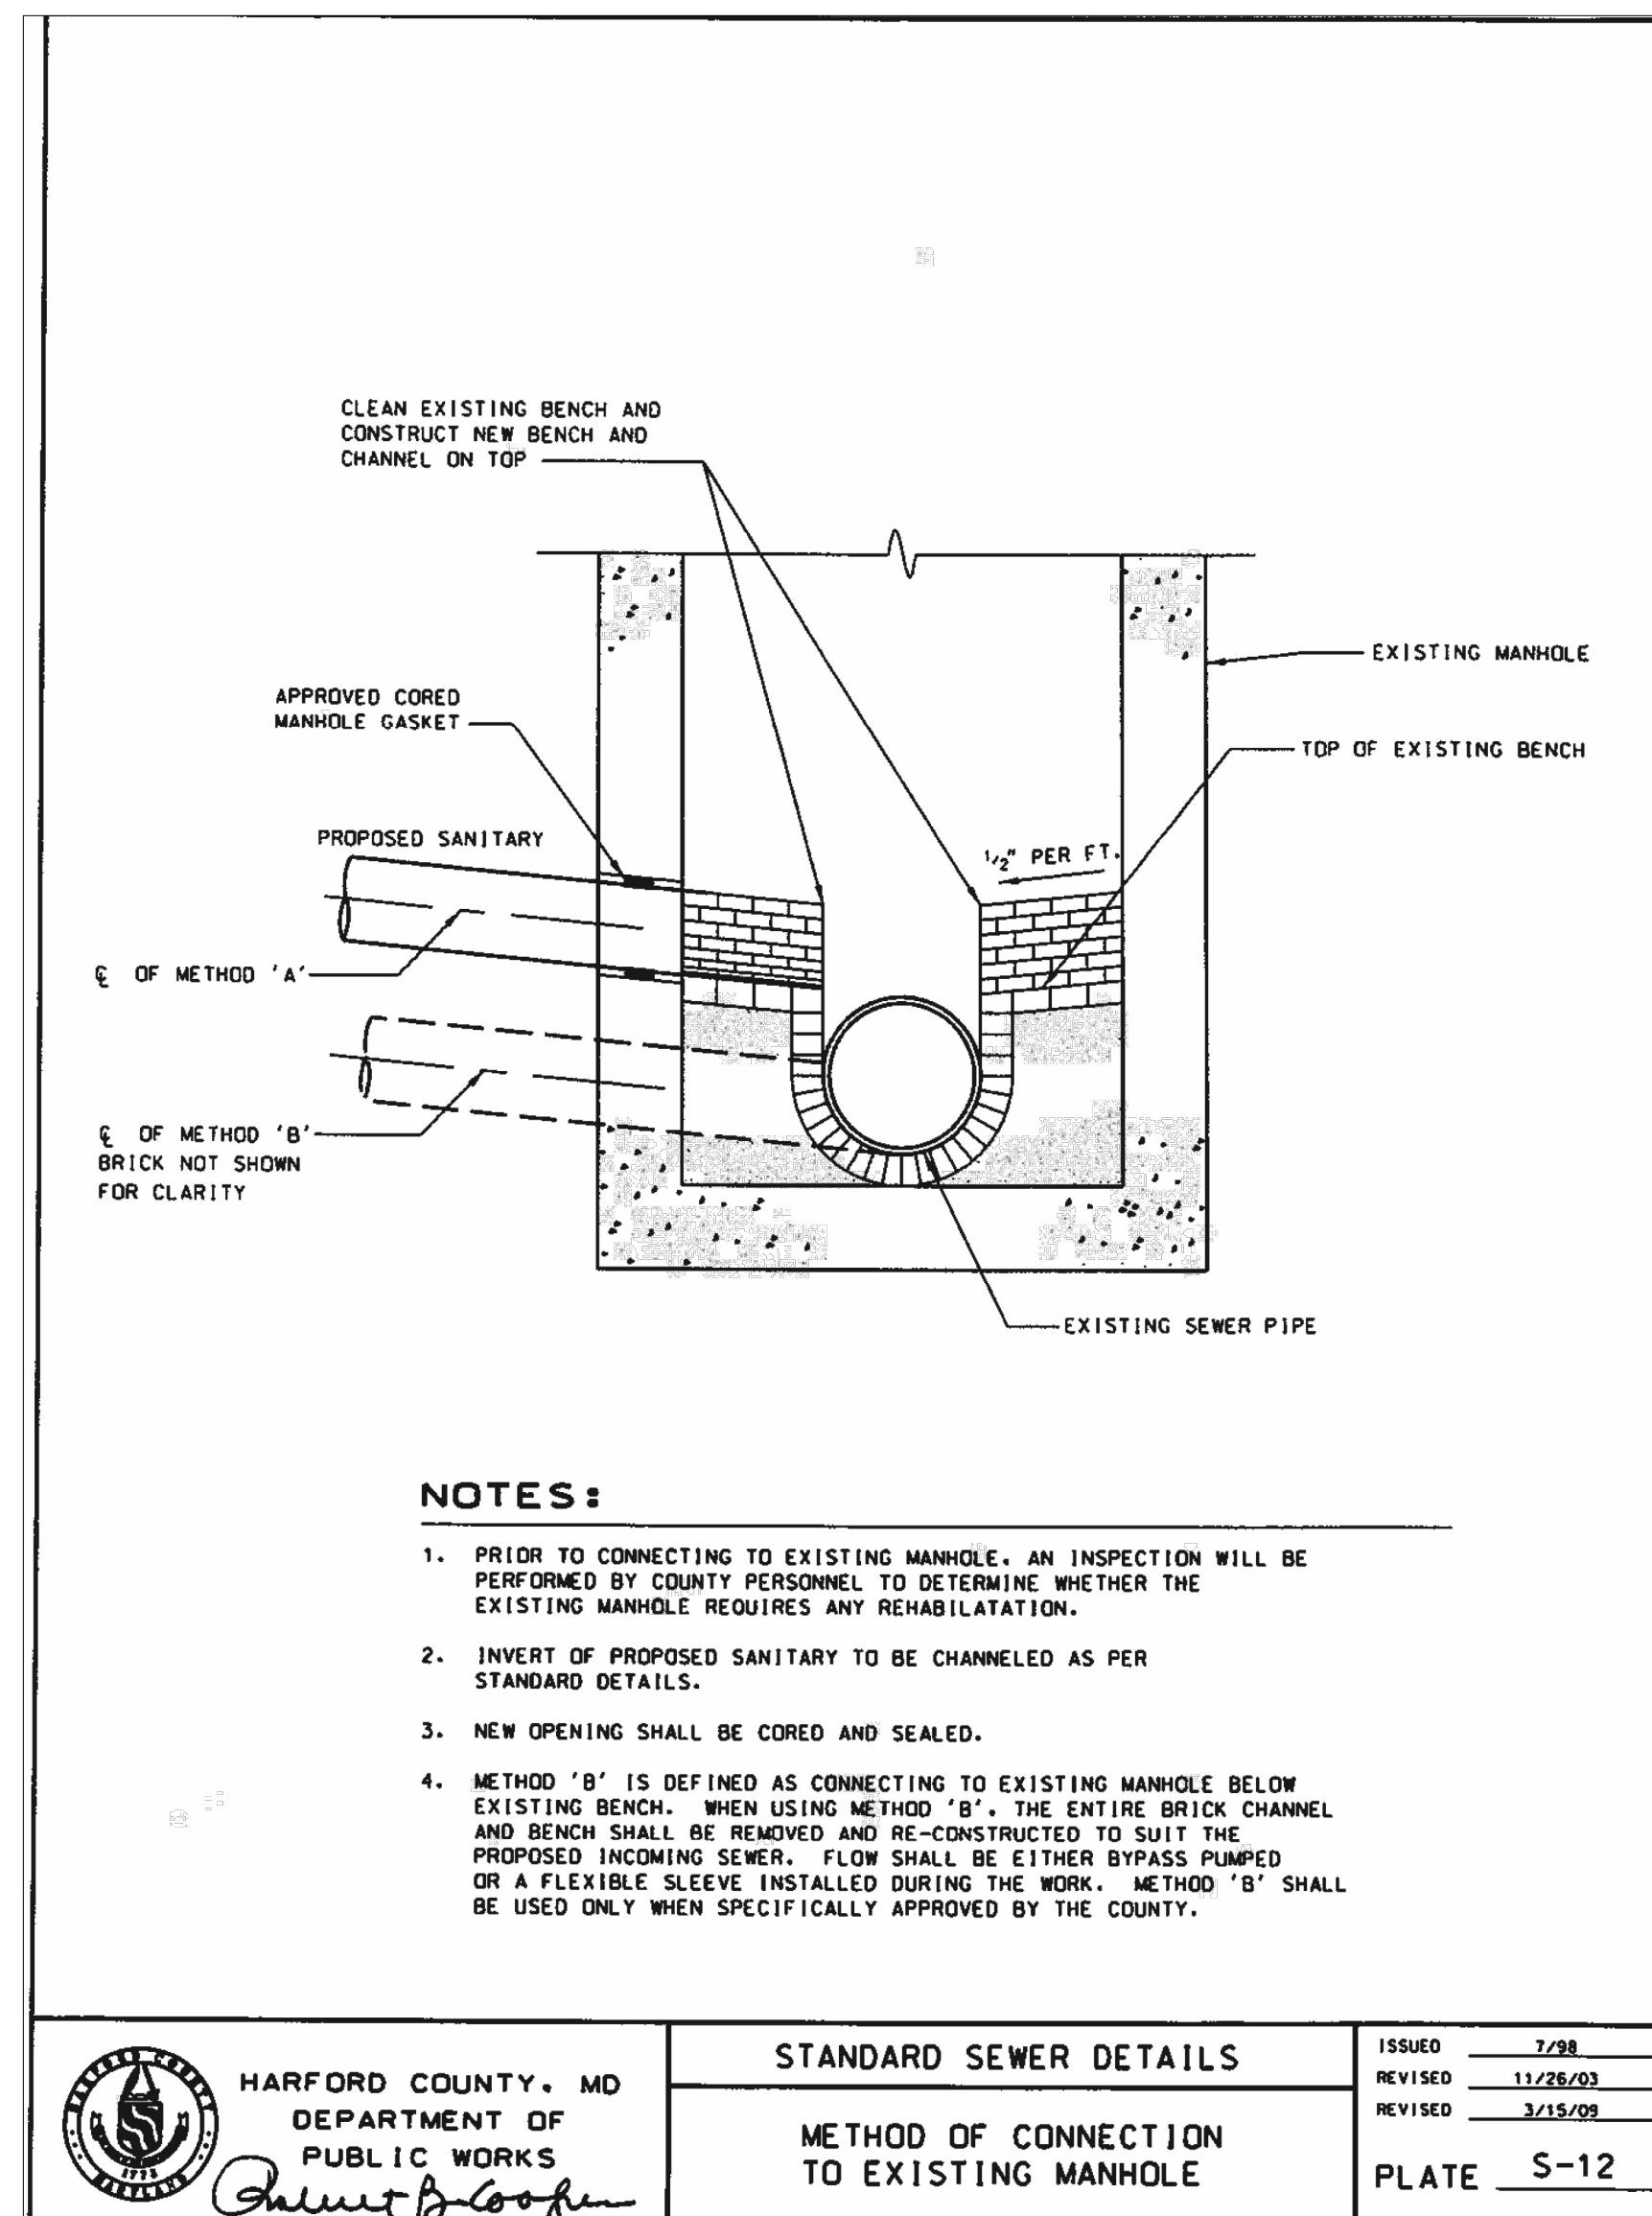

1 CONNECTION TO EXISTING MANHOLE
SS-11 NOT TO SCALE

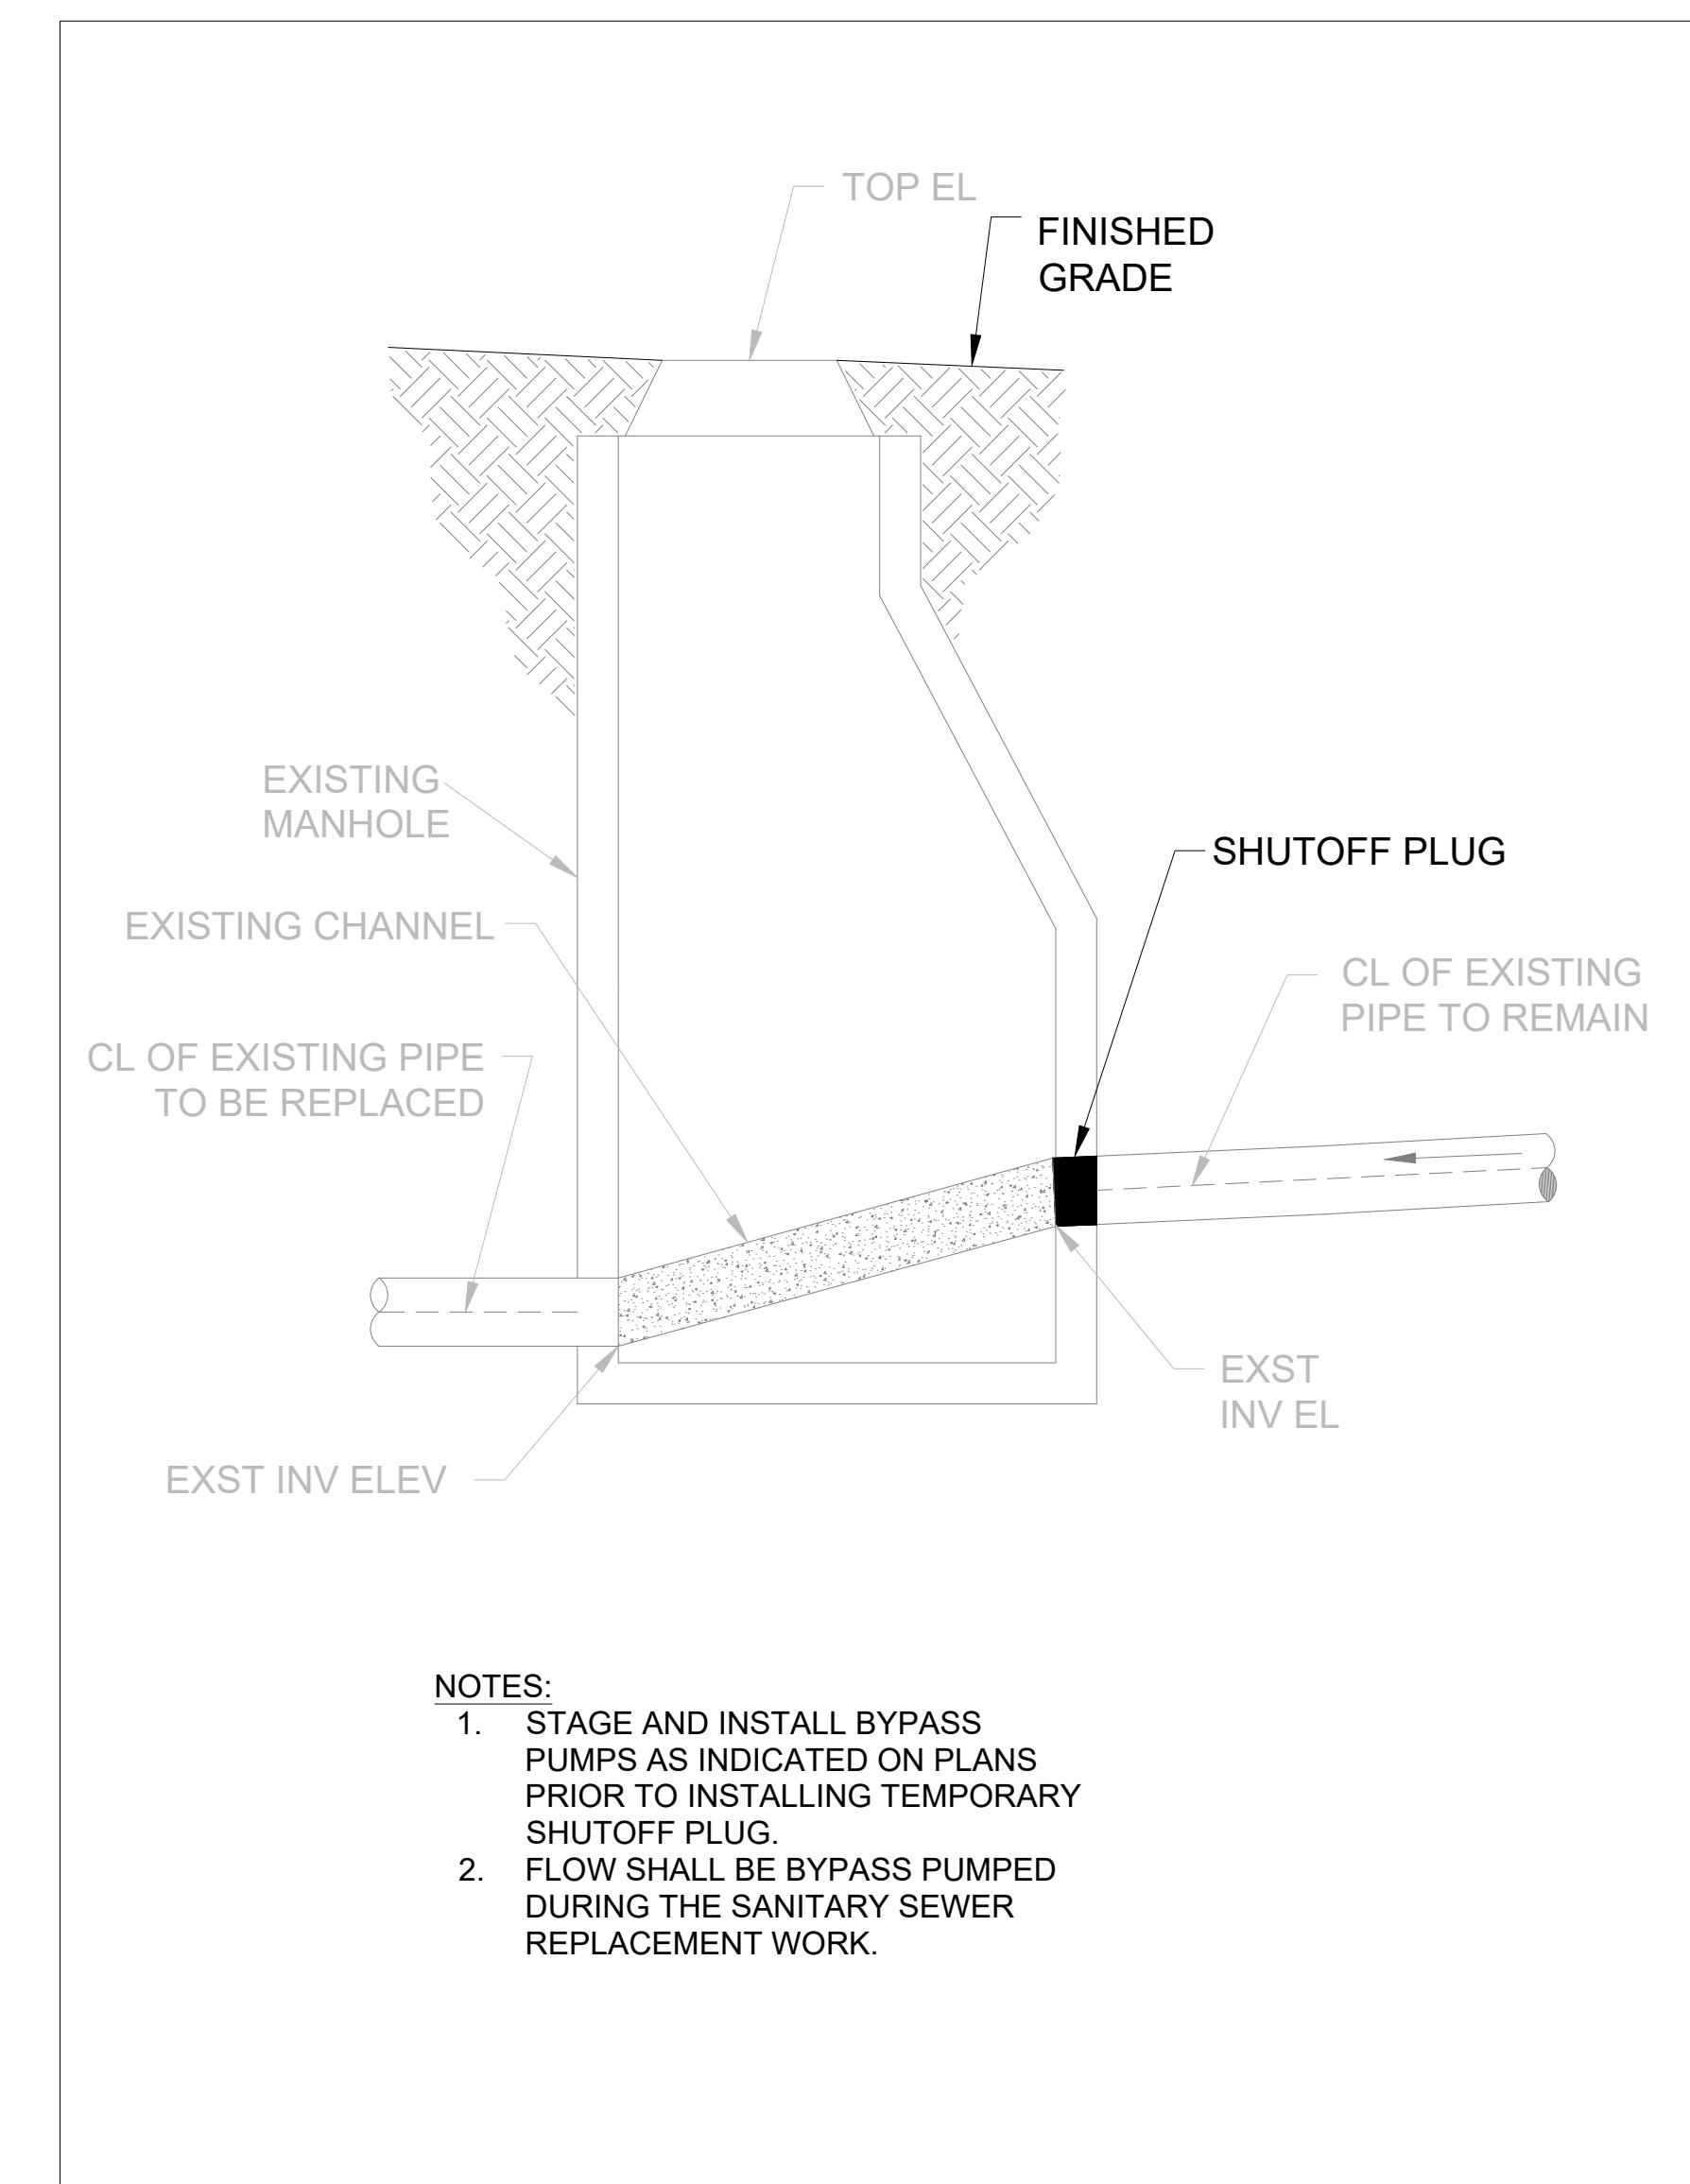

2 SEWER BYPASS PLUG
SS-11 NOT TO SCALE

HARFORD COUNTY, MARYLAND		EDGEWATER VILLAGE PARK SEWER REPLACEMENT SEWER DETAILS	
S/C PLAN # XXXXX GP # XXXXX-XXXX SIGN AND SEAL		Revisions Drawn By : LW Designed By : LW Reviewed By : NK Drawing No. SS-11 OF SS-11 Sheet No. 65 of 65	
CONTRACT NO. 2792A PROFESSIONAL CERTIFICATION I HEREBY CERTIFY THAT THESE DOCUMENTS WERE PREPARED OR APPROVED BY ME, AND THAT I AM A DULY LICENSED PROFESSIONAL ENGINEER UNDER THE LAWS OF THE STATE OF MARYLAND. LICENSE NO. XXXXX, EXPIRATION DATE: XX/XX/XXXX.		Scale : NTS Date : SEPTEMBER 2025	